

GENERAL NOTES

- ASSESSOR'S PARCEL NUMBER (APN): 327-320-019-5.
- THE PROPERTY SHOWN HEREON DOES NOT CONTAIN THE ENTIRE CONTIGUOUS OWNER.
- TOTAL APPROXIMATE PROJECT AREA: 5.04 AC. GROSS, 3.62 AC. NET
- TOTAL APPROXIMATE AREA TO BE DEDICATED FOR RIGHT OF WAY: 1.40 AC.
- TOTAL APPROXIMATE AREA OF DEVELOPMENT AREA: 5.68 AC
- PROPOSED SCHEDULE "E" SUBDIVISION.
- ALL COMMERCIAL AREAS, LANDSCAPED AREAS, AND POST CONSTRUCTION BMPs SHALL BE MAINTAINED BY MERCHANT/OWNER ASSOCIATION, EXCEPT WHERE NOTED.
- THE ENTIRE PROJECT SHALL BE MAINTAINED WITH AN AUTOMATIC IRRIGATION SYSTEM MAINTAINED BY MERCHANT/OWNER ASSOCIATION.
- ALL DIMENSIONS ARE TO FACE OF BUILDING WALLS AND CONCRETE CURB FACE.
- CONTOUR INTERVAL = 1 FOOT.
- NO REGULATED TREES EXIST ON SITE, UNLESS NOTED.
- THE LOCATIONS OF ALL EXISTING UTILITIES SHOWN ON THIS MAP ARE APPROXIMATE.
- SOURCE OF TOPOGRAPHY: INLAND AERIAL SURVEYS, INC., 7117 ARLINGTON AVENUE SUITE A, RIVERSIDE, CA 92503. PERFORMED ON DECEMBER 30, 2004.
- THIS PROJECT IS WITHIN MENEFEE NORTH SPECIFIC PLAN # 260 AMENDMENT # 2.
- THIS PROJECT IS WITHIN L&LMD NO. 89-1-C.
- THIS PROJECT IS NOT LOCATED IN A SPECIAL STUDIES ZONE.
- THIS PROPERTY IS NOT SUBJECT TO LIQUEFACTION OR OTHER GEOLOGIC HAZARDS AND IS NOT LOCATED IN A SPECIAL STUDIES ZONE.
- THIS PROPERTY IS NOT SUBJECT TO OVERFLOW, INUNDATION OR OTHER FLOOD HAZARDS.
- PROPOSED WASTE DISPOSAL SYSTEM: EMD AND DUMPSTERS FOR SOLID WASTE.
- ALL BUILDINGS PROPOSED BY THE PROJECT WILL BE ERCTED IN CONFORMANCE WITH THE UNIFORM BUILDING CODE OCCUPANCY GROUP AND CONSTRUCTION TYPE FOR COMMERCIAL CONSTRUCTION.
- PROJECT IS LOCATED ON PAGE 838, H-1, J-1 OF THOMAS BROTHERS (RIVERSIDE COUNTY, 2005 EDITION).
- THERE ARE NO KNOWN EXISTING WELLS ON THE PROPERTY OR WITHIN 200' OF THE PROPERTY BOUNDARY.
- THIS PROJECT WILL NOT IMPLEMENT THE USE OF A SEPTIC SYSTEM.

LEGAL DESCRIPTION

PARCEL "C" OF NOTICE OF LOT LINE ADJUSTMENT RECORDED JULY 19, 2018 AS INSTRUMENT NO. 2018-0291969 OF OFFICIAL RECORDS, BEING ALL OF LOT 268-B AND A PORTION OF LOTS 269 OF ROMOLA FARMS NO. 5 IN THE COUNTY OF RIVERSIDE, STATE OF CALIFORNIA, AS SHOWN BY MAP ON FILE IN BOOK 14, PAGES 44 AND 45 OF MAPS, RIVERSIDE COUNTY RECORDS.

EXCEPTING FROM LOT 268-B THAT PORTION CONVEYED TO THE COUNTY OF RIVERSIDE BY DEED RECORDED SEPTEMBER 28, 1966 AS INSTRUMENT NO. 96186 OF OFFICIAL RECORDS.

ALSO EXCEPTING FROM LOT 268-B THAT PORTION CONVEYED TO THE COUNTY OF RIVERSIDE BY DEED RECORDED JUNE 22, 1994 AS INSTRUMENT NO. 94-253036, OF OFFICIAL RECORDS.

WATER QUALITY

A COMPLETE WATER QUALITY MANAGEMENT PLAN (WQMP) IS BEING PROVIDED WITH THE PROJECT SPECIFIC WQMP. THE PLAN IDENTIFIES THE FOLLOWING:

- POTENTIAL POST-PROJECT POLLUTANTS AND HYDROLOGICAL IMPACTS ASSOCIATED WITH THE DEVELOPMENT.
- PROPOSED MITIGATION MEASURES (BEST MANAGEMENT PRACTICES - BMP'S) FOR TREATMENT OF IDENTIFIED IMPACTS INCLUDING SITE DESIGN, SOURCE CONTROL, AND TREATMENT CONTROL POST-PROJECT BMP'S.
- SUSTAINABLE FUNDING AND MAINTENANCE MECHANISMS FOR THE AFOREMENTIONED BEST MANAGEMENT PRACTICES - BMP'S. A MAINTENANCE AGREEMENT TO BE APPROVED BY CITY COUNCIL WILL BE REQUIRED PRIOR TO ISSUANCE OF GRADING PERMIT.

CITY OF MENEFEE, COUNTY OF RIVERSIDE, STATE OF CALIFORNIA.

CONDITIONAL USE PERMIT NO. 2017-226 HARVEST GLEN

FLOOD ZONING

THIS AREA IS NOT WITHIN A FLOOD HAZARD AREA. THE AREA IS CONSIDERED A ZONE X (UNSHADED) FLOOD HAZARD WHICH IS OUTSIDE OF THE 100-YEAR FLOOD LIMITS.

EARTHWORK QUANTITIES

CUT: 7,400 CY
FILL: 2,200 CY
NET: 5,200 CY (EXPORT)

NOTES:

- IMPORT/EXPORT REQUIRES CITY APPROVED HAUL PERMIT.
- EARTHWORK QUANTITIES ARE UNADJUSTED OR "RAW" AND THEREFORE DO NOT CONSIDER SOIL FACTORS SUCH AS SHRINKAGE AND SUBSIDENCE.

PARKING SUMMARY

| LOCATION | COMMERCIAL TYPE | DESCRIPTION | SPACE | NO. OF EMPLOYEES | REQUIRED SPACES | REQUIRED HANDICAP SPACES |
|------------------|-----------------|---|-------|------------------|-----------------|--------------------------|
| PARCEL 1 | FAST FOOD | 1 SPACE/45 SF OF SERVING AREA, PLUS 1 SPACE/2 EMPLOYEES | 1,270 | 6 | 32 | 2 |
| PARCEL 2 | CAR WASH | 1 SPACE/3 EMPLOYEES | N/A | 6 | 2 | 1 |
| PARCEL 3 | QSR | 1 SPACE/45 SF OF SERVING AREA, PLUS 1 SPACE/2 EMPLOYEES | 425 | 4 | 12 | |
| | C-STORE | 1 SPACE/200 SF | 4,967 | 2 | 25 | 1 |
| TOTAL: | | | | | 71 | 4 |
| SPACES PROVIDED: | | | | | 73 | 5 |


PER THE 2016 CALIFORNIA GREEN BUILDING CODE TABLE 5.106.2, A TOTAL OF SIX (6) STALLS ARE REQUIRED FOR CLEAN AIR VEHICLES, PER TABLE 5.106.5.3, FOUR (4) STALLS ARE REQUIRED TO HAVE FUTURE ELECTRIC VEHICLE CHARGING STATIONS

ZONING AND LAND USE SUMMARY

| DESCRIPTION | ON-SITE | NORTH | SOUTH | EAST | WEST |
|-------------------|-------------------------------|--|---------------------------------|--|--|
| GENERAL PLAN | CR | MDR | CR | OS-R, CR | MDR, BP |
| EXISTING ZONING | SP-260 PA 44 COMMERCIAL | SP-260 PA 23A HIGH DENSITY RES | SP-301 PA 2 & 9 | SP-260 PA 26 HIGH DENSITY RES PA 27 COMMERCIAL | SP-260 PA 19 COMMERCIAL/ BUSINESS PARK |
| PROPOSED ZONING | SP-260 PA 44 COMMERCIAL | SP-260 PA 23A MED HIGH DENSITY RES | SP-301 PA 2 & 9 | SP-260 PA 26 HIGH DENSITY RES PA 27 COMMERCIAL | SP-260 PA 19 COMMERCIAL/ BUSINESS PARK |
| EXISTING LAND USE | VACANT | VACANT/COMMUNITY PARK | HIGH SCHOOL | VACANT | VACANT |
| PROPOSED LAND USE | COMMERCIAL | HIGH DENSITY RES/ RECREATION | MED DENSITY RES/ HIGH SCHOOL | COMMERCIAL | COMMERCIAL/ BUSINESS PARK |

LEGEND

- EXIST. PROPERTY LINE
- EXIST. RIGHT OF WAY
- PROP. RIGHT OF WAY
- PROJECT BOUNDARY
- DEVELOPMENT BOUNDARY
- PROPERTY LINE
- EASEMENT
- BLOCK OR RETAINING WALL
- PROP. LANDSCAPE AREA
- CONCRETE PAVEMENT
- ACCENT PAVING
- STAMPED CONCRETE
- STREET LIGHT
- BICYCLE PARKING
- BUILDING COLUMN
- INGRESS/EGRESS
- TRASH ENCLOSURE
- CARWASH VACUUM
- WHEEL STOP

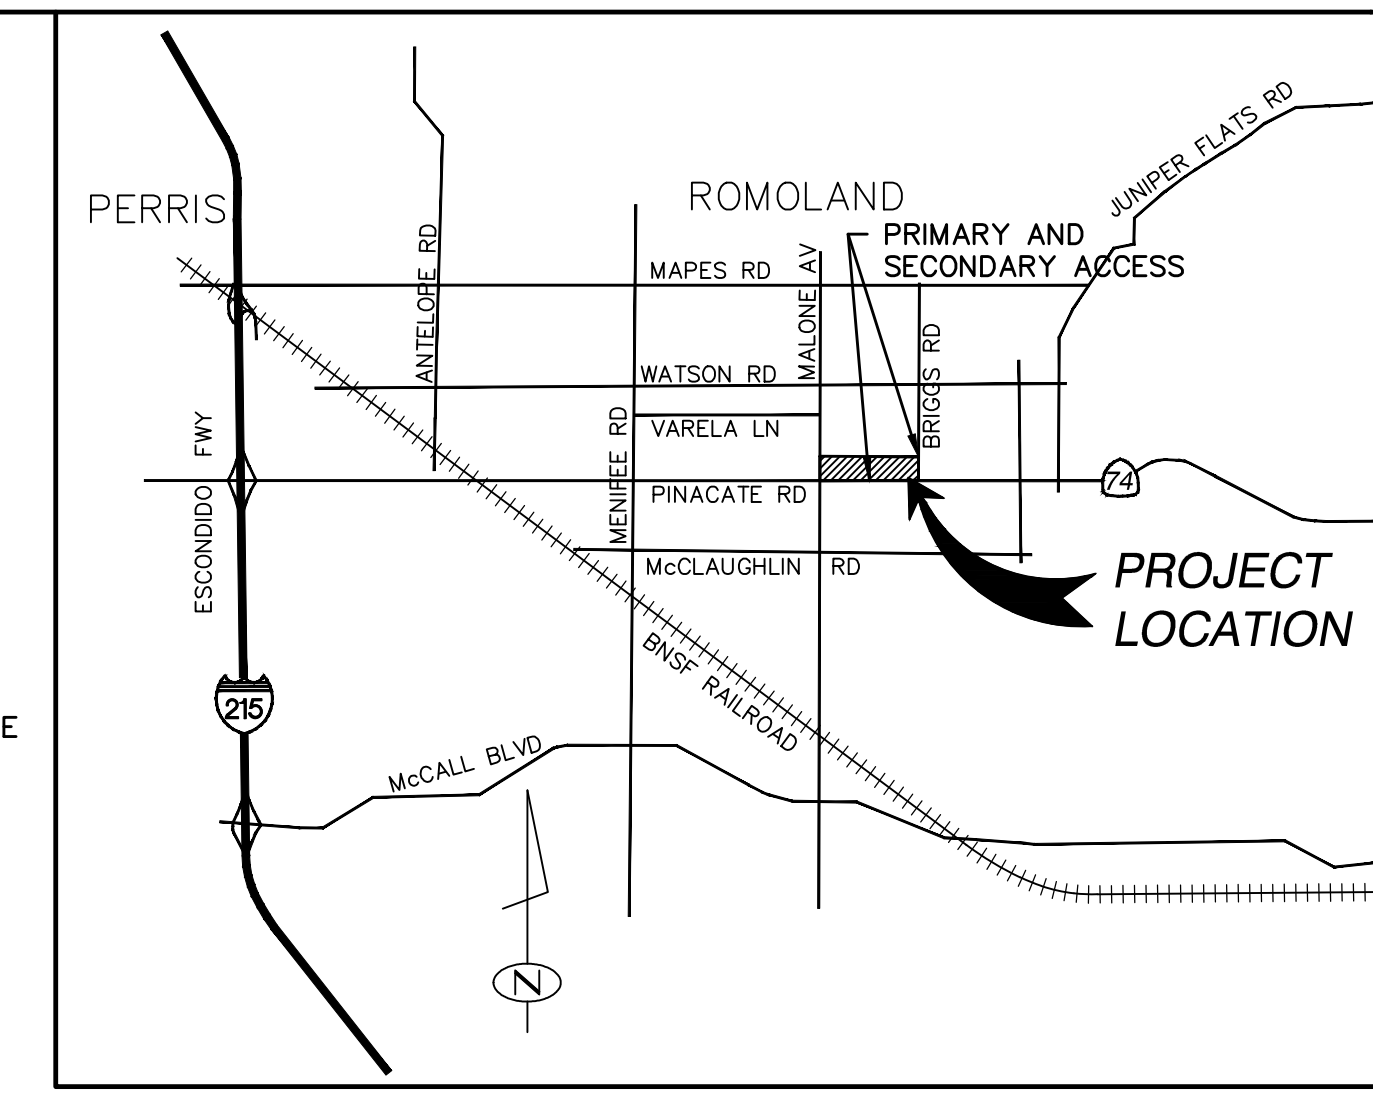

UTILITY PUREYORS

- WATER:** EASTERN MUNICIPAL WATER DISTRICT
2270 TRUMBULE ROAD
PERRIS, CA. 92572
(951) 928-3777
- SEWER:** EASTERN MUNICIPAL WATER DISTRICT
2270 TRUMBULE ROAD
PERRIS, CA. 92572
(951) 928-3777
- ELECTRIC:** SOUTHERN CALIFORNIA EDISON
6100 MENEFEE ROAD
ROMOLAND, CA 92585
(800) 655-4555
- NATURAL GAS:** SOUTHERN CALIFORNIA GAS COMPANY
527 NORTH SAN JACINTO STREET
HEMET, CA 92543
(800) 427-2200
- TELEPHONE:** VERIZON
30098 HAUN RD #320
MENEFEE, CA 92584
(951) 723-8452
- CABLE:** TIME WARNER CABLE
4077 W. STETSON AVENUE
HEMET, CA 92545
(888) 255-5789

SCHOOL DISTRICTS

- SCHOOL DISTRICT:** ROMOLAND SCHOOL DISTRICT (GRADES K-8)
25900 LEON ROAD
ROMOLAND, CA 92548
(951) 943-6369
- PERRIS UNION HIGH SCHOOL (GRADES 9-12)
155 EAST FOURTH STREET
PERRIS, CA 92570
(951) 943-6369

ABBREVIATIONS

| | | | |
|--------|----------------------------|---------|------------------------------|
| AC | ACRE | MHDR | MEDIUM HIGH DENSITY |
| AC | ASPHALT CONCRETE | MPD | RESIDENTIAL MULTIPLE PRODUCT |
| APN | ASSESSOR'S PARCEL NUMBER | MPD | DISPENSER |
| BP | BUSINESS PARK | OB | OBSCURED |
| BNDY | BOUNDARY | PL, P/L | PROPERTY LINE |
| C/L | CENTERLINE | PL | PARCEL MAP |
| C&G | CURB AND GUTTER | POC | POINT OF CONNECTION |
| CONC. | CONCRETE | PR | PROPOSED |
| CONST. | CONSTRUCT | PUE | PUBLIC UTILITY EASEMENT |
| CR | COMMERCIAL RETAIL | QSR | QUICK SERVE RESTAURANT |
| CAV | CLEAN AIR VEHICLE PARKING | R-R | RURAL-RESIDENTIAL |
| CY | CUBIC YARD | R/W | RIGHT OF WAY |
| DG | DECOMPOSED GRANITE | RS | RECORD OF SURVEY |
| ESMT. | EASEMENT | SF | SQUARE FOOTAGE |
| EP | EDGE OF PAVEMENT | SS, SW | SANITARY SEWER |
| EX | EXISTING | SW, S/W | SIDEWALK |
| EX | EXISTING | TEMP | TEMPORARY |
| EX | EXISTING | TYP | TYPICAL |
| EX | EXISTING | VAR | VARIABLE |
| IMP(S) | IMPROVEMENT(S) | | |
| MDR | MEDIUM DENSITY RESIDENTIAL | | |

OWNER


BRIGGS & 74, LLC
PO BOX L
RANCHO SANTA FE, CA 92067
DLONG@RANCONGROUP.COM
(951) 200-2367

PREPARER

ANDERSON CONSULTING ENGINEERS, INC
12526 HIGH BLUFF DRIVE, SUITE 300
SAN DIEGO, CA 92130
JEFF@ACE-ENGINEERS.COM
(858) 925-7918

APPLICANT

DANNY LONG
MR56 LLC/RANCON GROUP
41391 KALMIA STREET, SUITE 200
MURRIETA, CA 92562
DLONG@RANCONGROUP.COM
(951) 200-2367

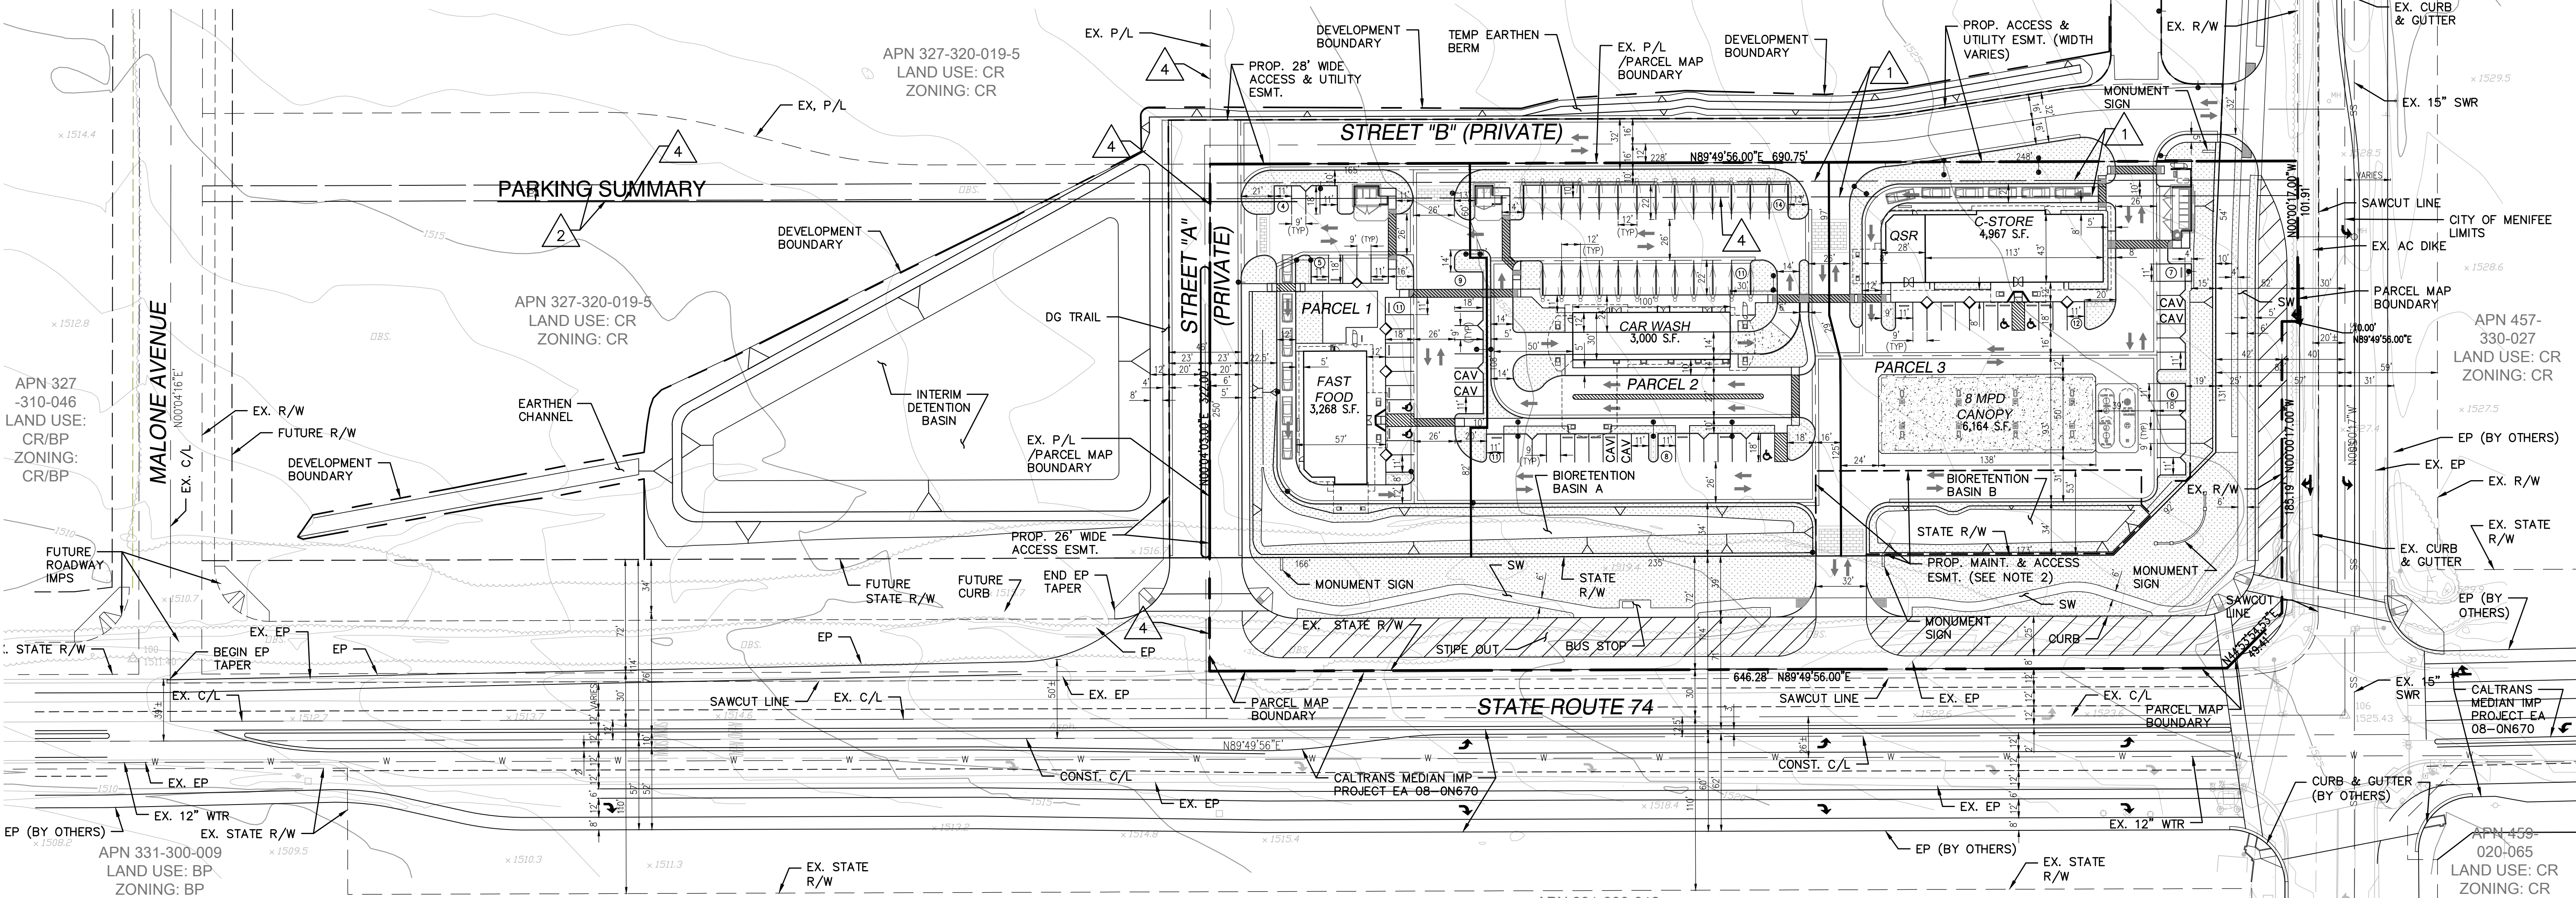

NOTES

- PROPOSED BLANKET EASEMENT FOR RECIPROCAL ACCESS AND PARKING, UTILITIES, DRAINAGE, AND MAINTENANCE SHALL BE RECORDED ON PARCELS 1-3 AS PART OF THIS PARCEL MAP.
- PROPOSED MAINTENANCE AND ACCESS EASEMENT IN FAVOR OF THE CITY OF MENEFEE.
- SEE ARCHITECTURE PLAN FOR TRUCK TURNING.
- SEE LANDSCAPE PLAN FOR FENCING LOCATION AND DETAILS.

| NO | DESCRIPTION | APPR | DATE |
|----|-------------|------|------|
| | | | |
| | | | |
| | | | |

**CONDITIONAL USE PERMIT NO. 2017-226
HARVEST GLEN
SITE PLAN**

CITY OF MENEFEE, COUNTY OF RIVERSIDE,
STATE OF CALIFORNIA

ENGINEER: ANDERSON CONSULTING ENGINEERS, INC.
12526 HIGH BLUFF DRIVE, SUITE 300
SAN DIEGO, CA 92130
(858) 925-7918

SCALE: 1" = 50'
DATE: 5/21/2019
DESIGNED BY: JAA
DRAWN BY: JMC
CHECKED BY: JAA
SHEET 1 OF 5

CONDITIONAL USE PERMIT NO. 2017-226 HARVEST GLEN

ABBREVIATIONS

| | |
|--------|---------------------------------|
| AC | ASPHALT CONCRETE |
| APN | ASSESSOR PARCEL NUMBER |
| BP | BUSINESS PARK |
| BNDRY | BOUNDARY |
| C/L | CENTERLINE |
| CR | COMMERCIAL RETAIL |
| ESMT. | EASEMENT |
| EP | EDGE OF PAVEMENT |
| EX | EXISTING |
| HDR | HIGH DENSITY RESIDENTIAL |
| MDR | MEDIUM DENSITY RESIDENTIAL |
| MHDR | MEDIUM HIGH DENSITY RESIDENTIAL |
| PL P/L | PROPERTY LINE |
| PROP. | PROPOSED |
| PM | PARCEL MAP |
| R-R | RURAL-RESIDENTIAL |
| R/W | RIGHT OF WAY |
| RS | RECORD OF SURVEY |
| VAR | VARIABLES |

LEGEND



| | |
|-----|----------------------|
| --- | EXIST. PROPERTY LINE |
| --- | EXIST. RIGHT OF WAY |
| --- | RIGHT OF WAY |
| --- | PROJECT BOUNDARY |
| --- | PROPERTY LINE |
| --- | EASEMENT |

EASEMENT NOTES

- △ EXISTING P.U.E. IN FAVOR OF THE SOUTHERN CALIFORNIA TELEPHONE COMPANY REC. DEC. 5, 1936 IN BOOK 303, PAGE 577, O.R.
- △ EXISTING P.U.E. IN FAVOR OF THE SOUTHERN CALIFORNIA TELEPHONE COMPANY REC. FEB. 4, 1937 IN BOOK 311, PAGE 389, O.R.
- △ EXISTING EASEMENT FOR SLOPE AND INCIDENTAL PURPOSES IN FAVOR OF THE STATE OF CALIFORNIA REC. MAY 12, 1970 AS INST. NO. 44270, O.R.
- △ EXISTING P.U.E. IN FAVOR OF THE SOUTHERN SIERRAS POWER COMPANY REC. APR. 11, 1928 IN BOOK 758, PAGE 180 OF DEEDS. (WIDTH UNKNOWN)

NOTES

- 1. PROPOSED A BLANKET EASEMENT FOR RECIPROCAL ACCESS AND PARKING, UTILITIES, DRAINAGE, AND MAINTENANCE SHALL BE RECORDED ON PARCELS 1-3 AS PART OF THIS PARCEL MAP.
- 2. PROPOSED MAINTENANCE AND ACCESS EASEMENT IN FAVOR OF THE CITY OF MENEFEE.

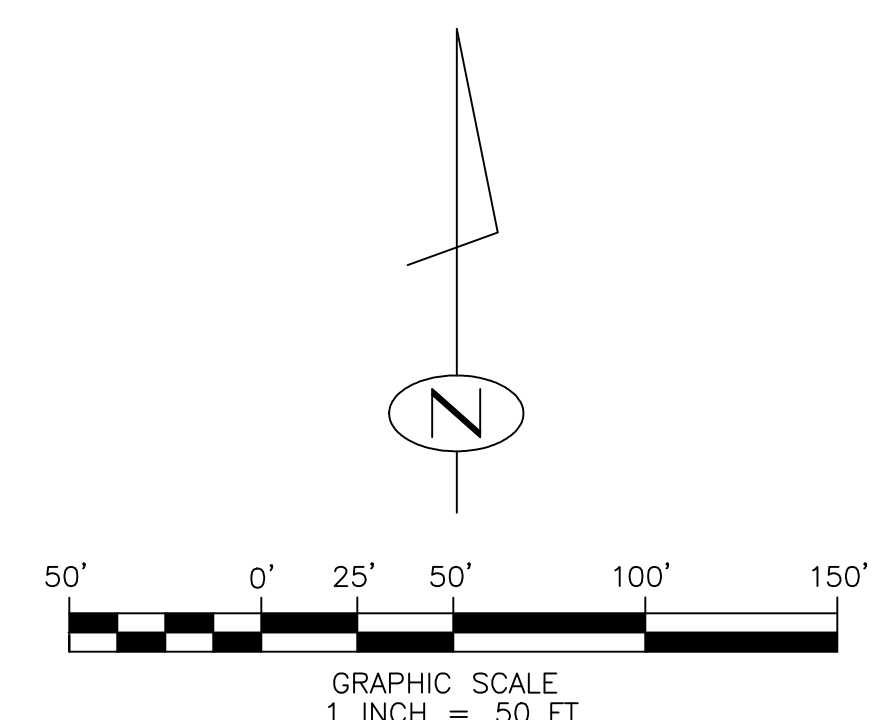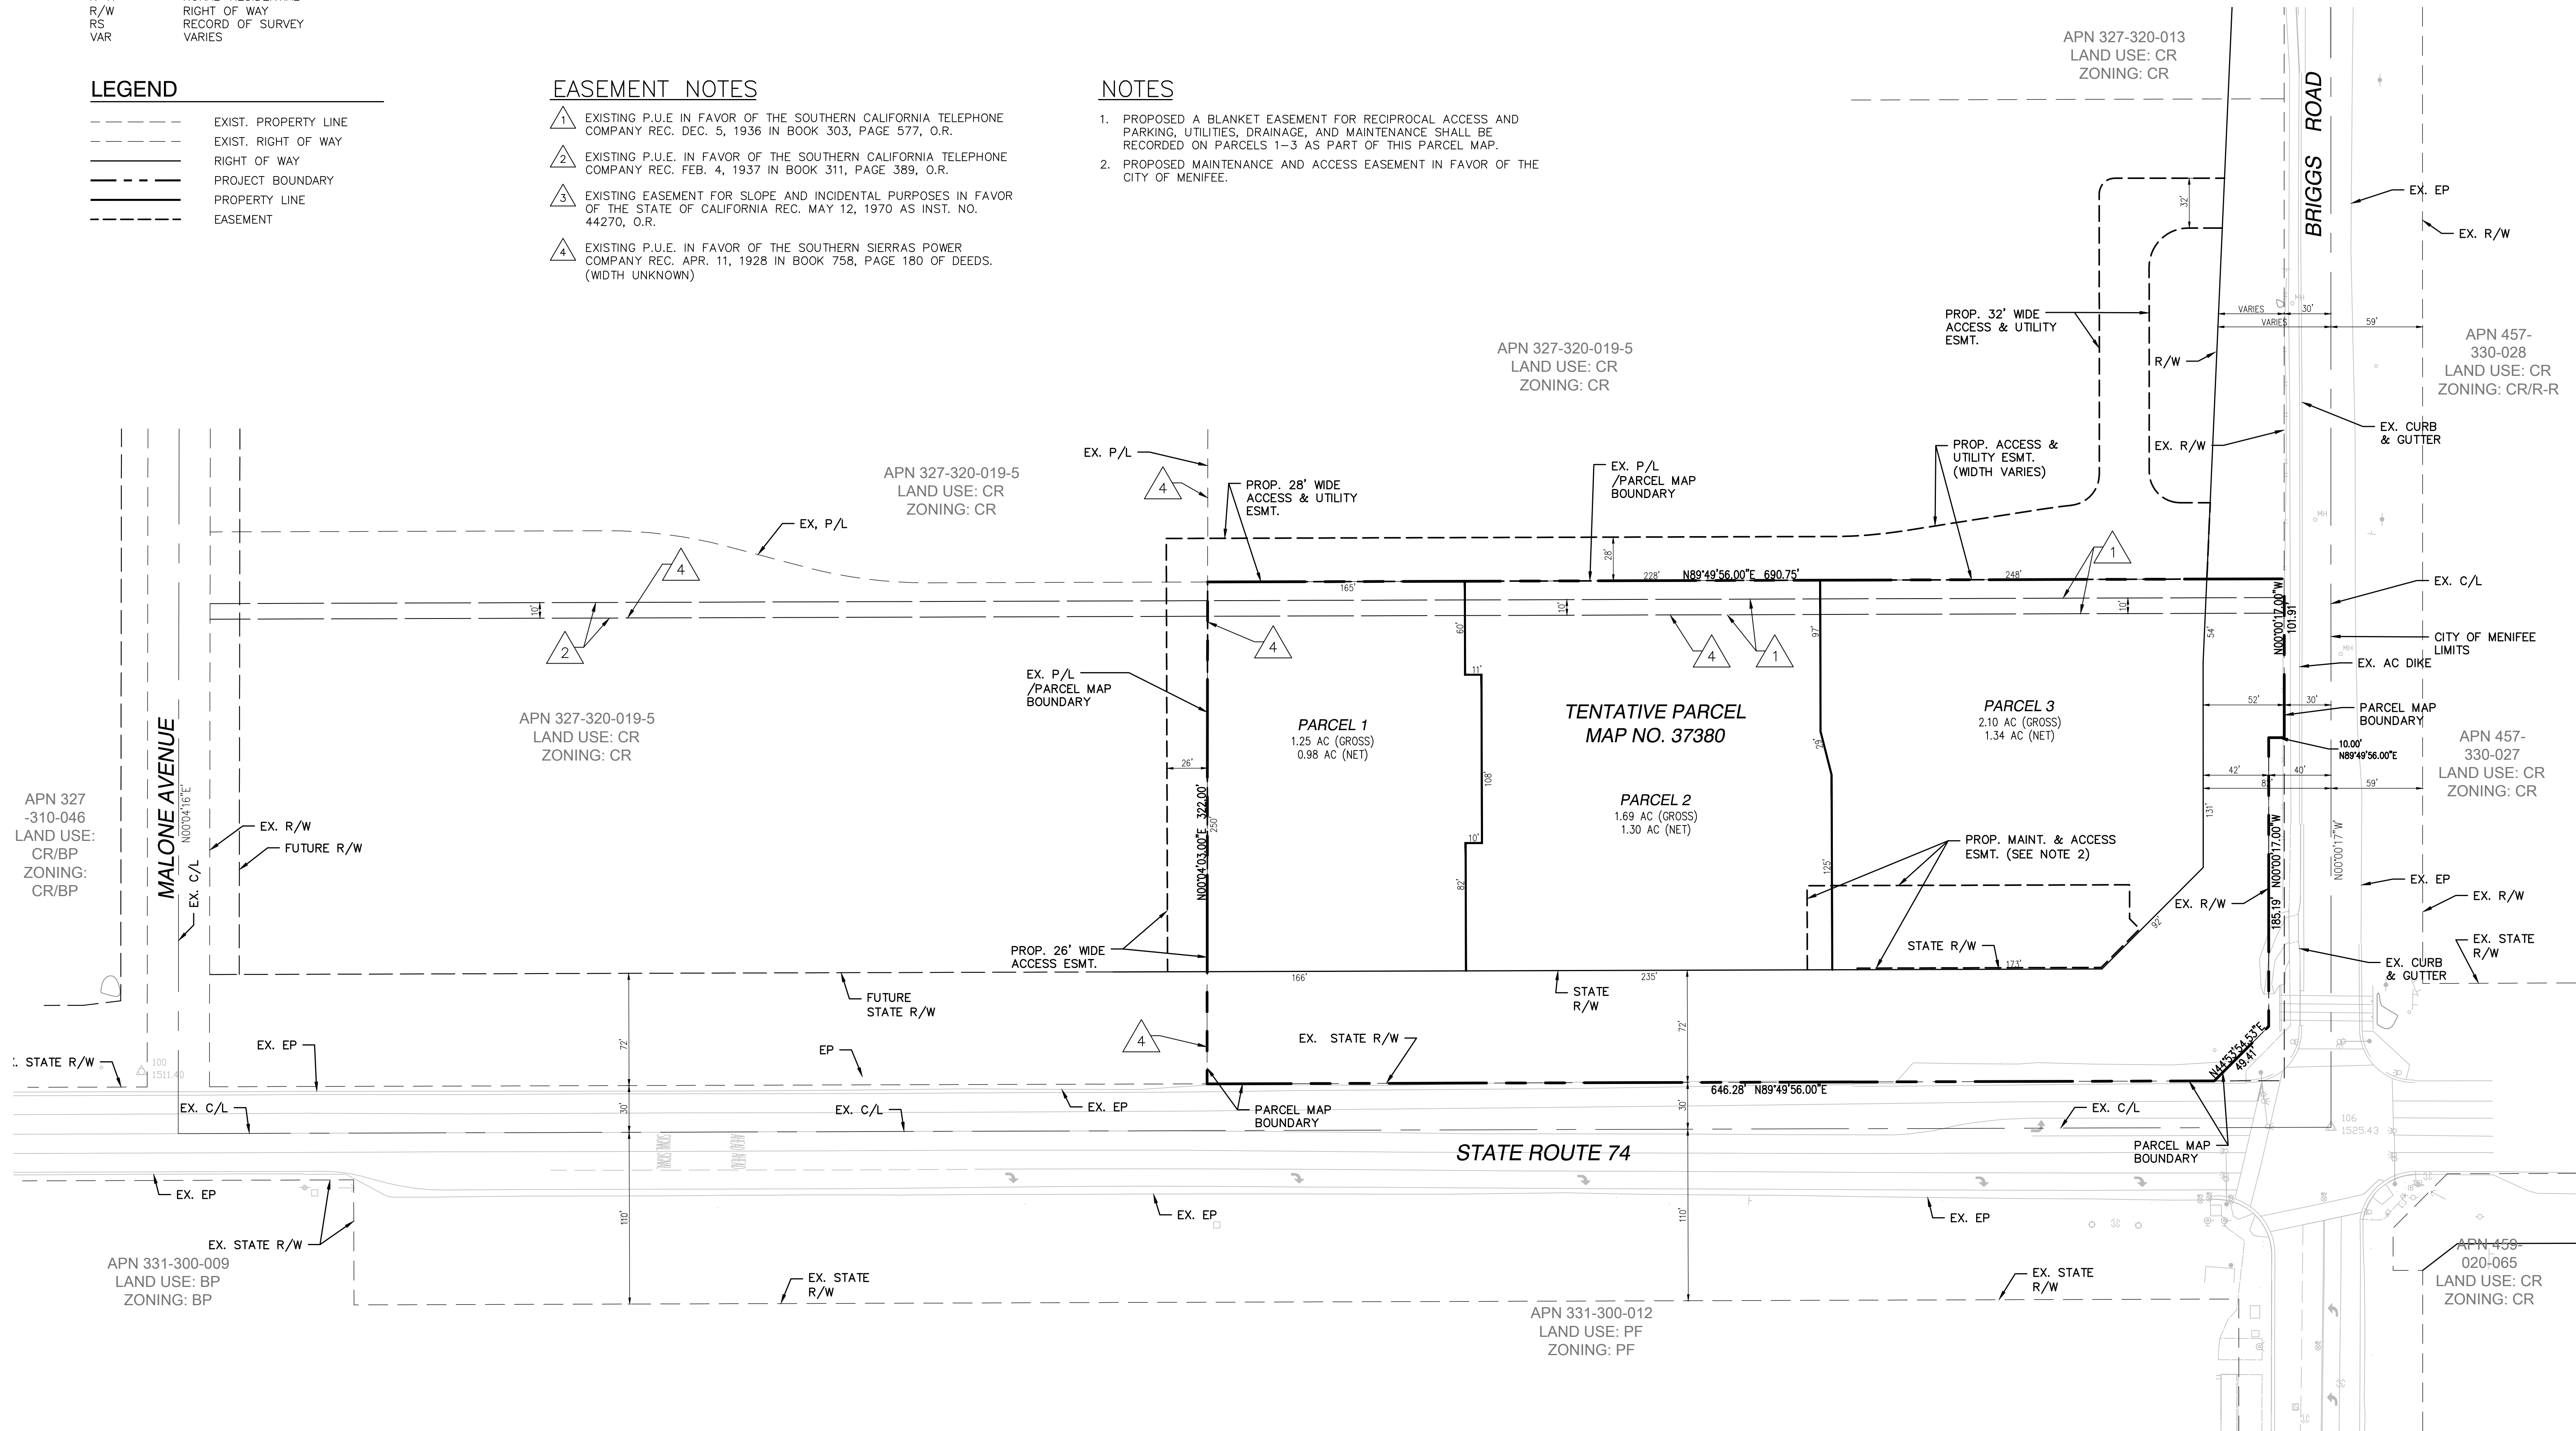

| NO | DESCRIPTION | APPR | DATE |
|----|-------------|------|------|
| | | | |
| | | | |
| | | | |
| | | | |

**CONDITIONAL USE PERMIT NO. 2017-226
HARVEST GLEN
PARCEL EXHIBIT**

CITY OF MENEFEE, COUNTY OF RIVERSIDE,
STATE OF CALIFORNIA

| | | |
|--|---|--|
| ENGINEER: ANDERSON CONSULTING ENGINEERS, INC. | 12526 HIGH BLUFF DRIVE, SUITE 300 SAN DIEGO, CA 92130 (858) 925-7918 | SCALE: 1" = 50' DATE: 5/21/2019 DESIGNED BY: JAA DRAWN BY: IMC CHECKED BY: JAA SHEET 2 OF 5 |
|--|---|--|




CONDITIONAL USE PERMIT NO. 2017-226 HARVEST GLEN

ABBREVIATIONS

| | | | |
|---------|--------------------------|---------|---------------------------------|
| AC | ASPHALT CONCRETE | MDR | MEDIUM DENSITY RESIDENTIAL |
| APN | ASSESSOR PARCEL NUMBER | MHDR | MEDIUM HIGH DENSITY RESIDENTIAL |
| BP | BUSINESS PARK BOUNDARY | MPD | MULTIPLE PRODUCT DISPENSER |
| CB | CATCH BASIN | OBS. | OBSURED |
| C/L | CENTERLINE | PE | PAD ELEVATION |
| C&G | CURB AND GUTTER | PL, P/L | PROPERTY LINE |
| CONC. | CONCRETE | PM | PARCEL MAP |
| CONSTR. | CONSTRUCT | QSR | QUICK SERVE RESTAURANT |
| CR | COMMERCIAL RETAIL | RET | RETAINING WALL |
| ESMT. | EASEMENT | R-R | RURAL-RESIDENTIAL |
| EP | EDGE OF PAVEMENT | R/W | RIGHT OF WAY |
| EX. | EXISTING | RS | RECORD OF SURVEY |
| FF | FINISH FLOOR | SD | STORM DRAIN |
| FG | FINISH GRADE | SS, SWR | SANITARY SEWER |
| FL | FLOW LINE | TEMP | TEMPORARY |
| FS | FINISH SURFACE | TC | TOP OF CURB |
| GB | GRADE BREAK | TYP | TYPICAL |
| HDR | HIGH DENSITY RESIDENTIAL | VAR | VARIES |
| HP | HIGH POINT | WTR | WATER |
| IMP(S) | IMPROVEMENT(S) | | |
| INW | INVERT | | |
| LP | LOW POINT | | |

LEGEND

| | |
|-----|------------------------------|
| --- | EXIST. PROPERTY LINE |
| --- | EXIST. RIGHT OF WAY |
| --- | RIGHT OF WAY |
| --- | PROJECT BOUNDARY |
| --- | DEVELOPMENT BOUNDARY |
| --- | PROPERTY LINE |
| --- | EASEMENT |
| --- | MAJOR CONTOUR |
| --- | MINOR CONTOUR |
| --- | SLOPE INDICATOR |
| --- | SLOPE (N > 3:1) |
| --- | DAYLIGHT LINE |
| --- | FLOW LINE |
| --- | GRADE BREAK/RIDGE LINE |
| --- | BLOCK OR RETAINING WALL |
| --- | MODIFIED UNDERSIDEWALK DRAIN |
| --- | STORM DRAIN |
| --- | PROP. LANDSCAPE AREA |
| --- | PROP. CONCRETE PAVEMENT |
| --- | PROP. ACCENT PAVING |
| --- | PROP. STAMPED CONCRETE |

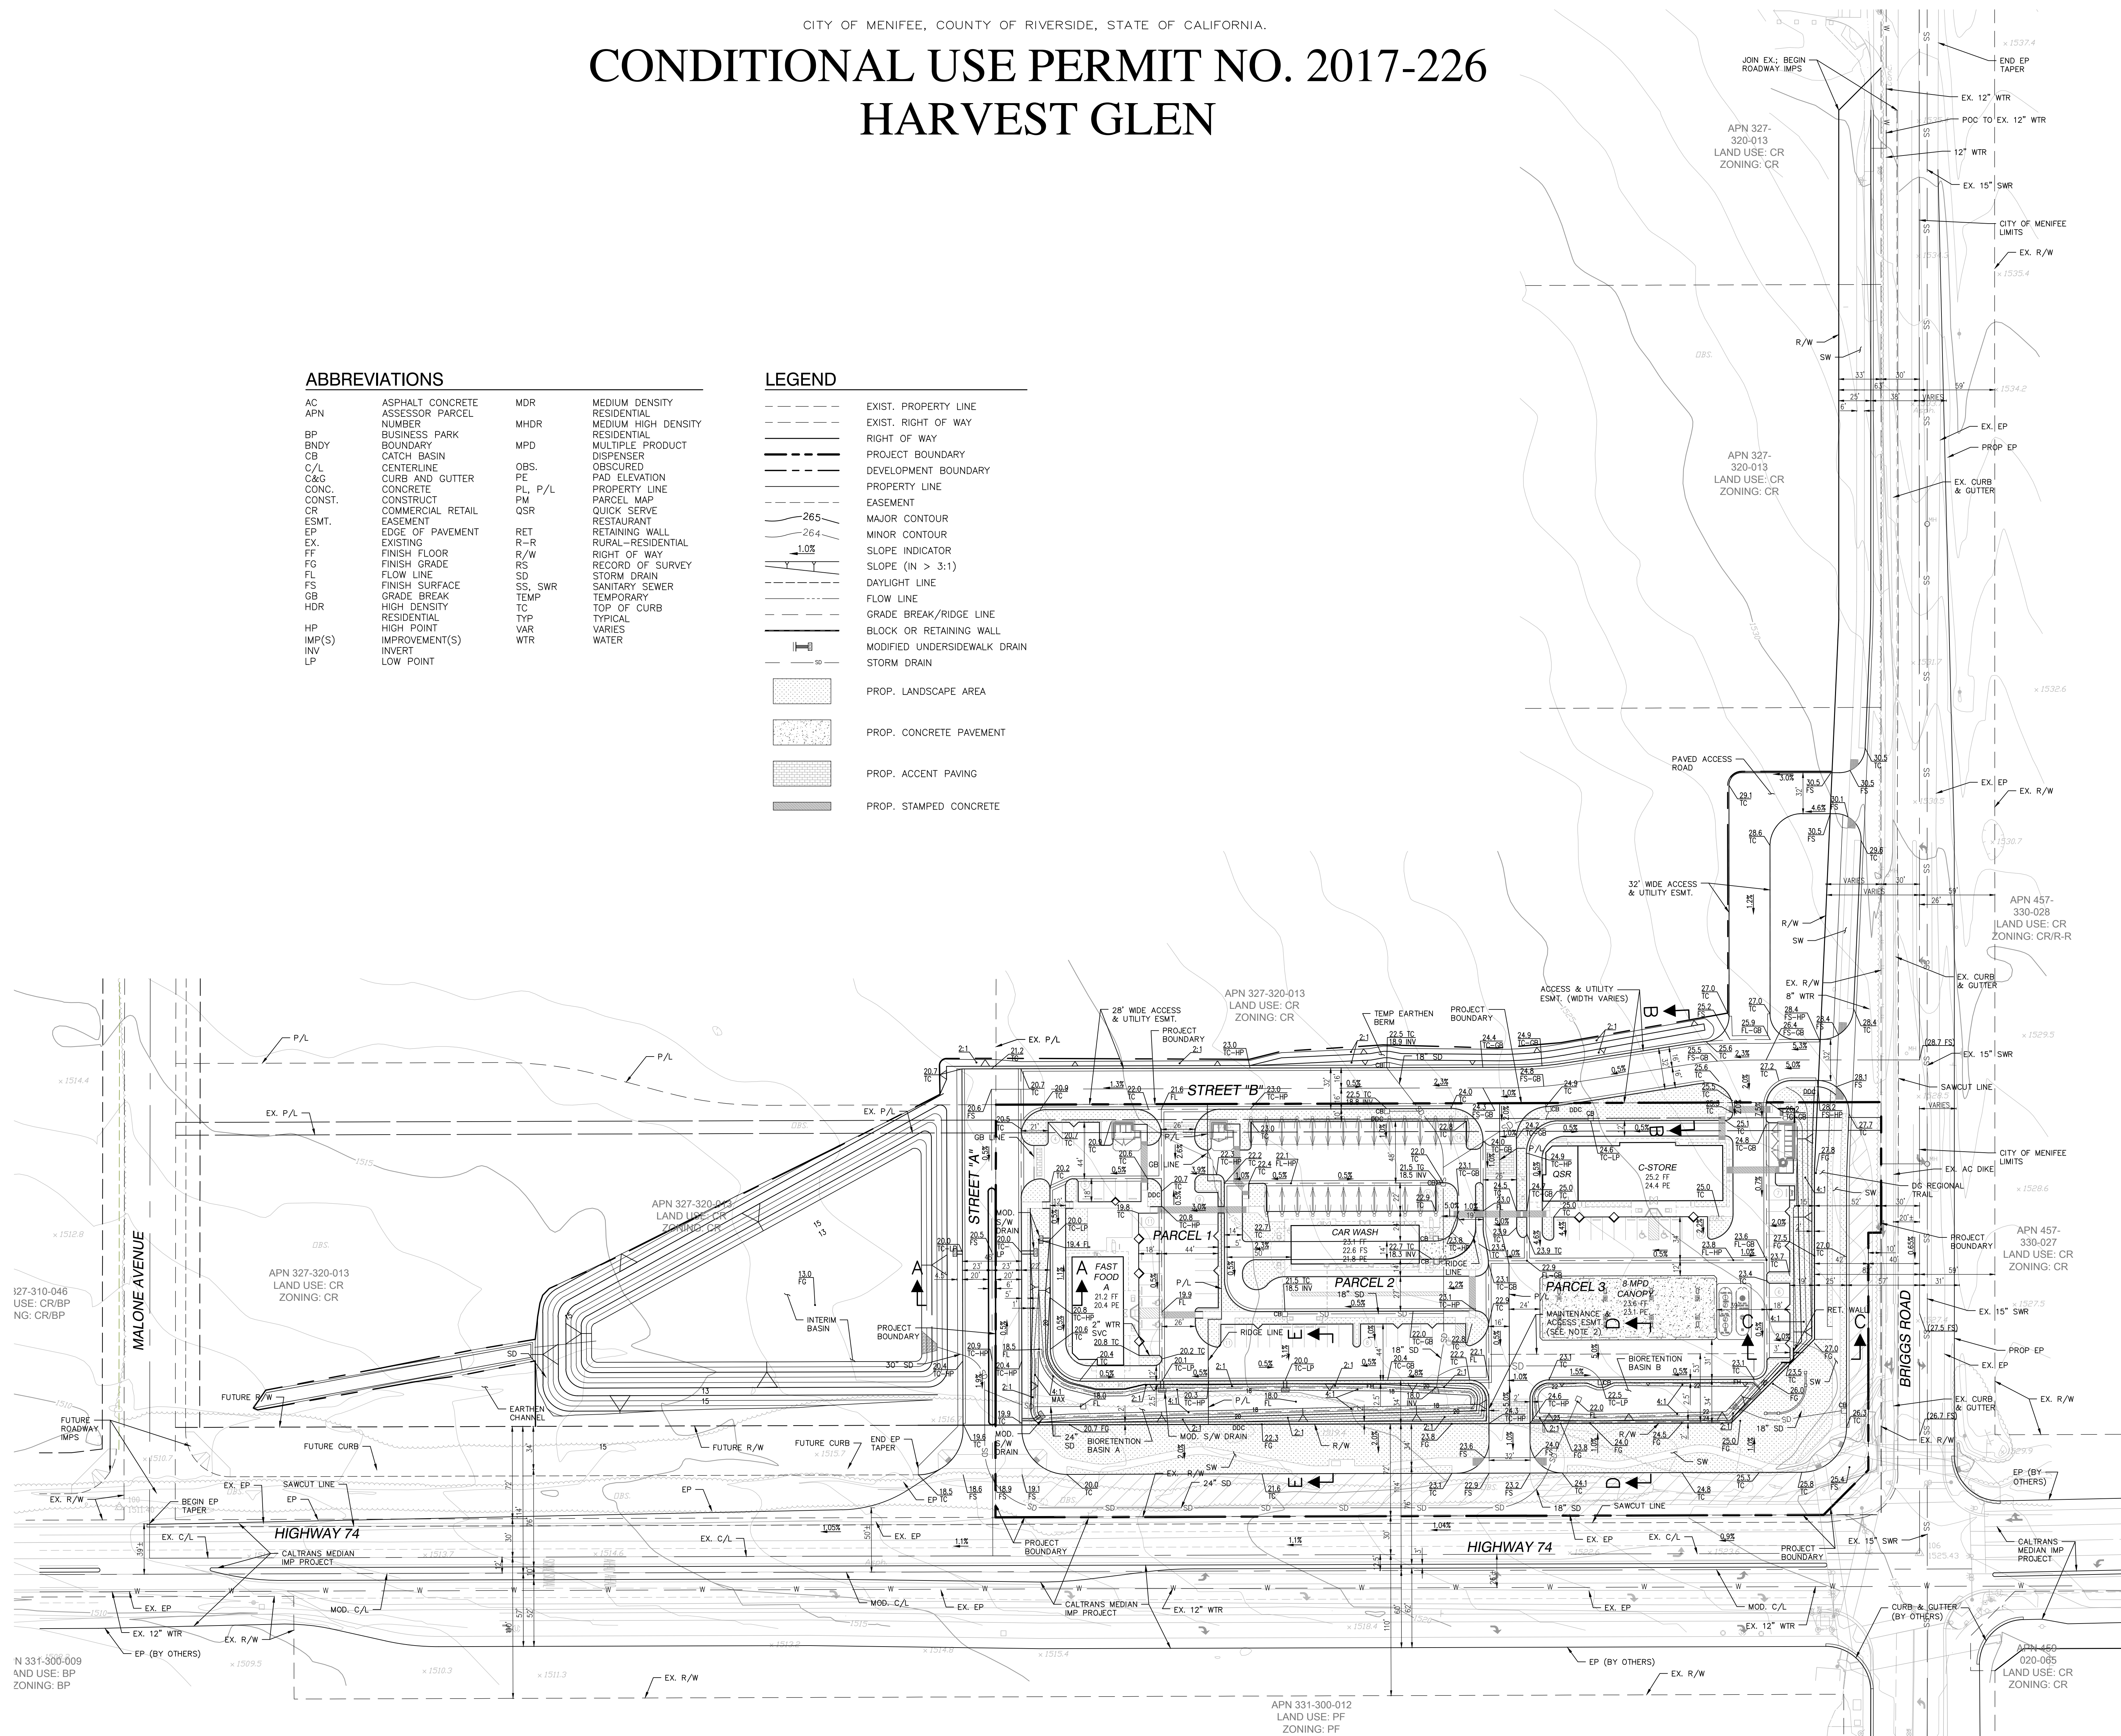


| NO | DESCRIPTION | APPR | DATE |
|----|-------------|------|------|
| | | | |
| | | | |
| | | | |

CONDITIONAL USE PERMIT NO. 2017-226
HARVEST GLEN
PRELIMINARY GRADING AND DRAINAGE PLAN
CITY OF MENEFEE, COUNTY OF RIVERSIDE,
STATE OF CALIFORNIA


ENGINEER:
ANDERSON CONSULTING ENGINEERS, INC.
12526 HIGH BLUFF DRIVE,
SUITE 300
SAN DIEGO, CA 92130
(858) 925-7918

SCALE: 1" = 50'
DATE: 5/21/2019
DESIGNED BY: JAA
DRAWN BY: JMC
CHECKED BY: JAA
SHEET 3 OF 5


CONDITIONAL USE PERMIT NO. 2017-226 HARVEST GLEN

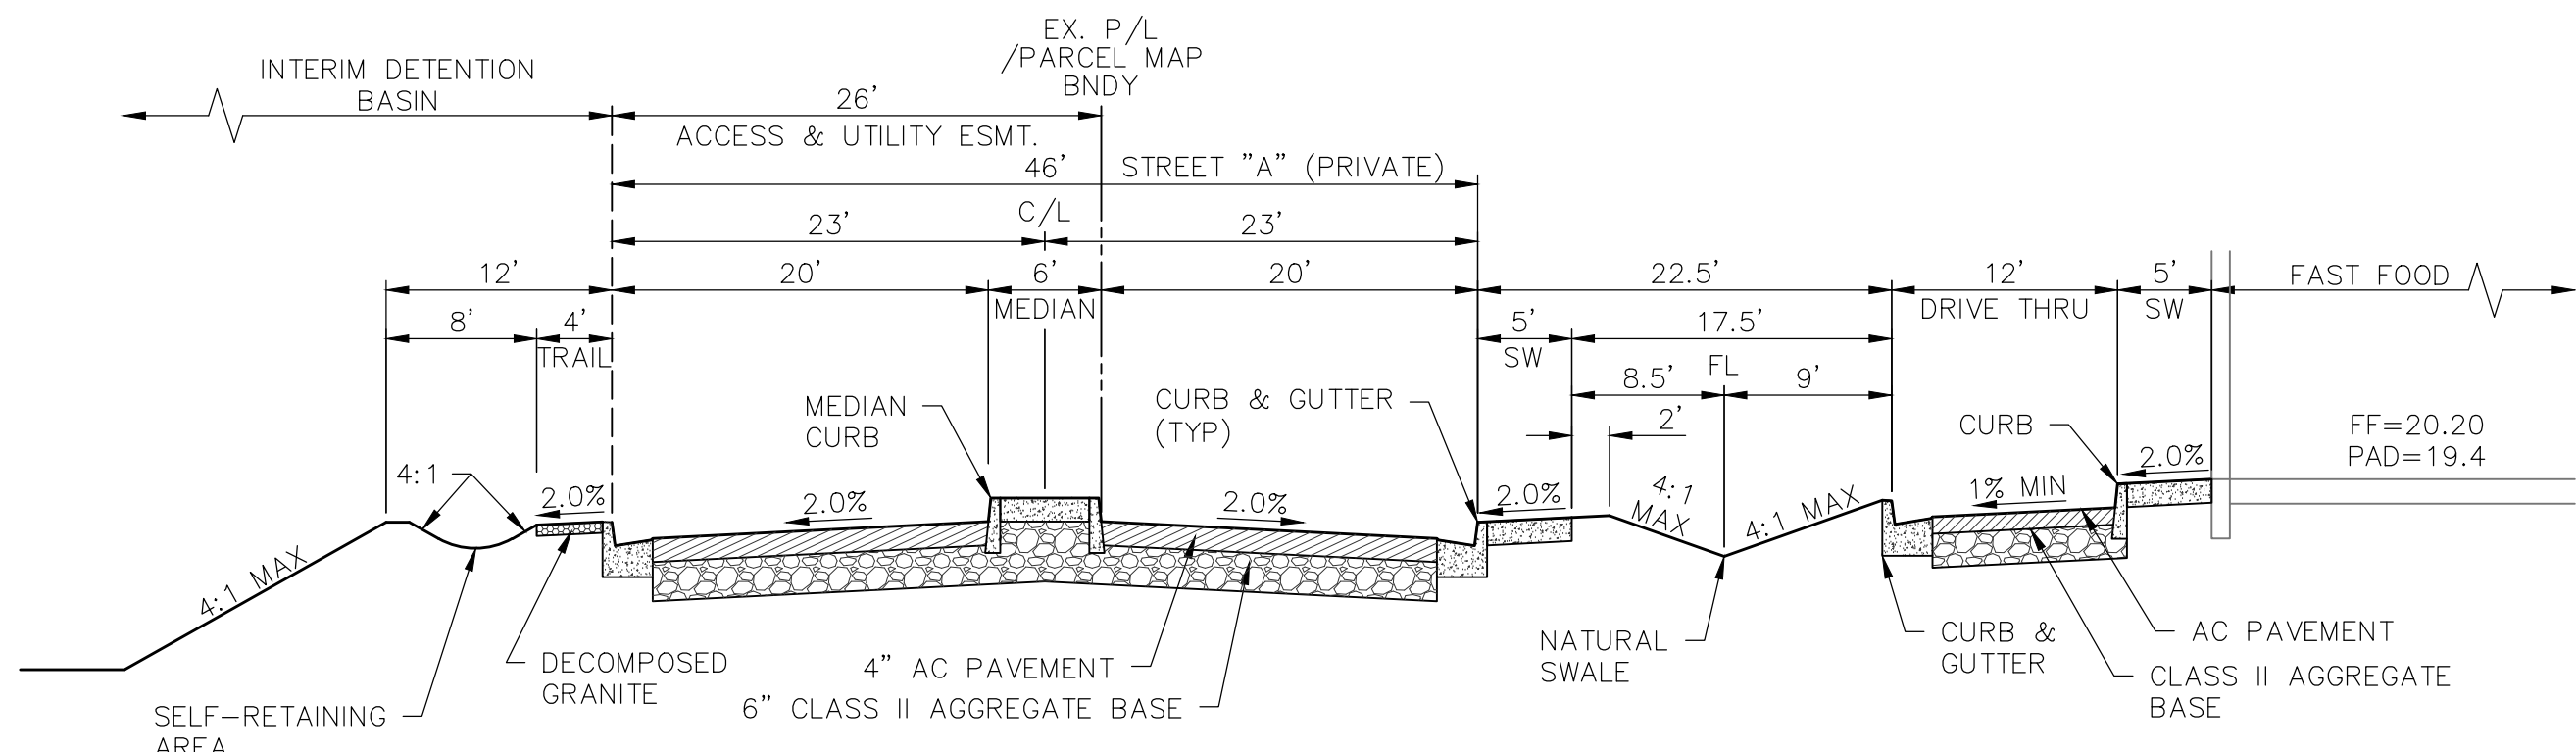

SECTION A-A
NOT TO SCALE

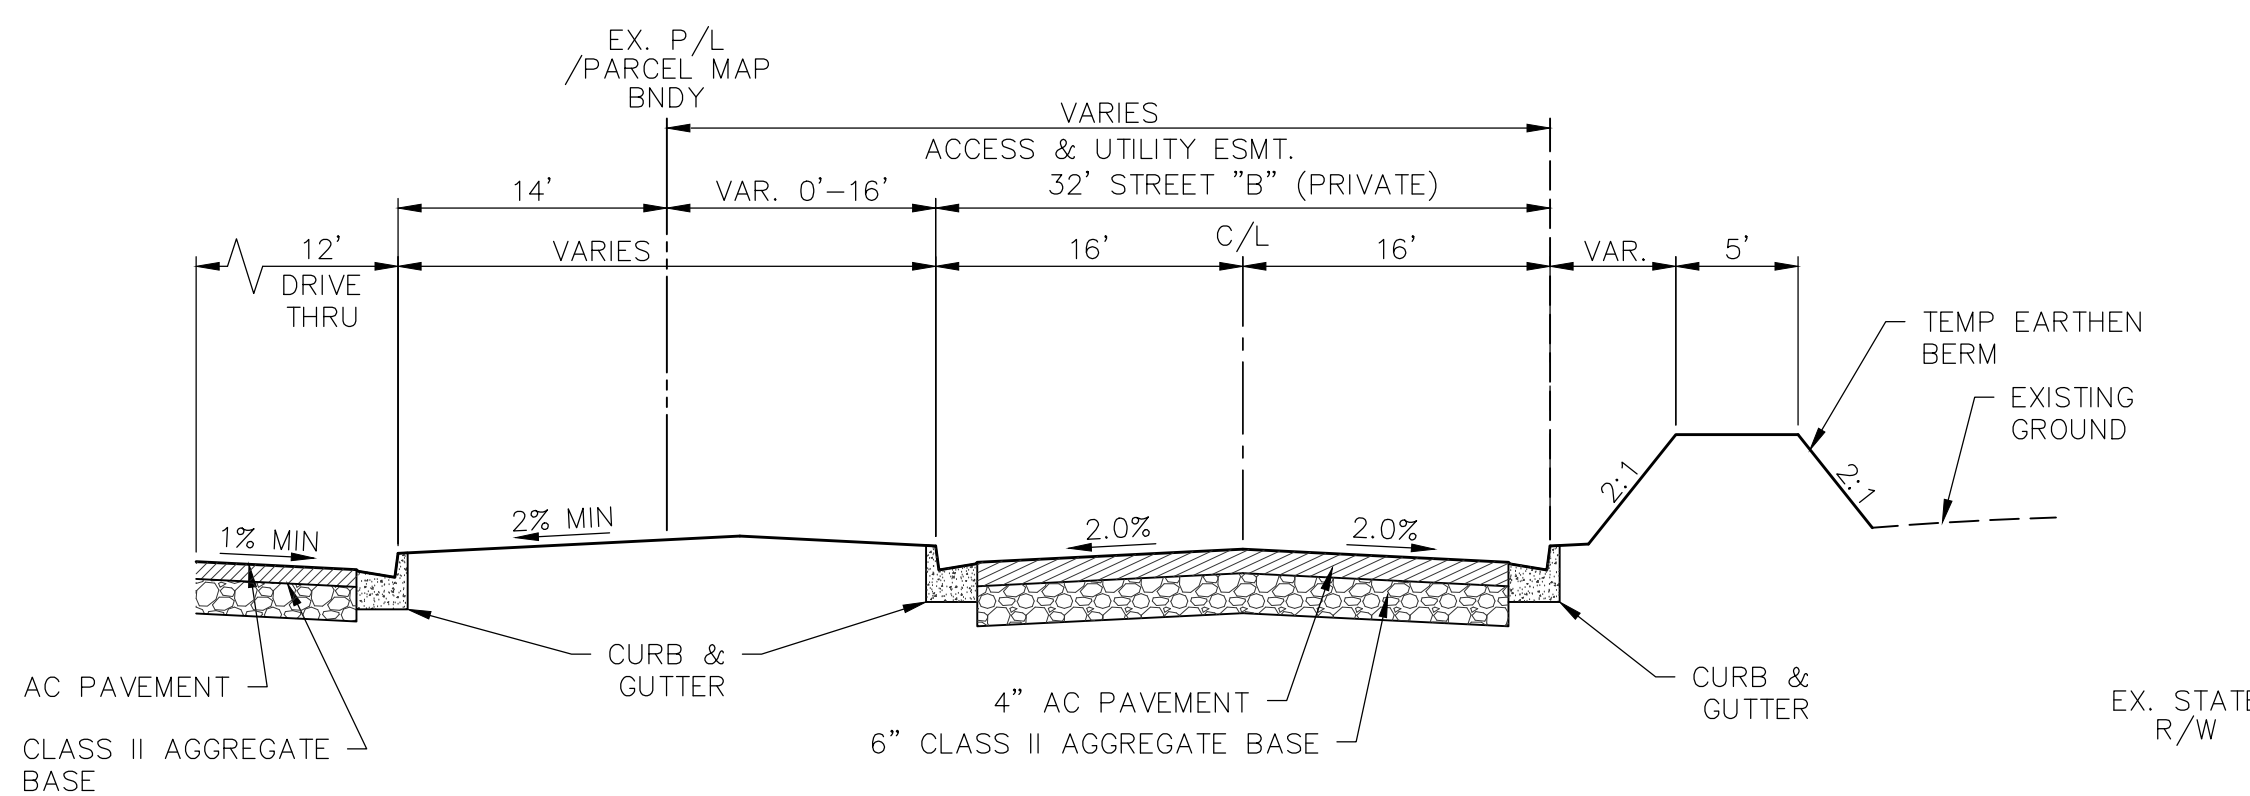


SECTION B-B
NOT TO SCALE

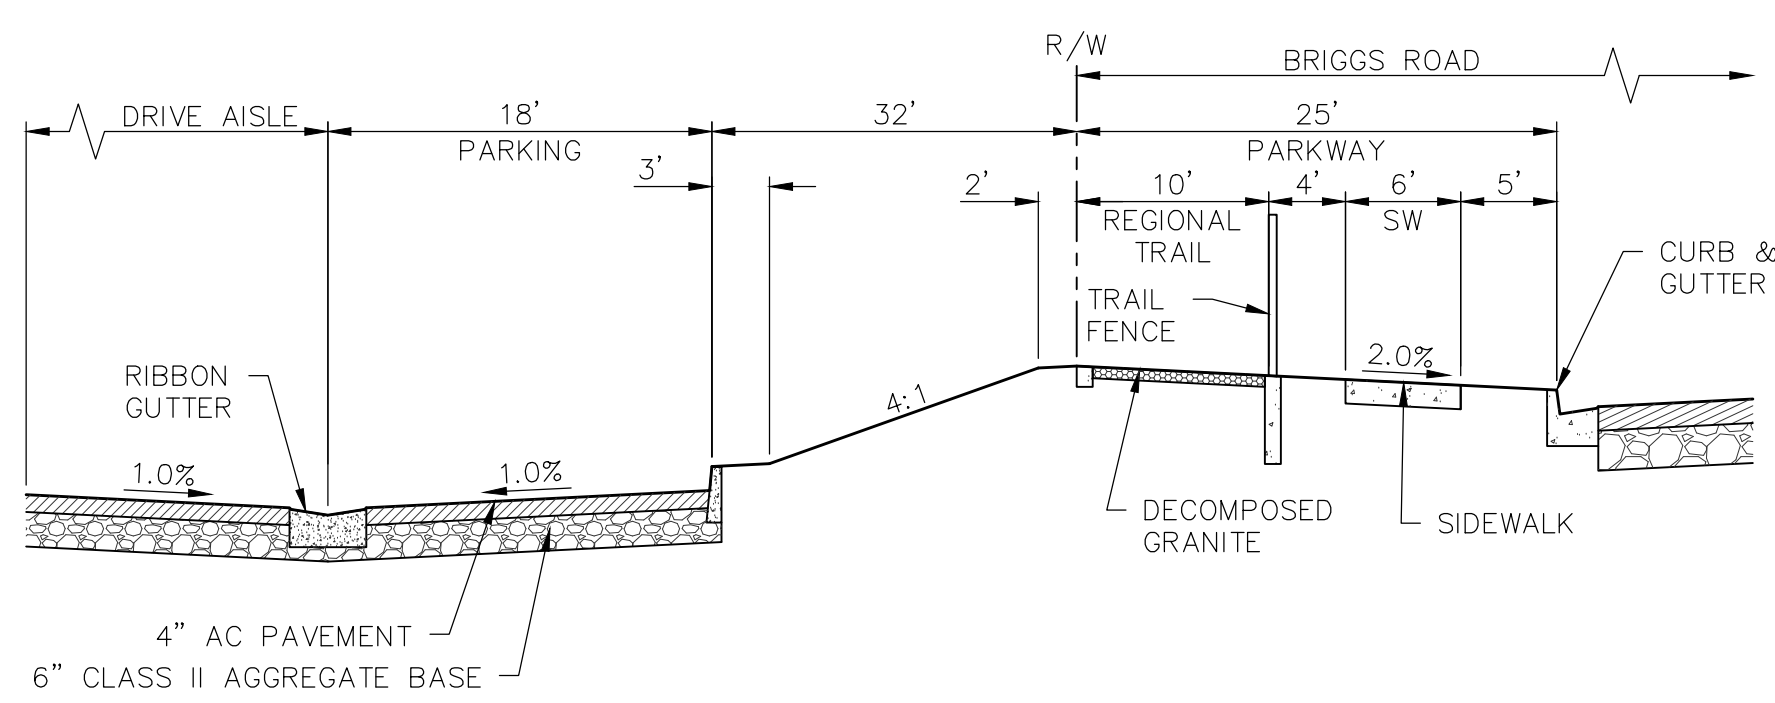


SECTION C-C
NOT TO SCALE

NOTE: FOR FENCING LOCATIONS AND DETAILS, PLEASE SEE THE LANDSCAPE PLANS

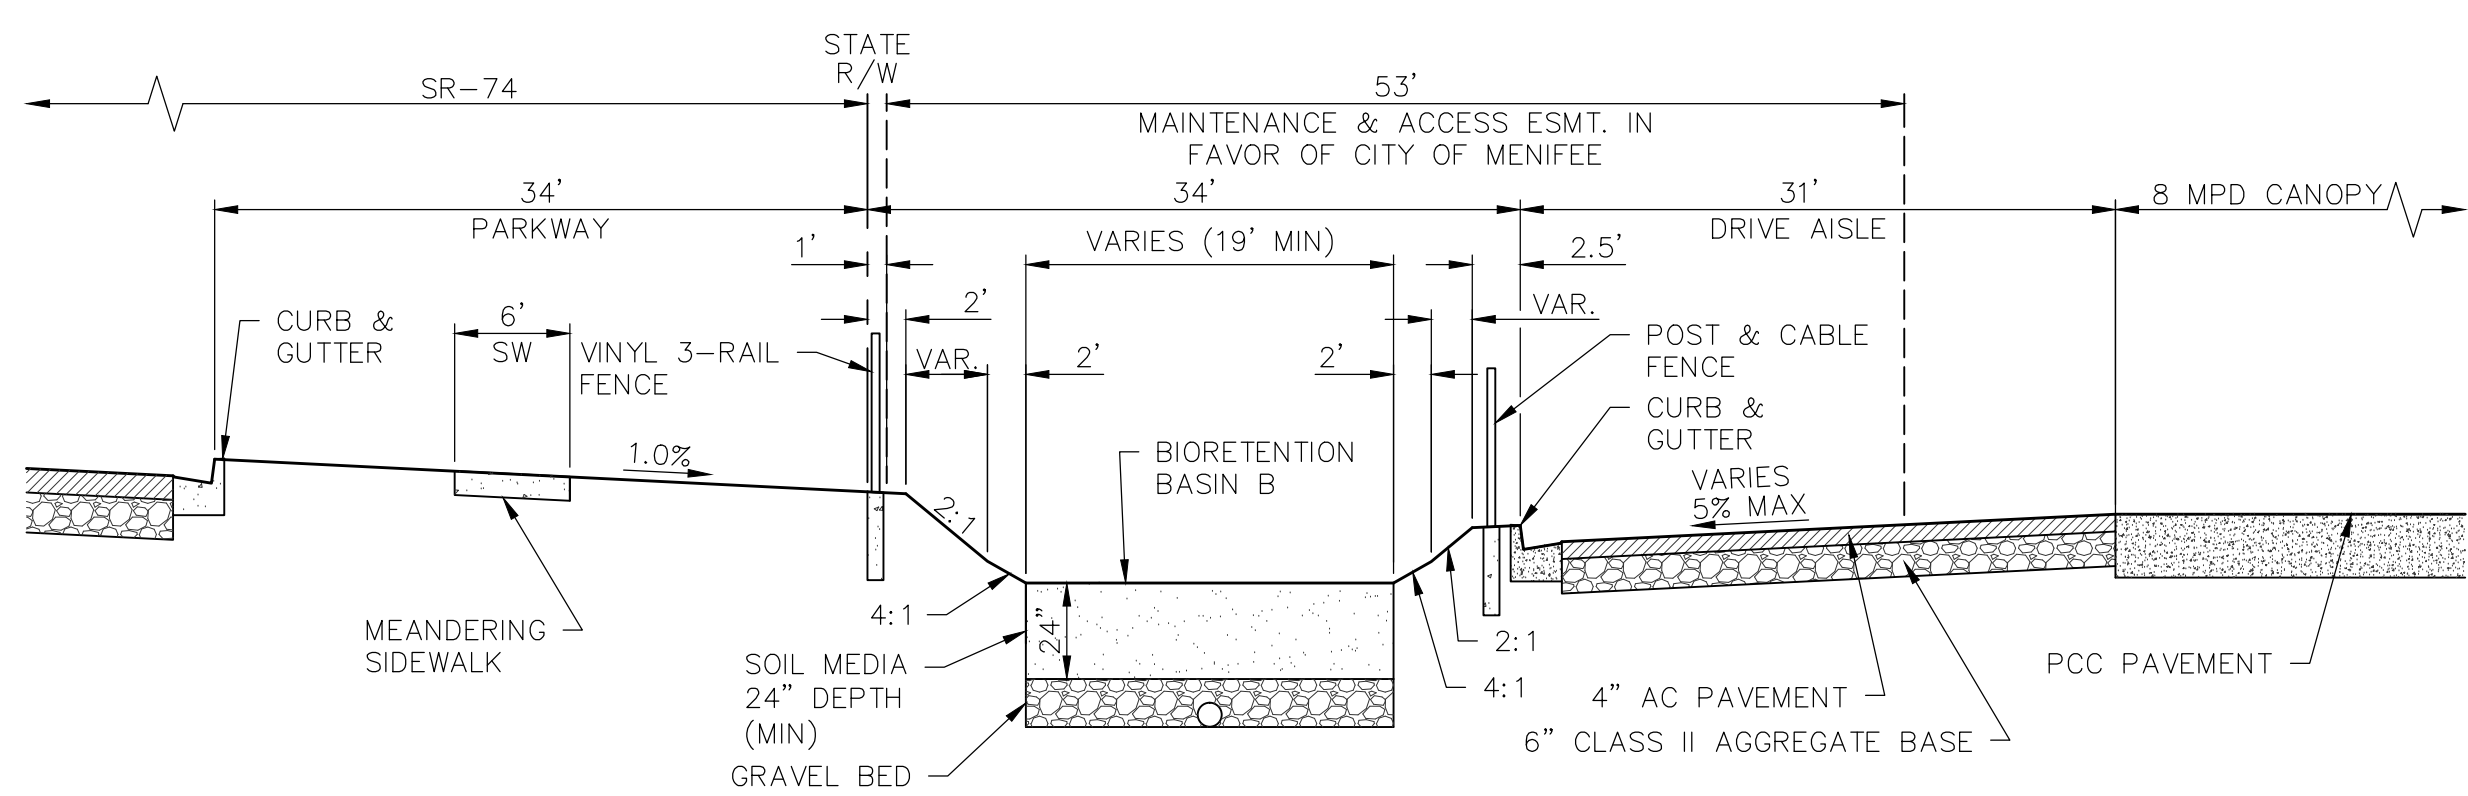


SECTION D-D
NOT TO SCALE

NOTE: FOR FENCING LOCATIONS AND DETAILS, PLEASE SEE THE LANDSCAPE PLANS

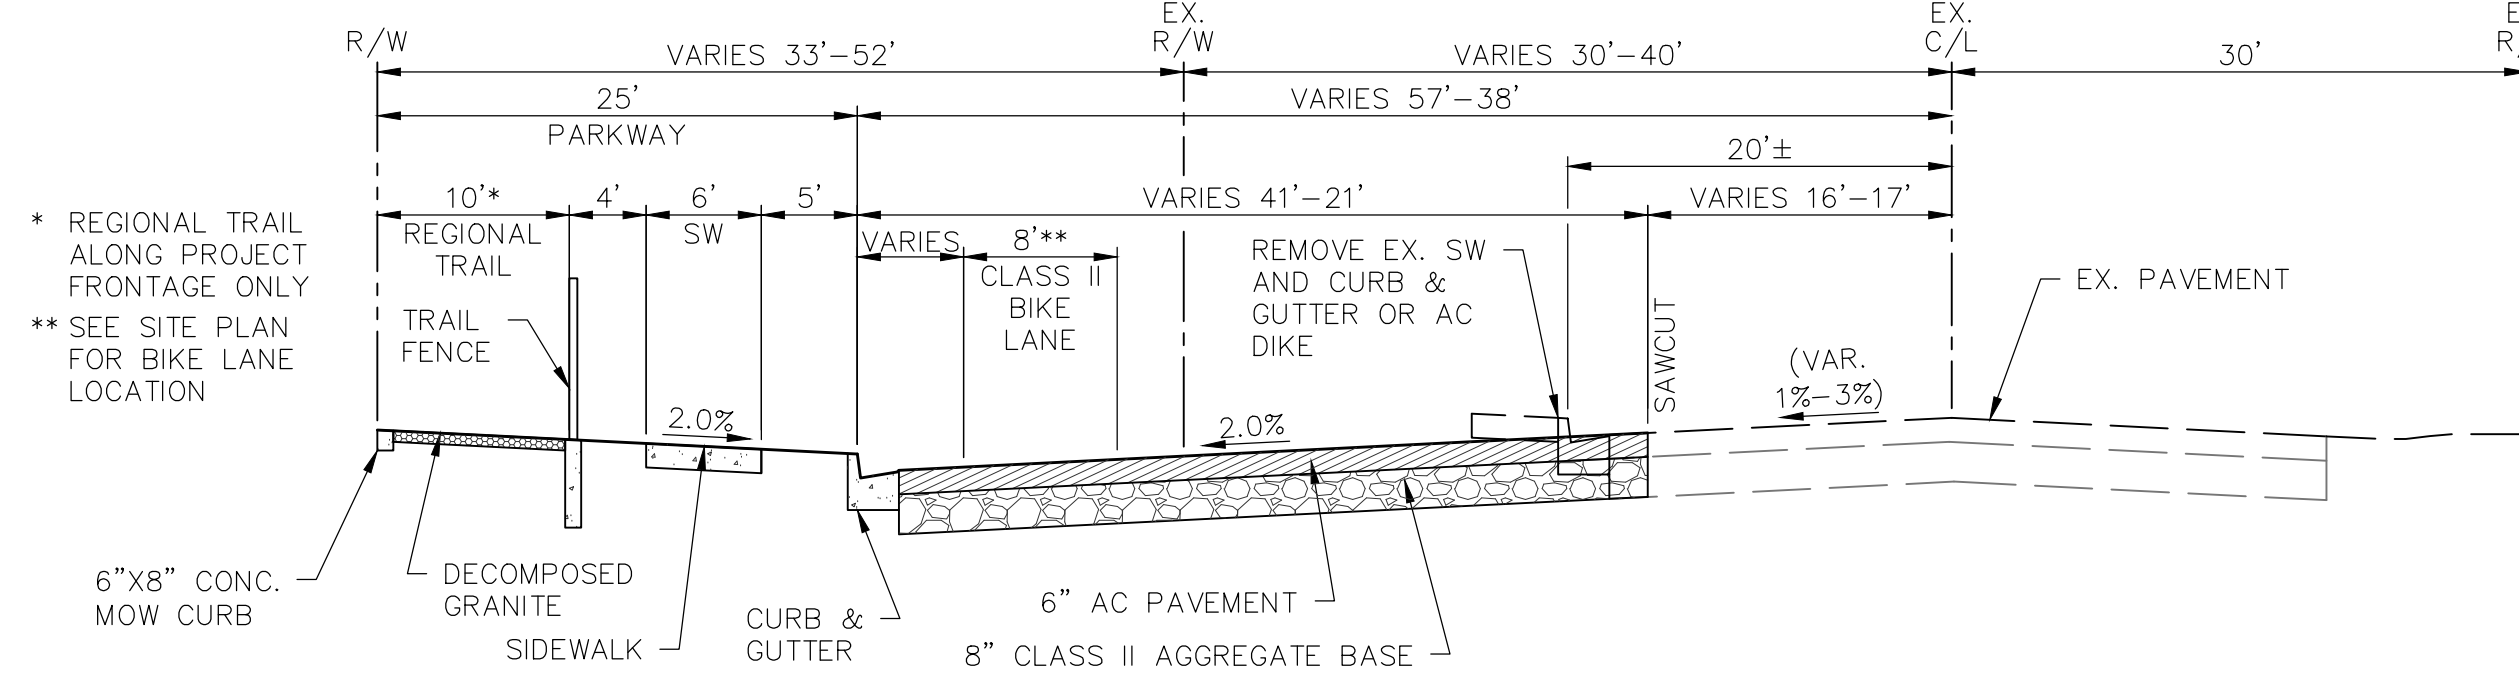


BRIGGS ROAD
MODIFIED MAJOR (4 LANES) PER CITY STD 110
NOT TO SCALE


NOTE: FINAL PAVEMENT SECTION TO BE DETERMINED BY SOILS ENGINEER FOLLOWING FIELD TESTING

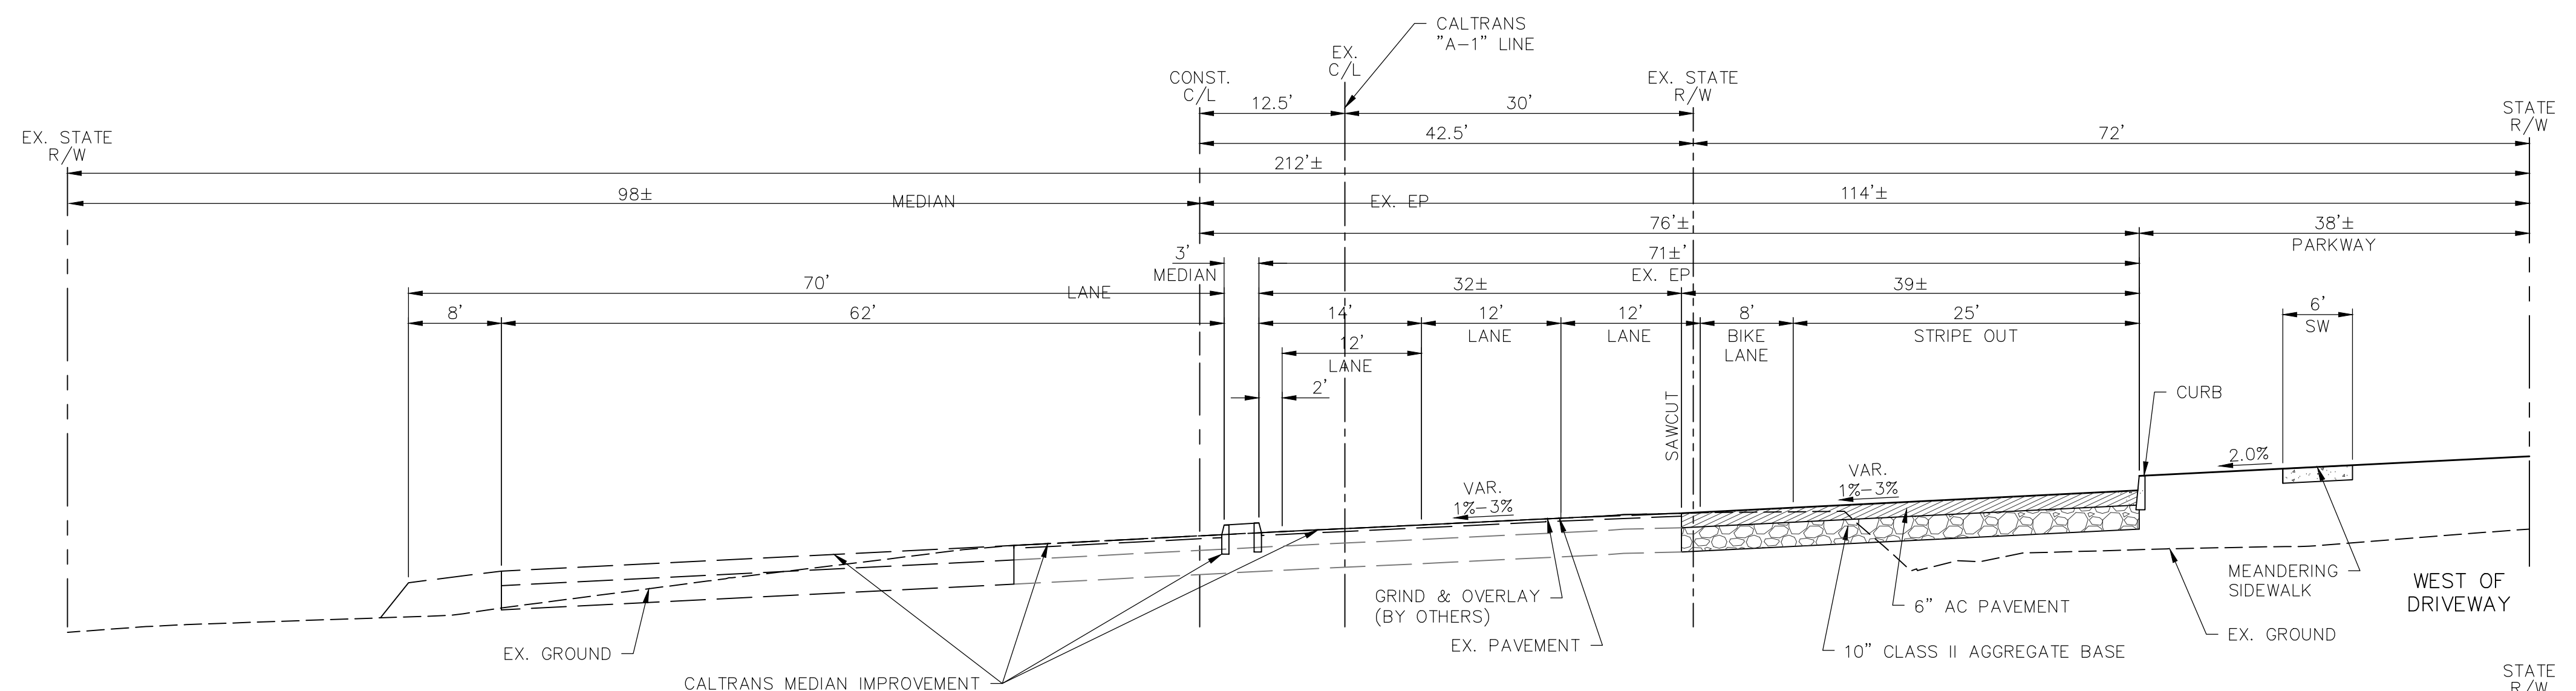


STATE ROUTE 74 (STA. 288+16.72 TO STA 294+48.21)
MODIFIED EXPRESSWAY (8 LANES) PER CITY STD 90
NOT TO SCALE

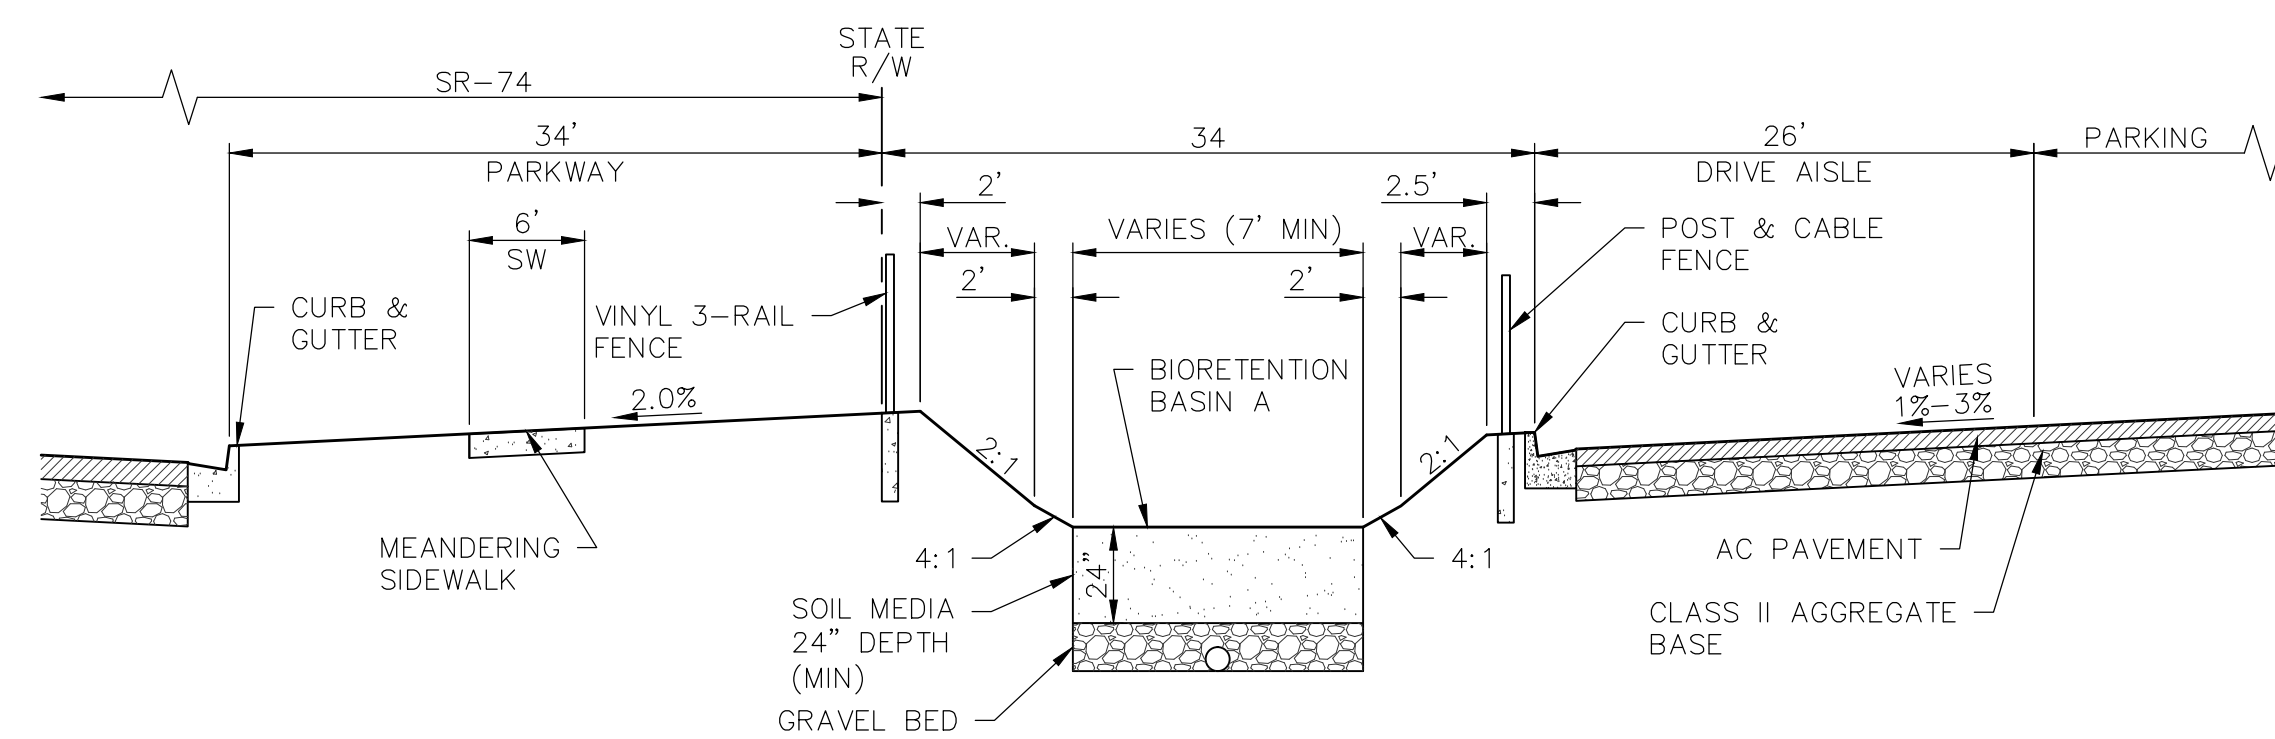

SECTION E-E
NOT TO SCALE

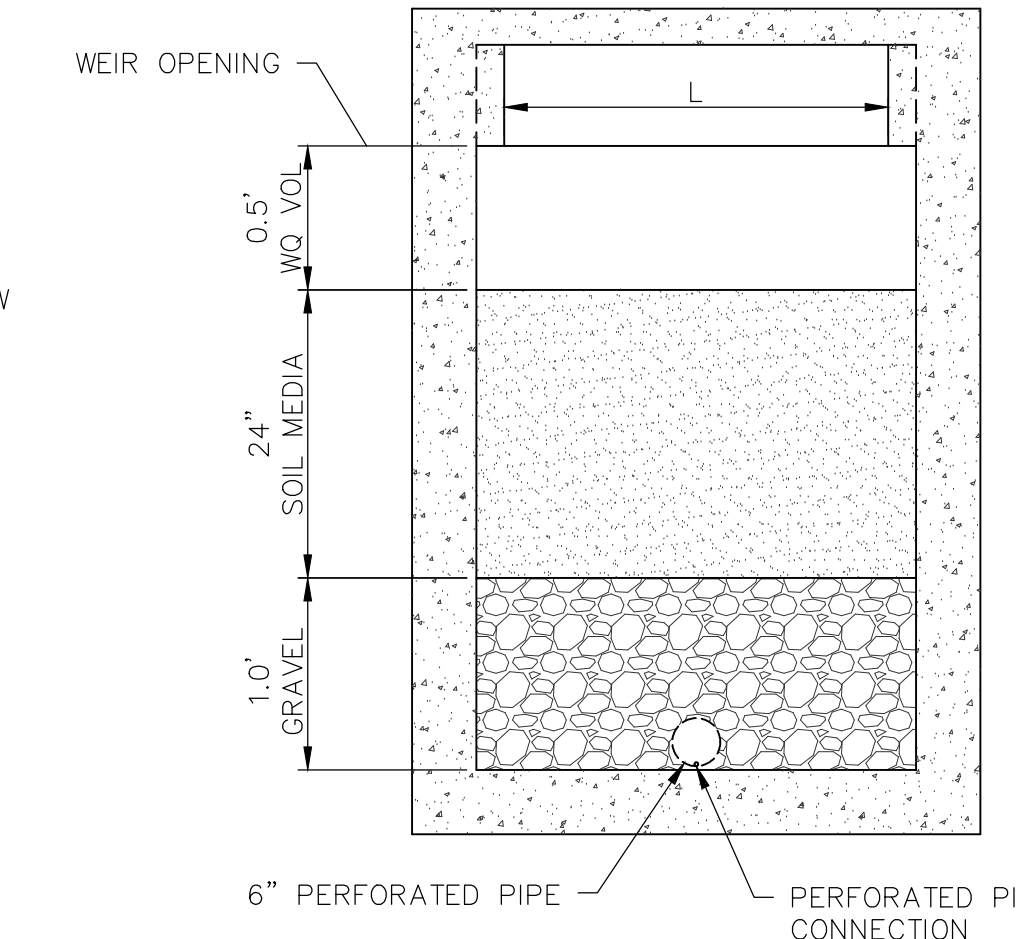

TYPICAL BIORETENTION BASIN OUTLET DETAIL
NOT TO SCALE

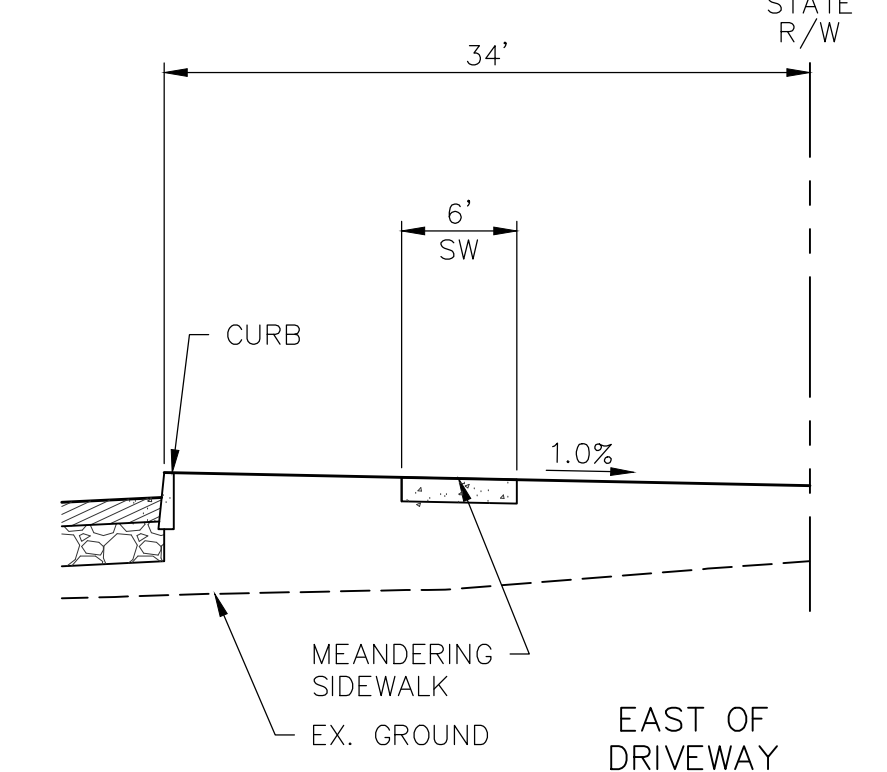

| NO | DESCRIPTION | APPR | DATE |
|----|-------------|------|------|
| | | | |
| | | | |
| | | | |
| | | | |



CONDITIONAL USE PERMIT NO. 2017-226
HARVEST GLEN
TYPICAL SECTIONS
CITY OF MENIFEE, COUNTY OF RIVERSIDE,
STATE OF CALIFORNIA

ENGINEER:
ANDERSON CONSULTING ENGINEERS, INC.
12526 HIGH BLUFF DRIVE, SUITE 300
SAN DIEGO, CA 92130
(858) 925-7918

SCALE: N/A
DATE: 5/21/2019
DESIGNED BY: JAA
DRAWN BY: IMC
CHECKED BY: JAA
SHEET 4 OF 5



CONDITIONAL USE PERMIT NO. 2017-226 HARVEST GLEN

ABBREVIATIONS

| | | | |
|--------|--------------------------|---------|---------------------------------|
| AC | ACRE | MDR | MEDIUM DENSITY RESIDENTIAL |
| AC | ASPHALT CONCRETE | MHDR | MEDIUM HIGH DENSITY RESIDENTIAL |
| APN | ASSESSOR PARCEL NUMBER | MPD | MULTIPLE PRODUCT DISPENSER |
| BP | BUSINESS PARK BOUNDARY | OBS. | OBSOURED |
| C/L | CENTERLINE | PL, P/L | PROPERTY LINE |
| C&G | CURB AND GUTTER | PM | PARCEL MAP |
| CR | COMMERCIAL RETAIL | POC | POINT OF CONNECTION |
| CR | COMMERCIAL RETAIL | QSR | QUICK SERVE RESTAURANT |
| DDC | DOUBLE DETECTOR CHECK | R-R | RURAL-RESIDENTIAL |
| ESMT. | EASEMENT | R/W | RIGHT OF WAY |
| EP | EDGE OF PAVEMENT | RS | RECORD OF SURVEY |
| EX. | EXISTING | SVC | SERVICE |
| EX. | EXISTING | SS, SWR | SANITARY SEWER |
| FH | FIRE HYDRANT | TEMP | TEMPORARY |
| FM | FORCE MAIN | WTR | WATER |
| HDR | HIGH DENSITY RESIDENTIAL | | |
| IMP(S) | IMPROVEMENT(S) | | |
| LAT | LATERAL | | |

LEGEND

| | |
|-----------|-------------------------|
| --- | EXIST. PROPERTY LINE |
| --- | EXIST. RIGHT OF WAY |
| --- | RIGHT OF WAY |
| --- | PROJECT BOUNDARY |
| --- | DEVELOPMENT BOUNDARY |
| --- | PROPERTY LINE |
| --- | EASEMENT |
| --- | SANITARY SEWER |
| --- | POTABLE WATER |
| --- | FIRE HYDRANT |
| [Pattern] | PROP. LANDSCAPE AREA |
| [Pattern] | PROP. CONCRETE PAVEMENT |
| [Pattern] | PROP. ACCENT PAVING |
| [Pattern] | PROP. STAMPED CONCRETE |

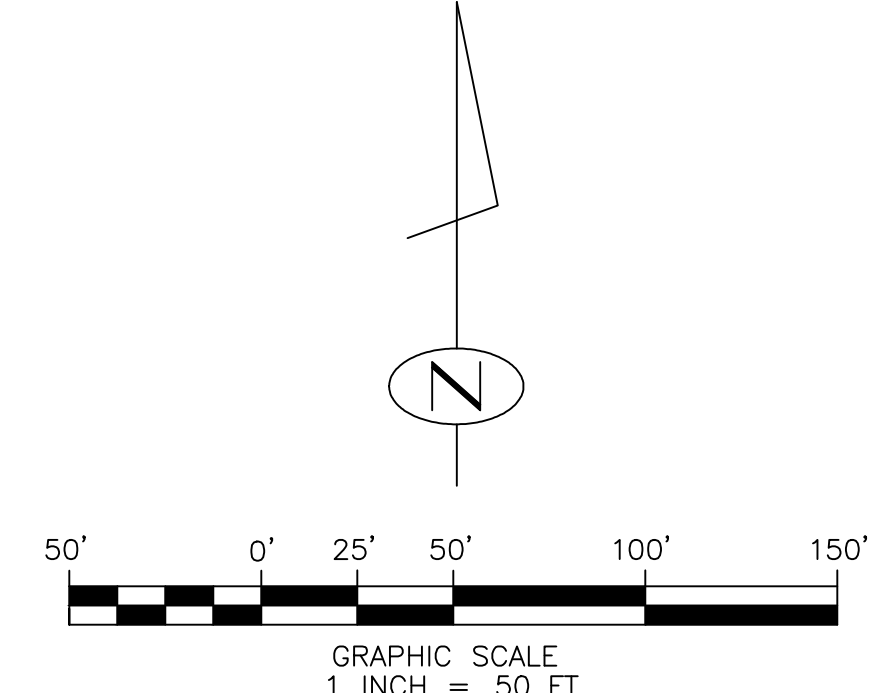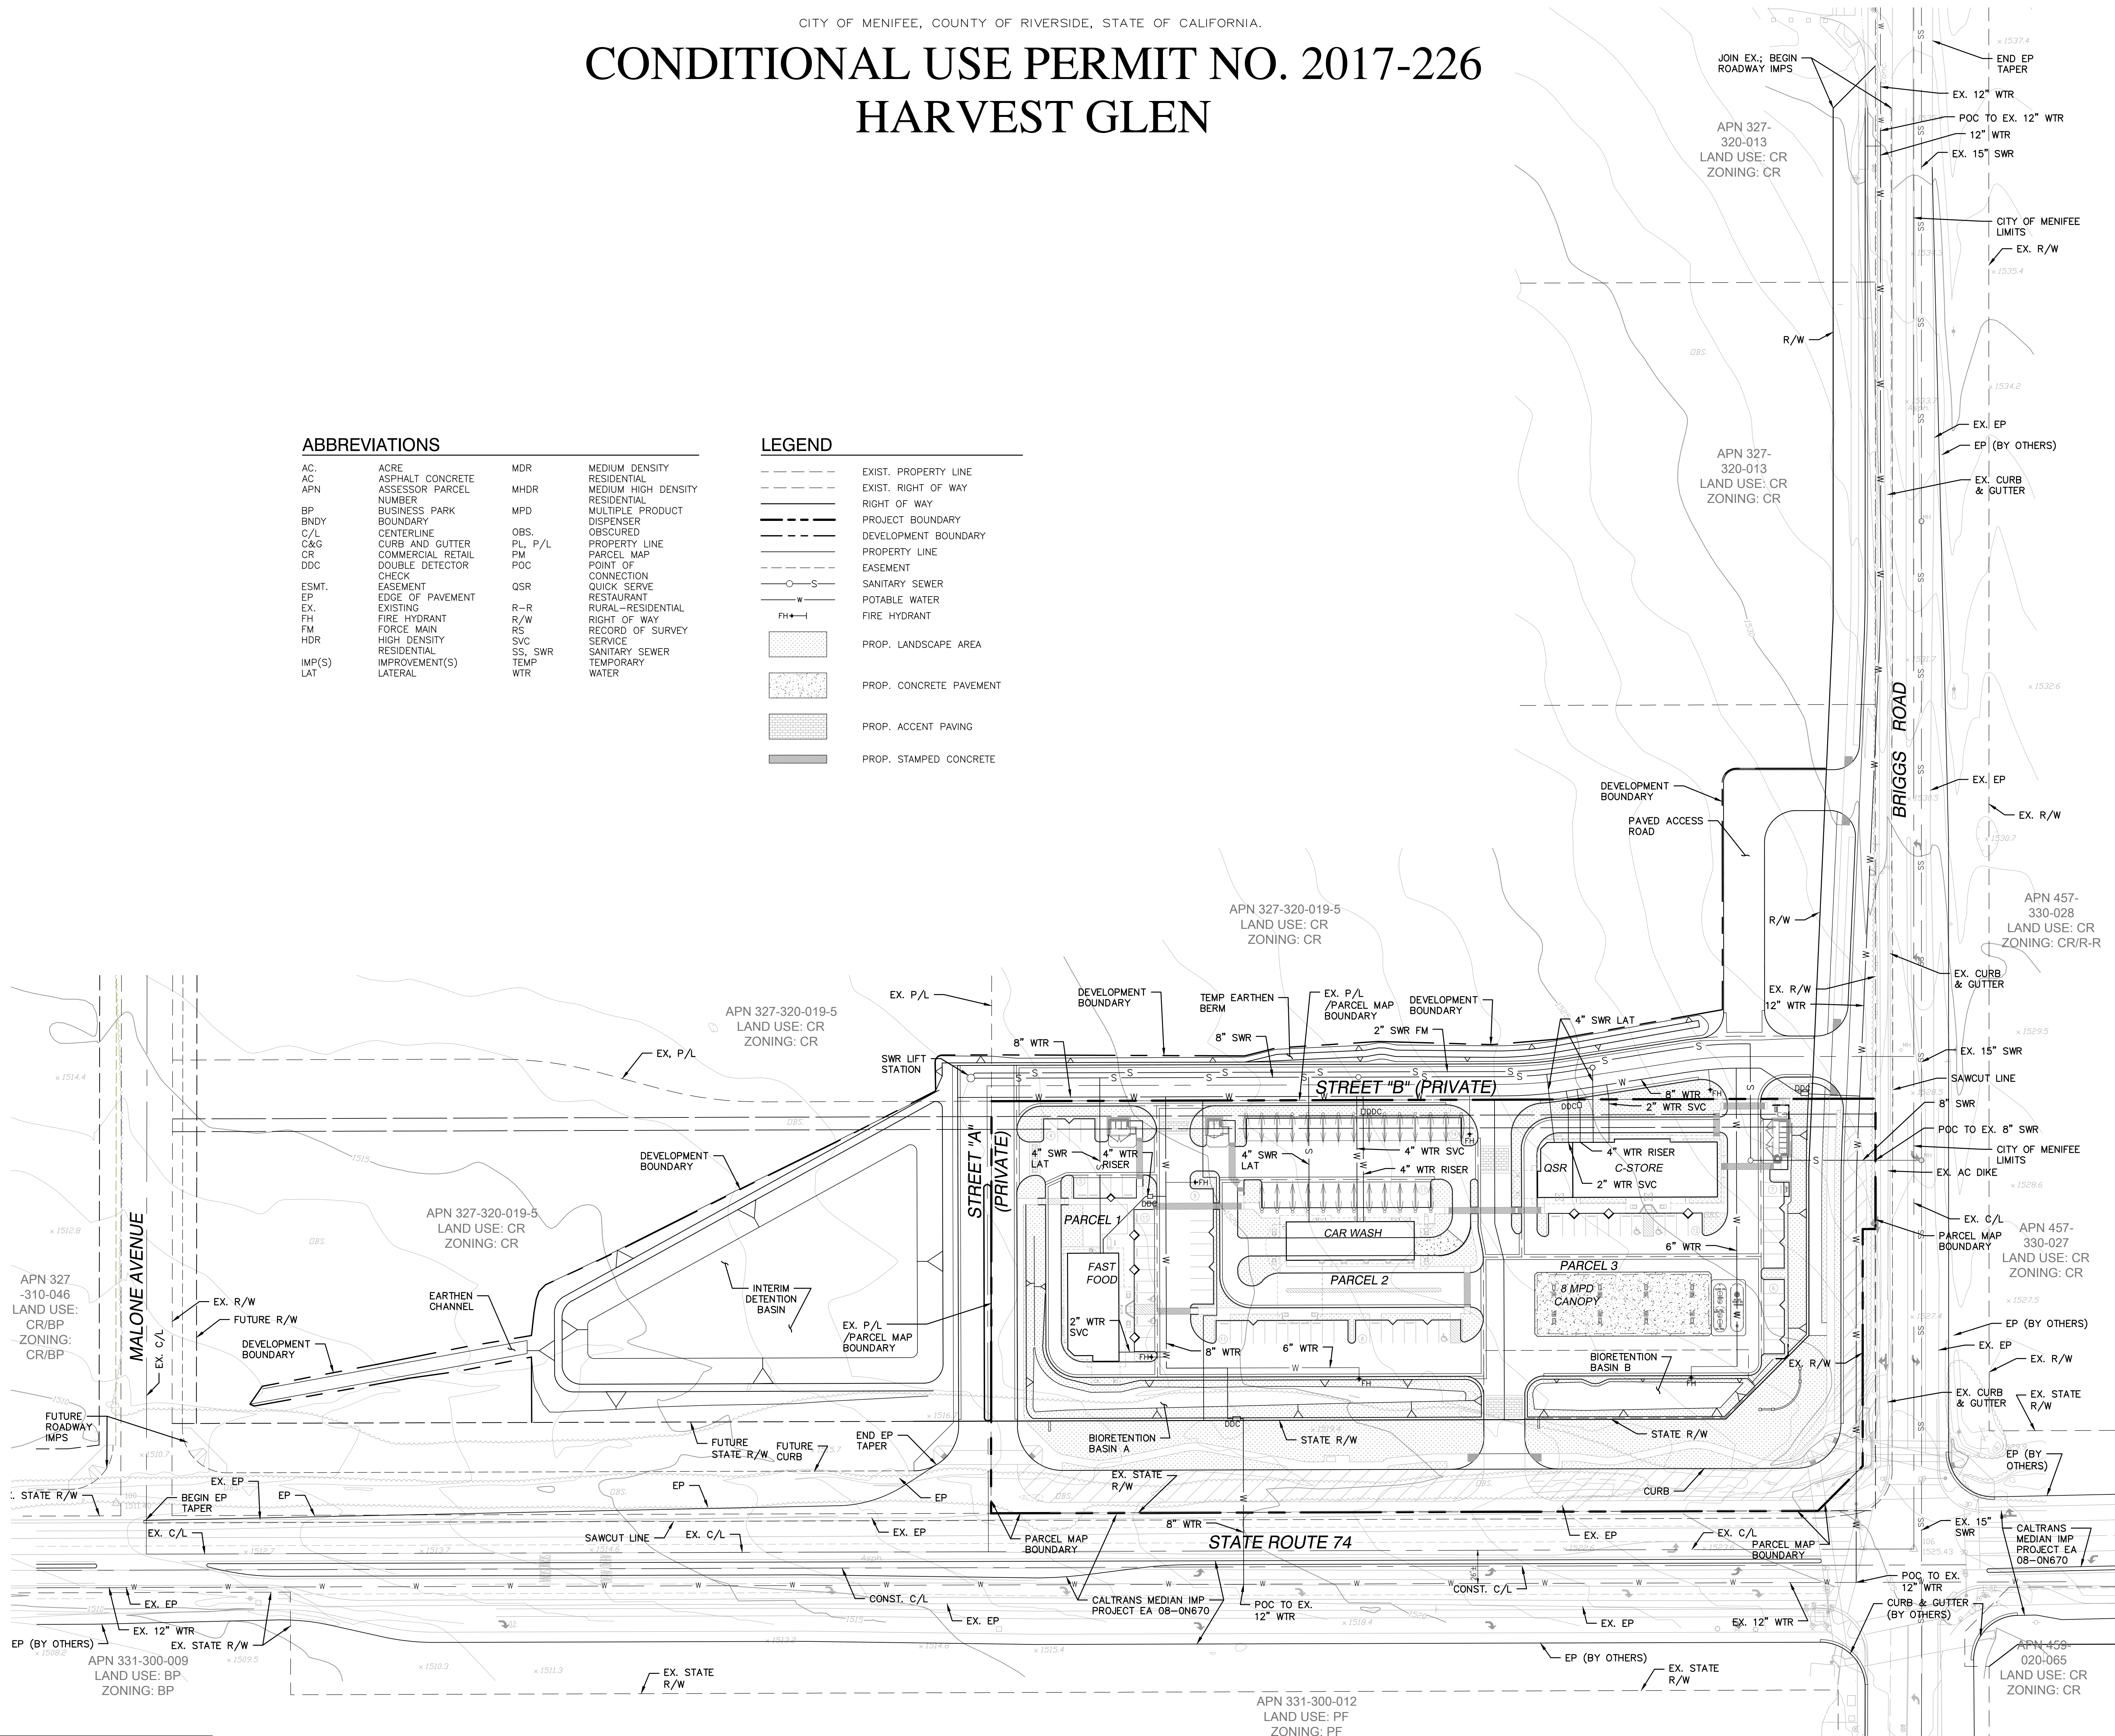

| NO | DESCRIPTION | APPR | DATE |
|----|-------------|------|------|
| | | | |
| | | | |
| | | | |

CONDITIONAL USE PERMIT NO. 2017-226
HARVEST GLEN
PRELIMINARY SEWER AND WATER PLAN
CITY OF MENEFEE, COUNTY OF RIVERSIDE,
STATE OF CALIFORNIA

ENGINEER:
ANDERSON CONSULTING ENGINEERS, INC.
12526 HIGH BLUFF DRIVE,
SUITE 300
SAN DIEGO, CA 92130
(858) 925-7918

SCALE: 1" = 50'
DATE: 5/21/2019
DESIGNED BY: JAA
DRAWN BY: IMC
CHECKED BY: JAA
SHEET 5 OF 5

GENERAL NOTES

- ASSESSOR'S PARCEL NUMBER (APN): 327-320-019 (POR) & 016 (POR.)
- THE PROPERTY SHOWN HEREON DOES NOT CONTAIN THE ENTIRE CONTIGUOUS OWNER.
- TOTAL APPROXIMATE AREA: 5.04 AC. GROSS, 3.62 AC. NET
- TOTAL APPROXIMATE AREA TO BE DEDICATED FOR RIGHT OF WAY: 1.40 AC.
- PROPOSED SCHEDULE "E" SUBDIVISION.
- ALL COMMERCIAL AREAS, LANDSCAPED AREAS, AND POST CONSTRUCTION BMPs SHALL BE MAINTAINED BY MERCHANT/OWNER ASSOCIATION.
- THE ENTIRE PROJECT SHALL BE MAINTAINED WITH AN AUTOMATIC IRRIGATION SYSTEM MAINTAINED BY MERCHANT/OWNER ASSOCIATION.
- ALL DIMENSIONS ARE TO FACE OF BUILDING WALLS AND CONCRETE CURB FACE.
- CONTOUR INTERVAL = 1 FOOT.
- NO REGULATED TREES EXIST ON SITE, UNLESS NOTED.
- THE LOCATIONS OF ALL EXISTING UTILITIES SHOWN ON THIS MAP ARE APPROXIMATE.
- SOURCE OF TOPOGRAPHY: INLAND AERIAL SURVEYS, INC., 7117 ARLINGTON AVENUE SUITE A, RIVERSIDE, CA 92503. PERFORMED ON DECEMBER 30, 2004.
- THIS PROJECT IS WITHIN MENIFEE NORTH SPECIFIC PLAN # 260 AMENDMENT # 2.
- THIS PROJECT IS WITHIN L&LMD NO. 89-1-C.
- THIS PROJECT IS NOT LOCATED IN A SPECIAL STUDIES ZONE.
- THIS PROPERTY IS NOT SUBJECT TO LIQUEFACTION OR OTHER GEOLOGIC HAZARDS AND IS NOT LOCATED IN A SPECIAL STUDIES ZONE.
- THIS PROPERTY IS NOT SUBJECT TO OVERFLOW, INUNDATION OR OTHER FLOOD HAZARDS.
- PROPOSED WASTE DISPOSAL SYSTEM: EMWD AND DUMPSTERS FOR SOLID WASTE.
- ALL BUILDINGS PROPOSED BY THE PROJECT WILL BE ERRECTED IN CONFORMANCE WITH THE UNIFORM BUILDING CODE OCCUPANCY GROUP AND CONSTRUCTION TYPE FOR COMMERCIAL CONSTRUCTION.
- PROJECT IS LOCATED ON PAGE 838, H-1, J-1 OF THOMAS BROTHERS (RIVERSIDE COUNTY, 2005 EDITION).
- THERE ARE NO KNOWN EXISTING WELLS ON THE PROPERTY OR WITHIN 200' OF THE PROPERTY BOUNDARY.
- THIS PROJECT WILL NOT IMPLEMENT THE USE OF A SEPTIC SYSTEM.

LEGAL DESCRIPTION

PARCEL "C" OF NOTICE OF LOT LINE ADJUSTMENT RECORDED JULY 19, 2018 AS INSTRUMENT NO. 2018-0291969 OF OFFICIAL RECORDS, BEING ALL OF LOT 268-B AND A PORTION OF LOTS 269 OF ROMOLA FARMS NO. 5 IN THE COUNTY OF RIVERSIDE, STATE OF CALIFORNIA, AS SHOWN BY MAP ON FILE IN BOOK 14, PAGES 44 AND 45 OF MAPS, RIVERSIDE COUNTY RECORDS.

EXCEPTING FROM LOT 268-B THAT PORTION CONVEYED TO THE COUNTY OF RIVERSIDE BY DEED RECORDED SEPTEMBER 28, 1966 AS INSTRUMENT NO. 96186 OF OFFICIAL RECORDS.

ALSO EXCEPTING FROM LOT 268-B THAT PORTION CONVEYED TO THE COUNTY OF RIVERSIDE BY DEED RECORDED JUNE 22, 1994 AS INSTRUMENT NO. 94-253036, OF OFFICIAL RECORDS.

WATER QUALITY

A COMPLETE WATER QUALITY MANAGEMENT PLAN (WQMP) IS BEING PROVIDED WITH THE PROJECT SPECIFIC WQMP. THE PLAN IDENTIFIES THE FOLLOWING:

- POTENTIAL POST-PROJECT POLLUTANTS AND HYDROLOGICAL IMPACTS ASSOCIATED WITH THE DEVELOPMENT.
- PROPOSED MITIGATION MEASURES (BEST MANAGEMENT PRACTICES - BMP'S) FOR TREATMENT OF IDENTIFIED IMPACTS INCLUDING SITE DESIGN, SOURCE CONTROL, AND TREATMENT CONTROL POST-PROJECT BMP'S.
- SUSTAINABLE FUNDING AND MAINTENANCE MECHANISMS FOR THE AFOREMENTIONED BEST MANAGEMENT PRACTICES - BMP'S. A MAINTENANCE AGREEMENT TO BE APPROVED BY CITY COUNCIL WILL BE REQUIRED PRIOR TO ISSUANCE OF GRADING PERMIT.

FLOOD ZONING

THIS AREA IS NOT WITHIN A FLOOD HAZARD AREA. THE AREA IS CONSIDERED A ZONE X (UNSHADED) FLOOD HAZARD WHICH IS OUTSIDE OF THE 100-YEAR FLOOD LIMITS.

OWNER

BRIGGS & 74, LLC
PO BOX L
RANCHO SANTA FE, CA 92067
DLONG@RANCONGROUP.COM
(951) 200-2367

APPLICANT

DANNY LONG
MRS6 LLC/RANCON GROUP
41391 KALMIA STREET, SUITE 200
MURRIETA, CA 92562
DLONG@RANCONGROUP.COM
(951) 200-2367

PREPARER


ANDERSON CONSULTING ENGINEERS, INC
12526 HIGH BLUFF DRIVE, SUITE 300
SAN DIEGO, CA 92130
JEFF@ACE-CIVIL.COM
(858) 925-7918

| NO | DESCRIPTION | APPR | DATE |
|----|-------------|------|------|
| | | | |
| | | | |
| | | | |

CITY OF MENIFEE, COUNTY OF RIVERSIDE, STATE OF CALIFORNIA.

**TENTATIVE PARCEL MAP
NO. 37380**

| SHEET INDEX | |
|-------------|------------------|
| SHEET NO. | SHEET NAME |
| 1 OF 5 | TITLE SHEET |
| 2 OF 5 | TYPICAL SECTIONS |
| 3 OF 5 | SITE PLAN |
| 4 OF 5 | SITE PLAN |
| 5 OF 5 | PARCEL EXHIBIT |

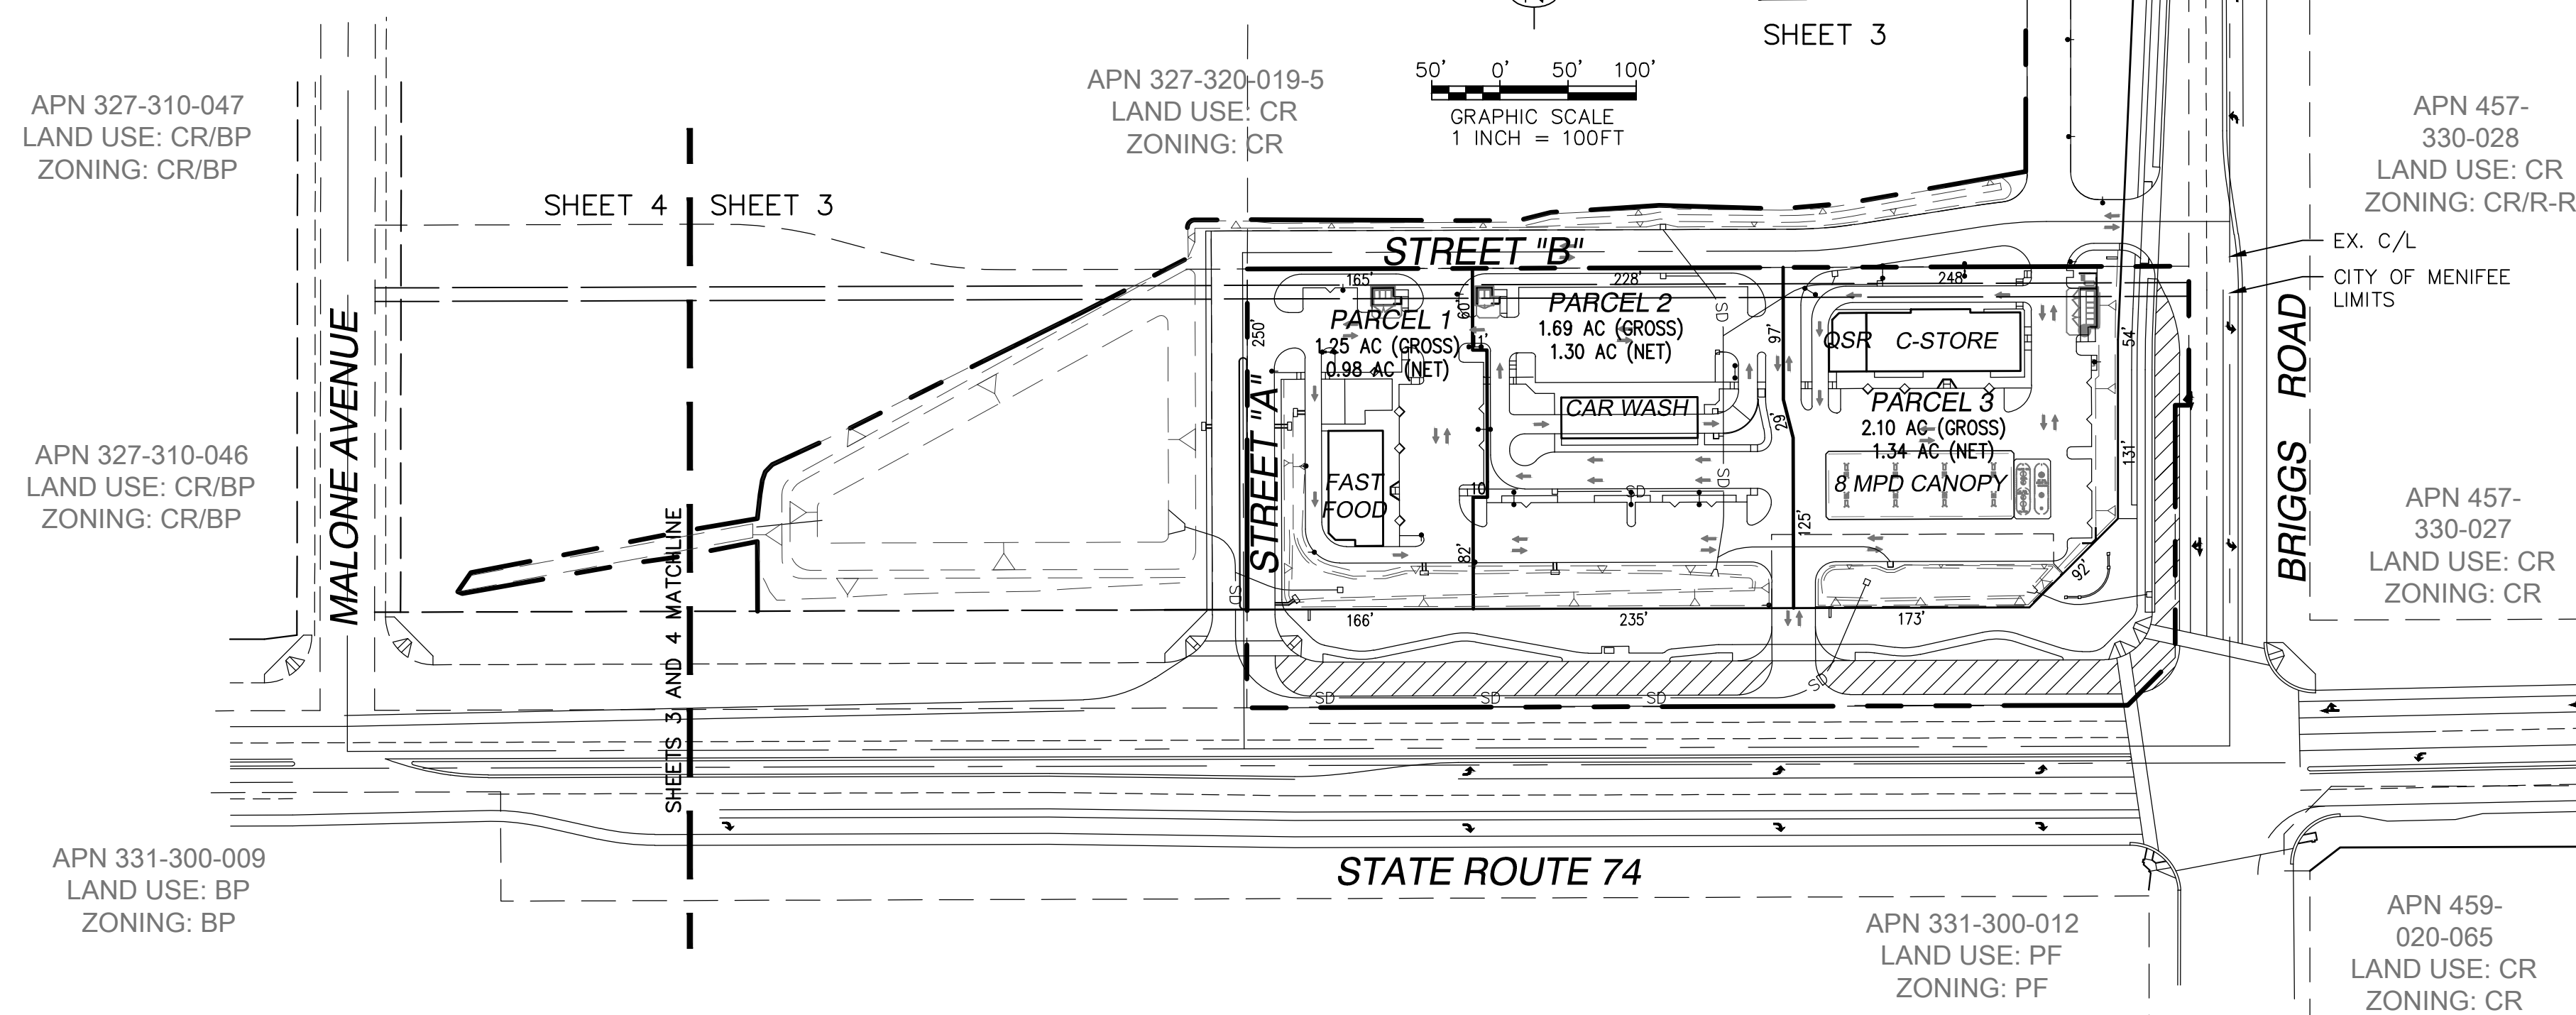


INDEX MAP

SCALE: 1" = 100'

LEGEND

- (XX.XX) EXISTING ELEVATION
- EXISTING PROPERTY LINE
- EXISTING RIGHT OF WAY
- PROJECT BOUNDARY
- 265 MAJOR CONTOUR
- 264 MINOR CONTOUR
- 1.0% SLOPE INDICATOR
- SLOPE (IF > 3:1)
- DAYLIGHT LINE
- FLOW LINE
- GRADE BREAK/RIDGE LINE
- STORM DRAIN
- MODIFIED UNDERSIDEWALK DRAIN
- CONCRETE PAVEMENT
- STAMPED CONCRETE
- ACCENT PAVING
- LANDSCAPE AREA
- STREET LIGHT

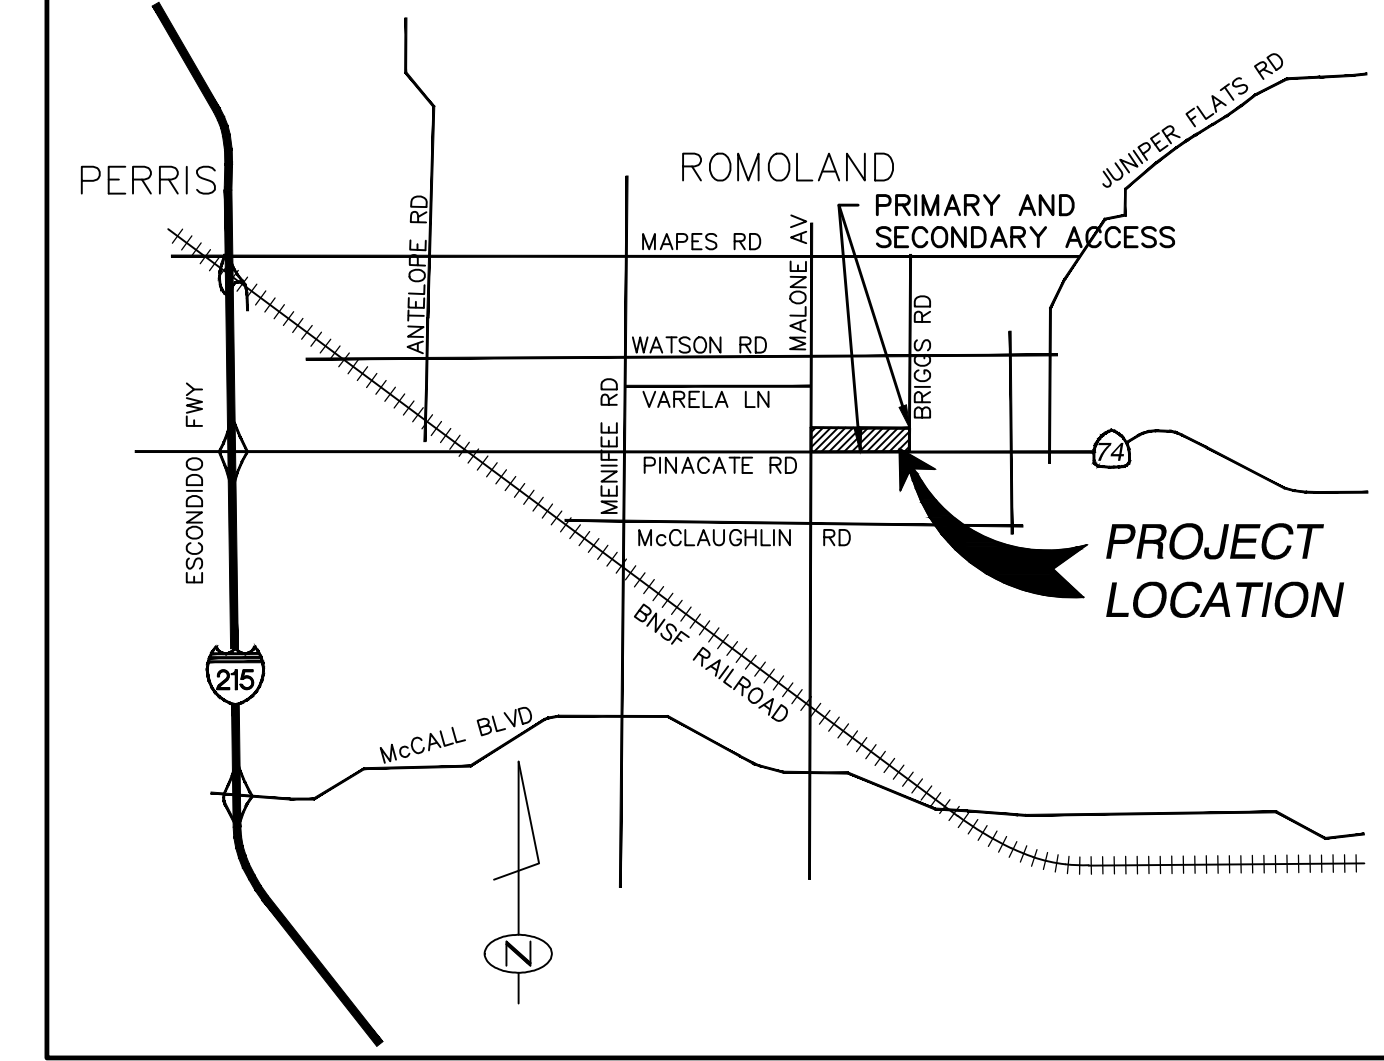

VICINITY MAP

NOT TO SCALE

UTILITY PUREYORS

- WATER:** EASTERN MUNICIPAL WATER DISTRICT
2270 TRUMBLE ROAD
PERRIS, CA. 92572
(951) 928-3777
- SEWER:** EASTERN MUNICIPAL WATER DISTRICT
2270 TRUMBLE ROAD
PERRIS, CA. 92572
(951) 928-3777
- ELECTRIC:** SOUTHERN CALIFORNIA EDISON
6100 MENIFEE ROAD
ROMOLAND, CA 92585
(800) 655-4555
- NATURAL GAS:** SOUTHERN CALIFORNIA GAS COMPANY
527 NORTH SAN JACINTO STREET
HEMET, CA 92543
(800) 427-2200
- TELEPHONE:** VERIZON
30098 HAUN RD #320
MENIFEE, CA 92584
(951) 723-8452
- CABLE:** TIME WARNER CABLE
4077 W. STETSON AVENUE
HEMET, CA 92545
(888) 255-5789

SCHOOL DISTRICTS

- SCHOOL DISTRICT:** ROMOLAND SCHOOL DISTRICT (GRADES K-8)
25900 LEON ROAD
HOMELAND, CA 92548
(951) 943-6369
- PERRIS UNION HIGH SCHOOL (GRADES 9-12)
155 EAST FOURTH STREET
PERRIS, CA 92570
(951) 943-6369

ABBREVIATIONS

| | | | |
|--------|--------------------------------|---------|---------------------------------|
| AC | ACRE | MDR | MEDIUM DENSITY RESIDENTIAL |
| ASPH | ASPHALT CONCRETE | MHDR | MEDIUM HIGH DENSITY RESIDENTIAL |
| APN | ASSESSOR PARCEL NUMBER | MPD | MULTIPLE PRODUCT DISPENSER |
| BNDY | BOUNDARY | P.C. | PARCEL MAP |
| C/L | CENTERLINE | PE | PAD ELEVATION |
| C&G | CURB AND GUTTER | PL, P/L | PROPERTY LINE |
| CONC. | CONCRETE | POC | POINT OF CONNECTION |
| CONST. | CONSTRUCT | PROP. | PROPOSED |
| CY | CUBIC YARD | QSR | QUICK SERVE RESTAURANT |
| DG | DECOMPOSED GRANITE | R-R | RURAL-RESIDENTIAL |
| DDC | DOUBLE DETECTOR CHECK EASEMENT | R/W | RIGHT OF WAY |
| ESMT. | EDGE OF PAVEMENT | RS | RECORD OF SURVEY |
| EP | EXISTING | SD | STORM DRAIN |
| FG | FINISH GRADE | SS, SWR | SANITARY SEWER |
| FF | FINISH FLOOR | SW, S/W | SIDEWALK |
| FL | FLOW LINE | SVC | SERVICE |
| FM | FORCE MAIN | TC | TEMPORARY |
| FS | FINISH SURFACE | TEMP | TEMPORARY |
| GB | GRADE BREAK | TW | TOP OF WALL |
| HDR | HIGH DENSITY RESIDENTIAL | TYP | TYPICAL |
| HP | HIGH POINT | VAR | VARIES |
| IMP(S) | IMPROVEMENT(S) | WTR | POTABLE WATER |
| INV | INVERT | | |
| LAT | LATERAL | | |
| LP | LOW POINT | | |


ZONING AND LAND USE SUMMARY

| DESCRIPTION | ON-SITE | NORTH | SOUTH | EAST | WEST |
|-------------------|-------------------------|------------------------------------|-----------------------------|--|---------------------------------------|
| GENERAL PLAN | CR | MDR | CR | OS-R, CR | MDR, BP |
| EXISTING ZONING | SP-260 PA 44 COMMERCIAL | SP-260 PA 23A HIGH DENSITY RES | SP-301 PA 2 & 9 | PA 26 HIGH DENSITY RES PA 27 COMMERCIAL | PA 19 COMMERCIAL/BUSINESS PARK |
| PROPOSED ZONING | SP-260 PA 44 COMMERCIAL | SP-260 PA 23A MED HIGH DENSITY RES | SP-301 PA 2 & 9 | SP-260 PA 26 HIGH DENSITY RES PA 27 COMMERCIAL | SP-260 PA 19 COMMERCIAL/BUSINESS PARK |
| EXISTING LAND USE | VACANT | VACANT/COMMUNITY PARK | HIGH SCHOOL | VACANT | VACANT |
| PROPOSED LAND USE | COMMERCIAL | HIGH DENSITY RES/RECREATION | MED DENSITY RES/HIGH SCHOOL | COMMERCIAL | COMMERCIAL/BUSINESS PARK |

PARKING SUMMARY

| LOCATION | COMMERCIAL TYPE | DESCRIPTION | SPACE | NO. OF EMPLOYEES | REQUIRED SPACES | REQUIRED HANDICAP SPACES |
|----------|-----------------|---|-------|------------------|-----------------|--------------------------|
| PARCEL 1 | FAST FOOD | 1 SPACE/45 SF OF SERVING AREA, PLUS 1 SPACE/2 EMPLOYEES | 1,270 | 6 | 32 | 2 |
| PARCEL 2 | CAR WASH | 1 SPACE/3 EMPLOYEES | N/A | 6 | 2 | 1 |
| PARCEL 3 | QSR | 1 SPACE/45 SF OF SERVING AREA, PLUS 1 SPACE/2 EMPLOYEES | 425 | 4 | 12 | 1 |
| | C-STORE | 1 SPACE/200 SF | 4,967 | 2 | 25 | 1 |
| | | | | TOTAL: | 71 | 4 |
| | | | | SPACES PROVIDED: | 73 | 5 |

PER THE 2016 CALIFORNIA GREEN BUILDING CODE TABLE 5.106.2, A TOTAL OF SIX (6) STALLS ARE REQUIRED FOR CLEAN AIR VEHICLES, PER TABLE 5.106.5.3, FOUR (4) STALLS ARE REQUIRED TO HAVE FUTURE ELECTRIC VEHICLE CHARGING STATIONS

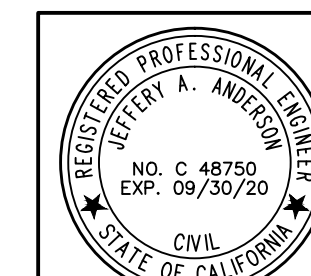

JEFFREY A. ANDERSON
R.C.E. C48750
5-21-19
DATE
EXPIRES 09-30-20



TENTATIVE PARCEL MAP NO. 37380

TITLE SHEET




CITY OF MENIFEE, COUNTY OF RIVERSIDE, STATE OF CALIFORNIA

| | | | |
|-----------|-------------------------------------|--|---|
| ENGINEER: | ANDERSON CONSULTING ENGINEERS, INC. | 12526 HIGH BLUFF DRIVE, SUITE 300 SAN DIEGO, CA 92130 (858) 925-7918 | SCALE: N/A DATE: 5/21/2019 DESIGNED BY: JAA DRAWN BY: IMC CHECKED BY: JAA |
| | | | SHEET 1 OF 5 |

TENTATIVE PARCEL MAP NO. 37380

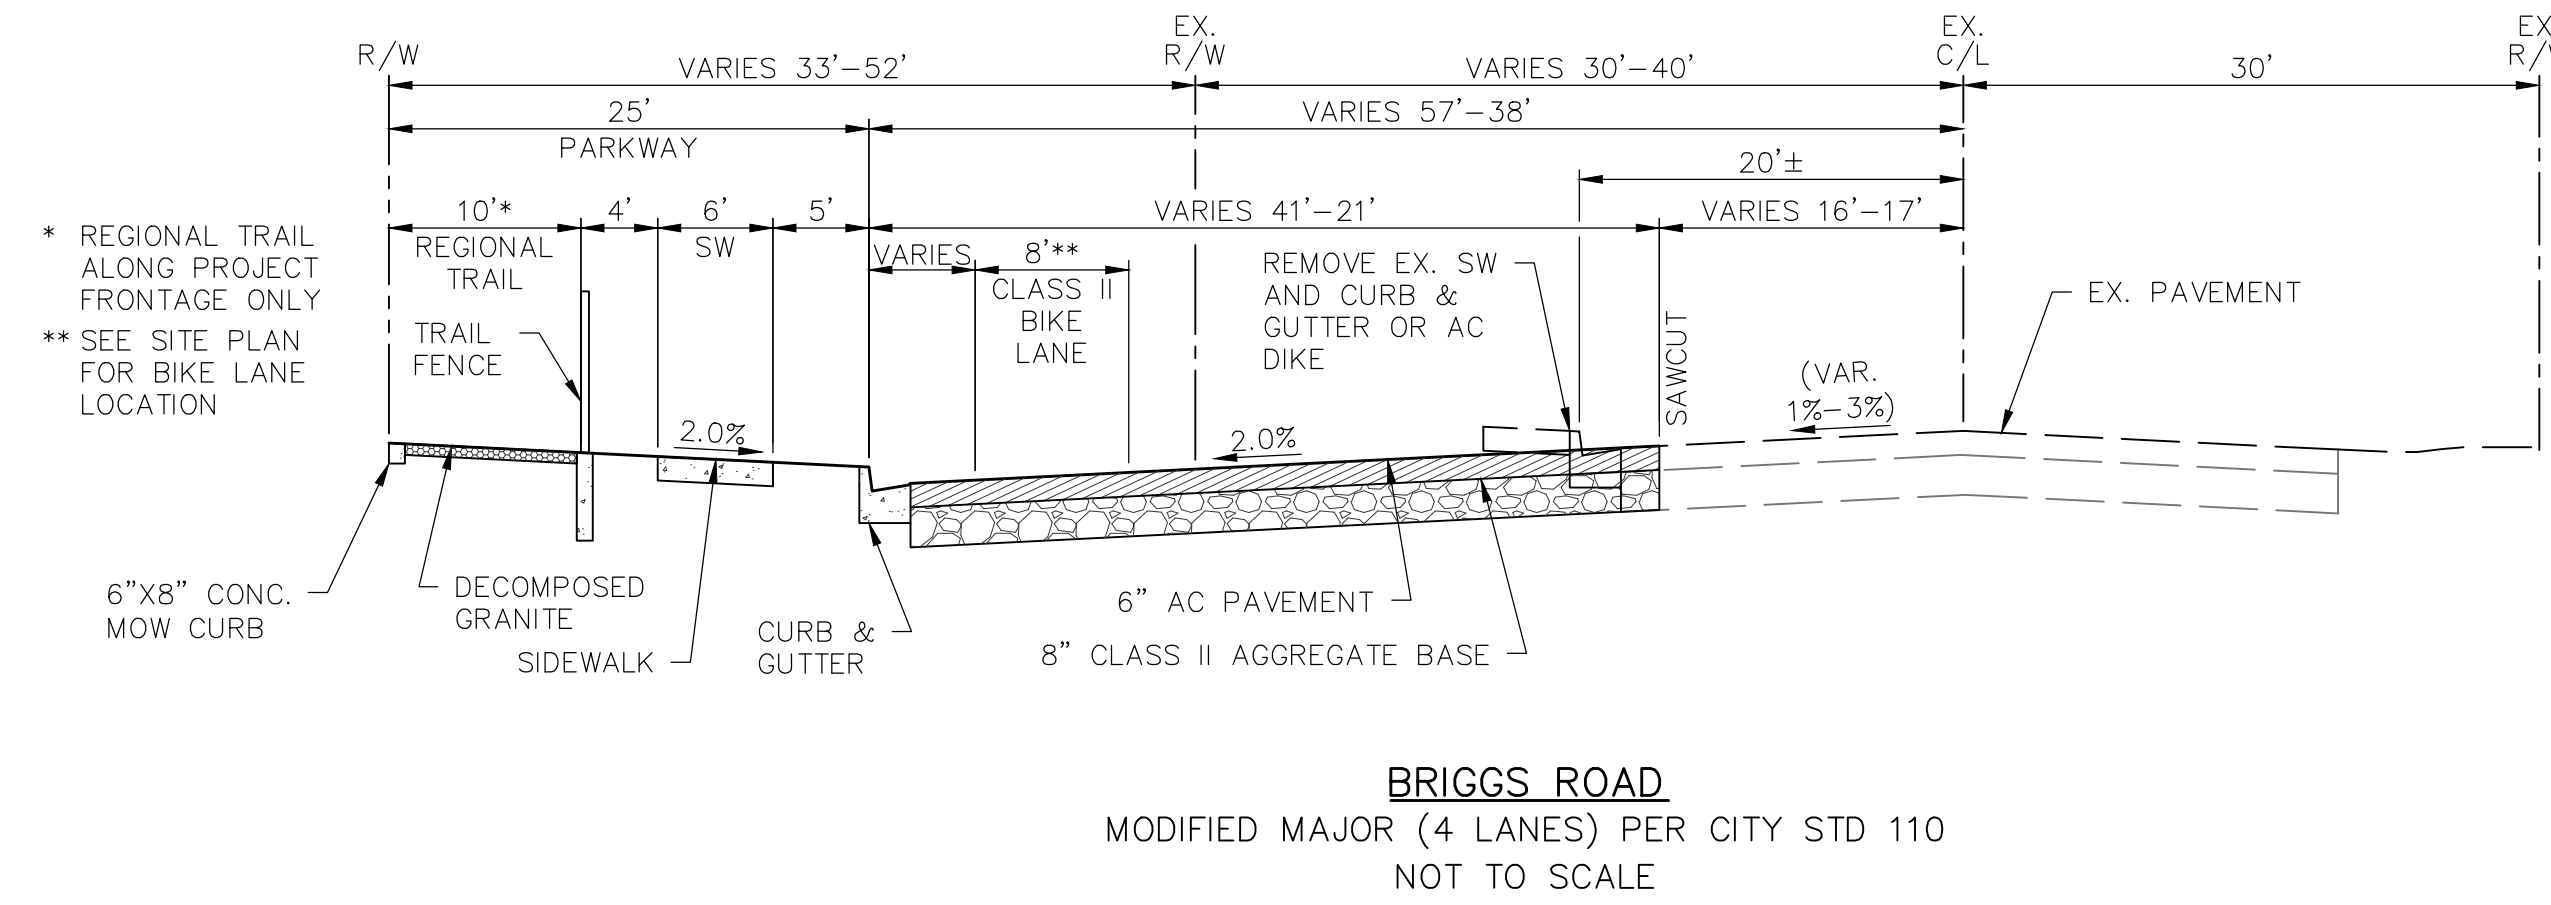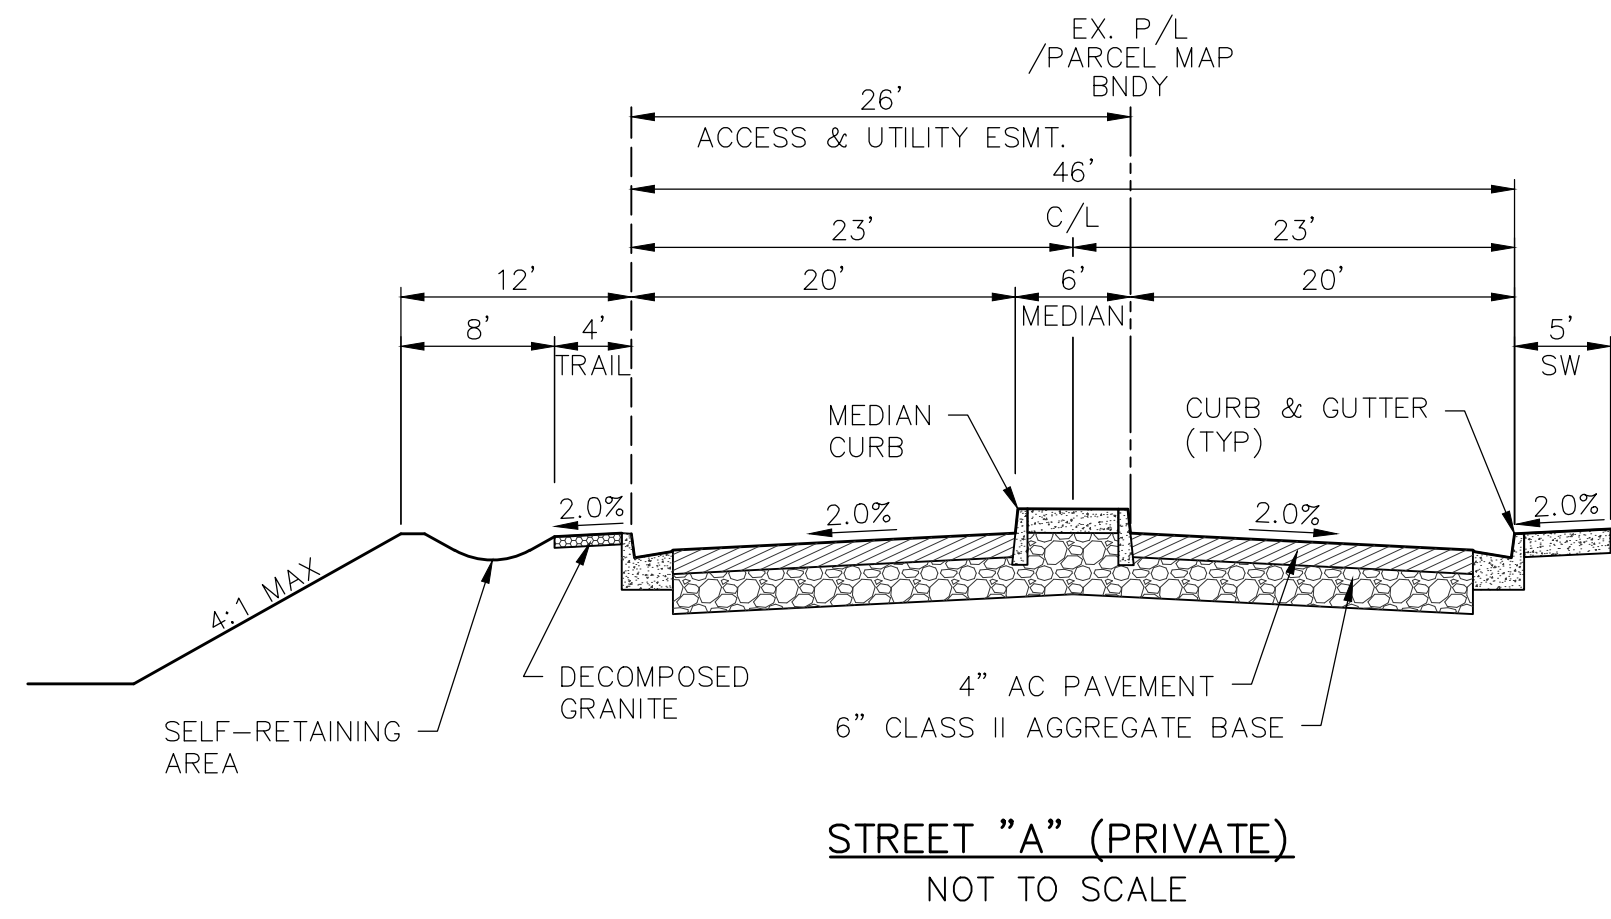

NOTE: FINAL PAVEMENT SECTION TO BE DETERMINED BY SOILS ENGINEER FOLLOWING FIELD TESTING

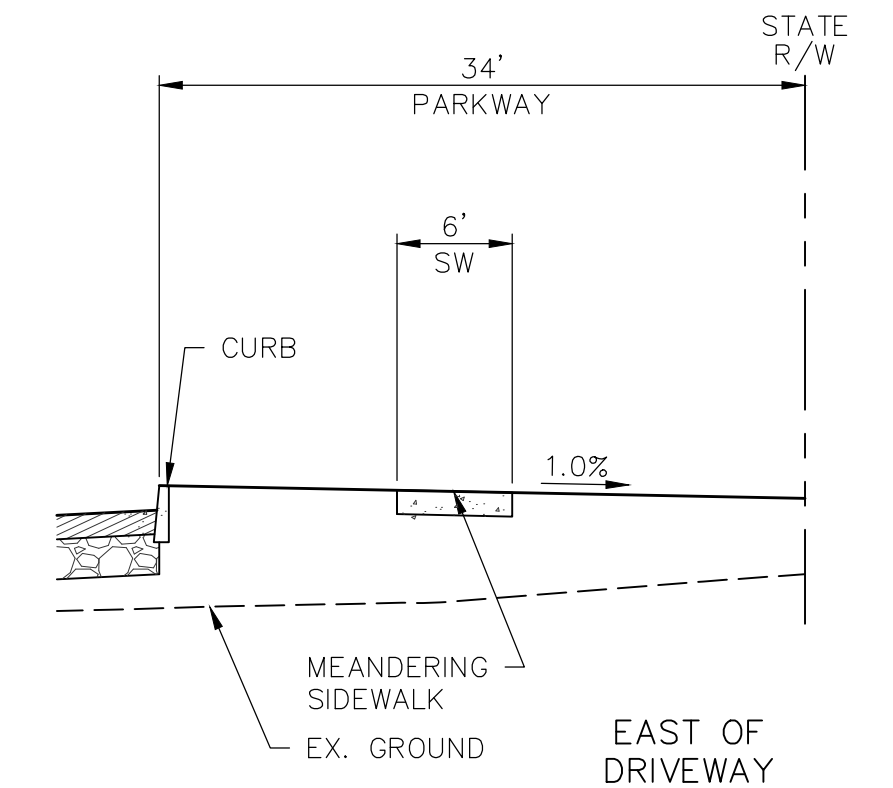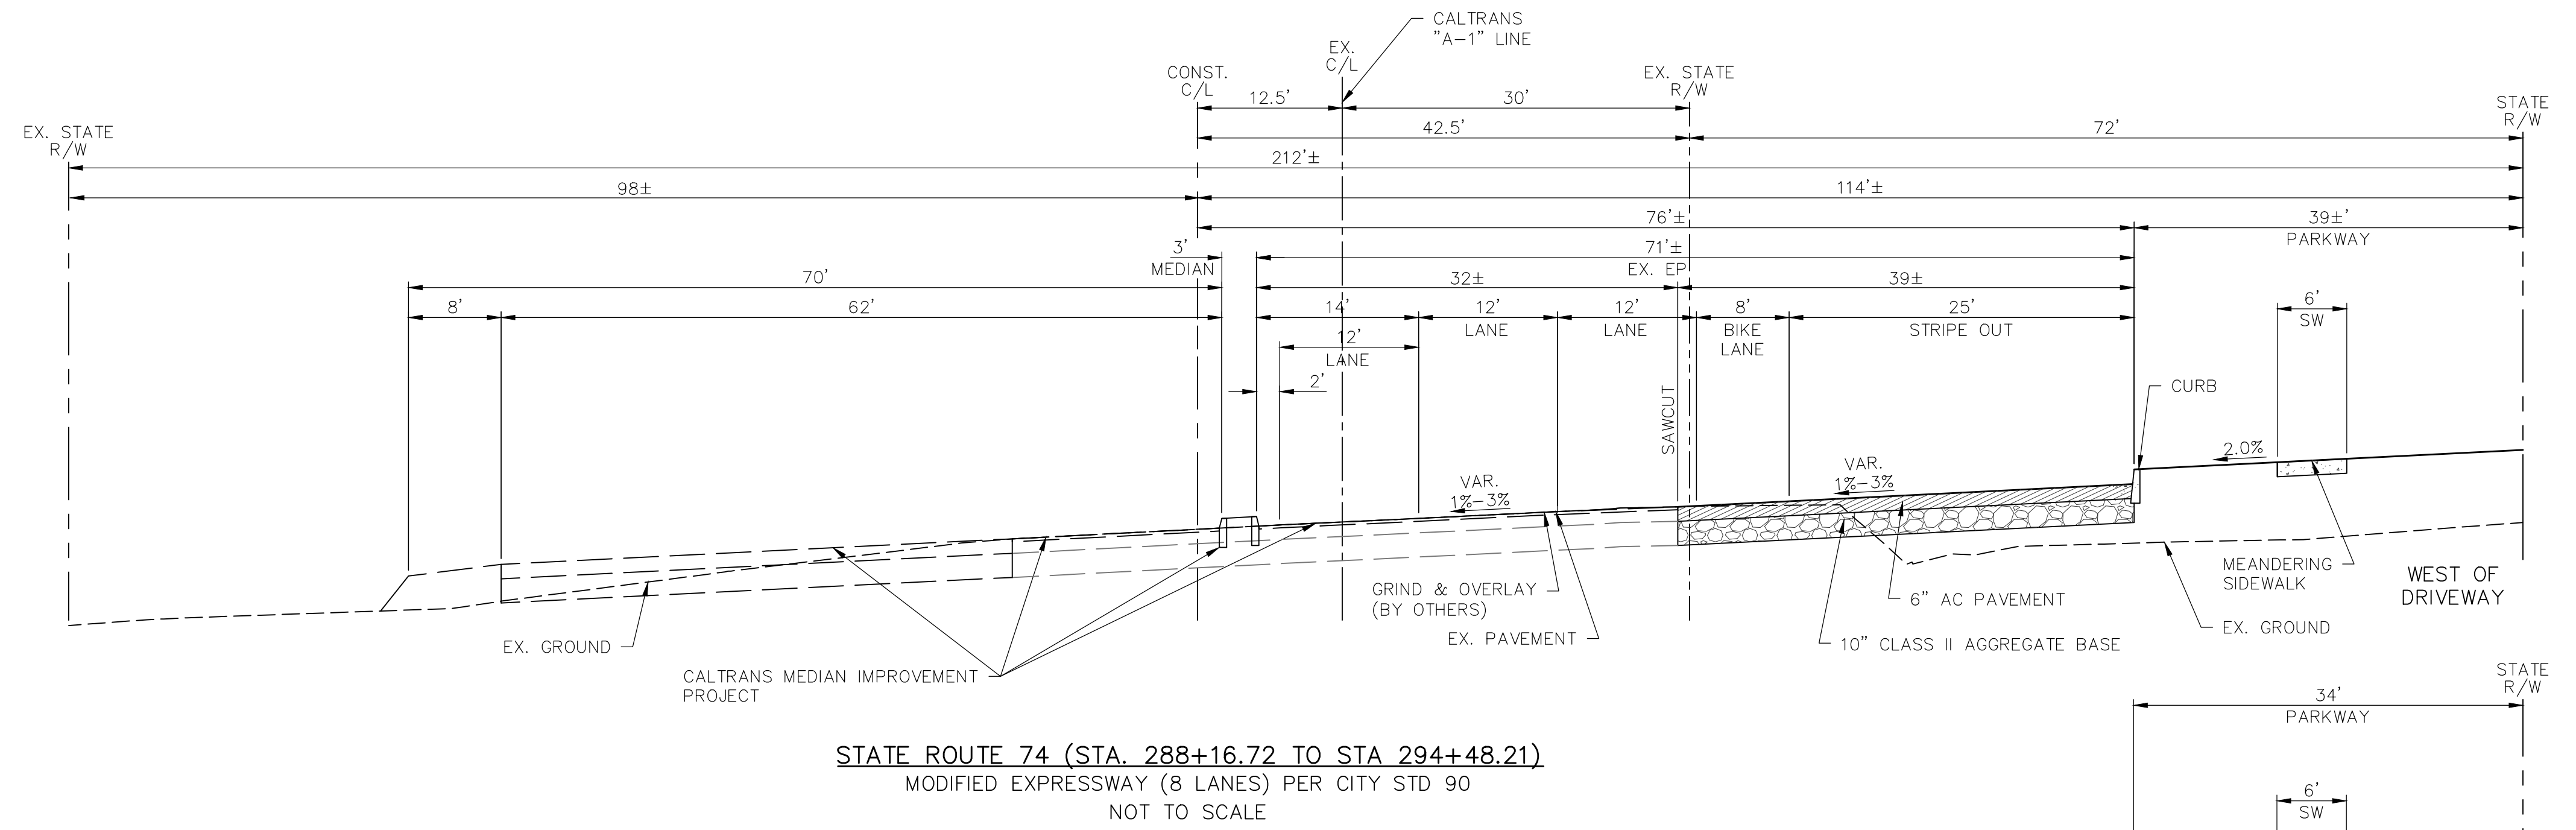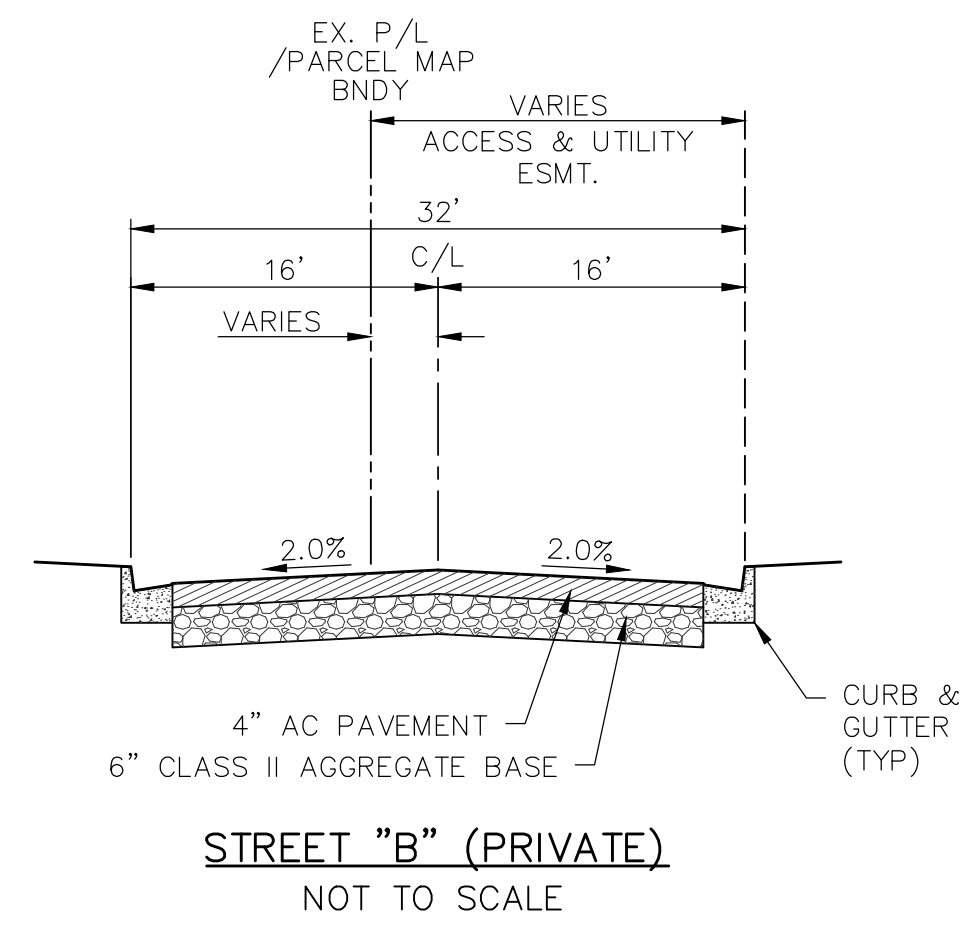

Type text here

| NO | DESCRIPTION | APPR | DATE |
|----|-------------|------|------|
| | | | |
| | | | |
| | | | |

REGISTERED PROFESSIONAL ENGINEER
JEFFERY A. ANDERSON
NO. C 48750
EXP. 09/30/20
CIVIL
STATE OF CALIFORNIA

Jeffery A. Anderson

JEFFERY A. ANDERSON
R.C.E. C48750

5-21-19

DATE
EXPIRES 09-30-20

TENTATIVE PARCEL MAP NO. 37380

TYPICAL SECTIONS


CITY OF MENIFEE, COUNTY OF RIVERSIDE,
STATE OF CALIFORNIA

| | |
|---|--|
| <p>ENGINEER: ANDERSON CONSULTING ENGINEERS, INC.</p> <p>12526 HIGH BLUFF DRIVE, SUITE 300 SAN DIEGO, CA 92130 (858) 925-7918</p> | <p>SCALE: N/A DATE: 5/21/2019 DESIGNED BY: JAA DRAWN BY: IMC CHECKED BY: JAA</p> <p style="text-align: right;">SHEET 2 OF 5</p> |
|---|--|

TENTATIVE PARCEL MAP NO. 37380


EASEMENT NOTES

- 1. EXISTING P.U.E. IN FAVOR OF THE SOUTHERN CALIFORNIA TELEPHONE COMPANY REC. DEC. 5, 1936 IN BOOK 303, PAGE 577, O.R.
- 2. EXISTING P.U.E. IN FAVOR OF THE SOUTHERN CALIFORNIA TELEPHONE COMPANY REC. FEB. 4, 1937 IN BOOK 311, PAGE 389, O.R.
- 3. EXISTING EASEMENT FOR SLOPE AND INCIDENTAL PURPOSES IN FAVOR OF THE STATE OF CALIFORNIA REC. MAY 12, 1970 AS INST. NO. 44270, O.R.
- 4. EXISTING P.U.E. IN FAVOR OF THE SOUTHERN SIERRAS POWER COMPANY REC. APR. 11, 1928 IN BOOK 758, PAGE 180 OF DEEDS. (WIDTH UNKNOWN)

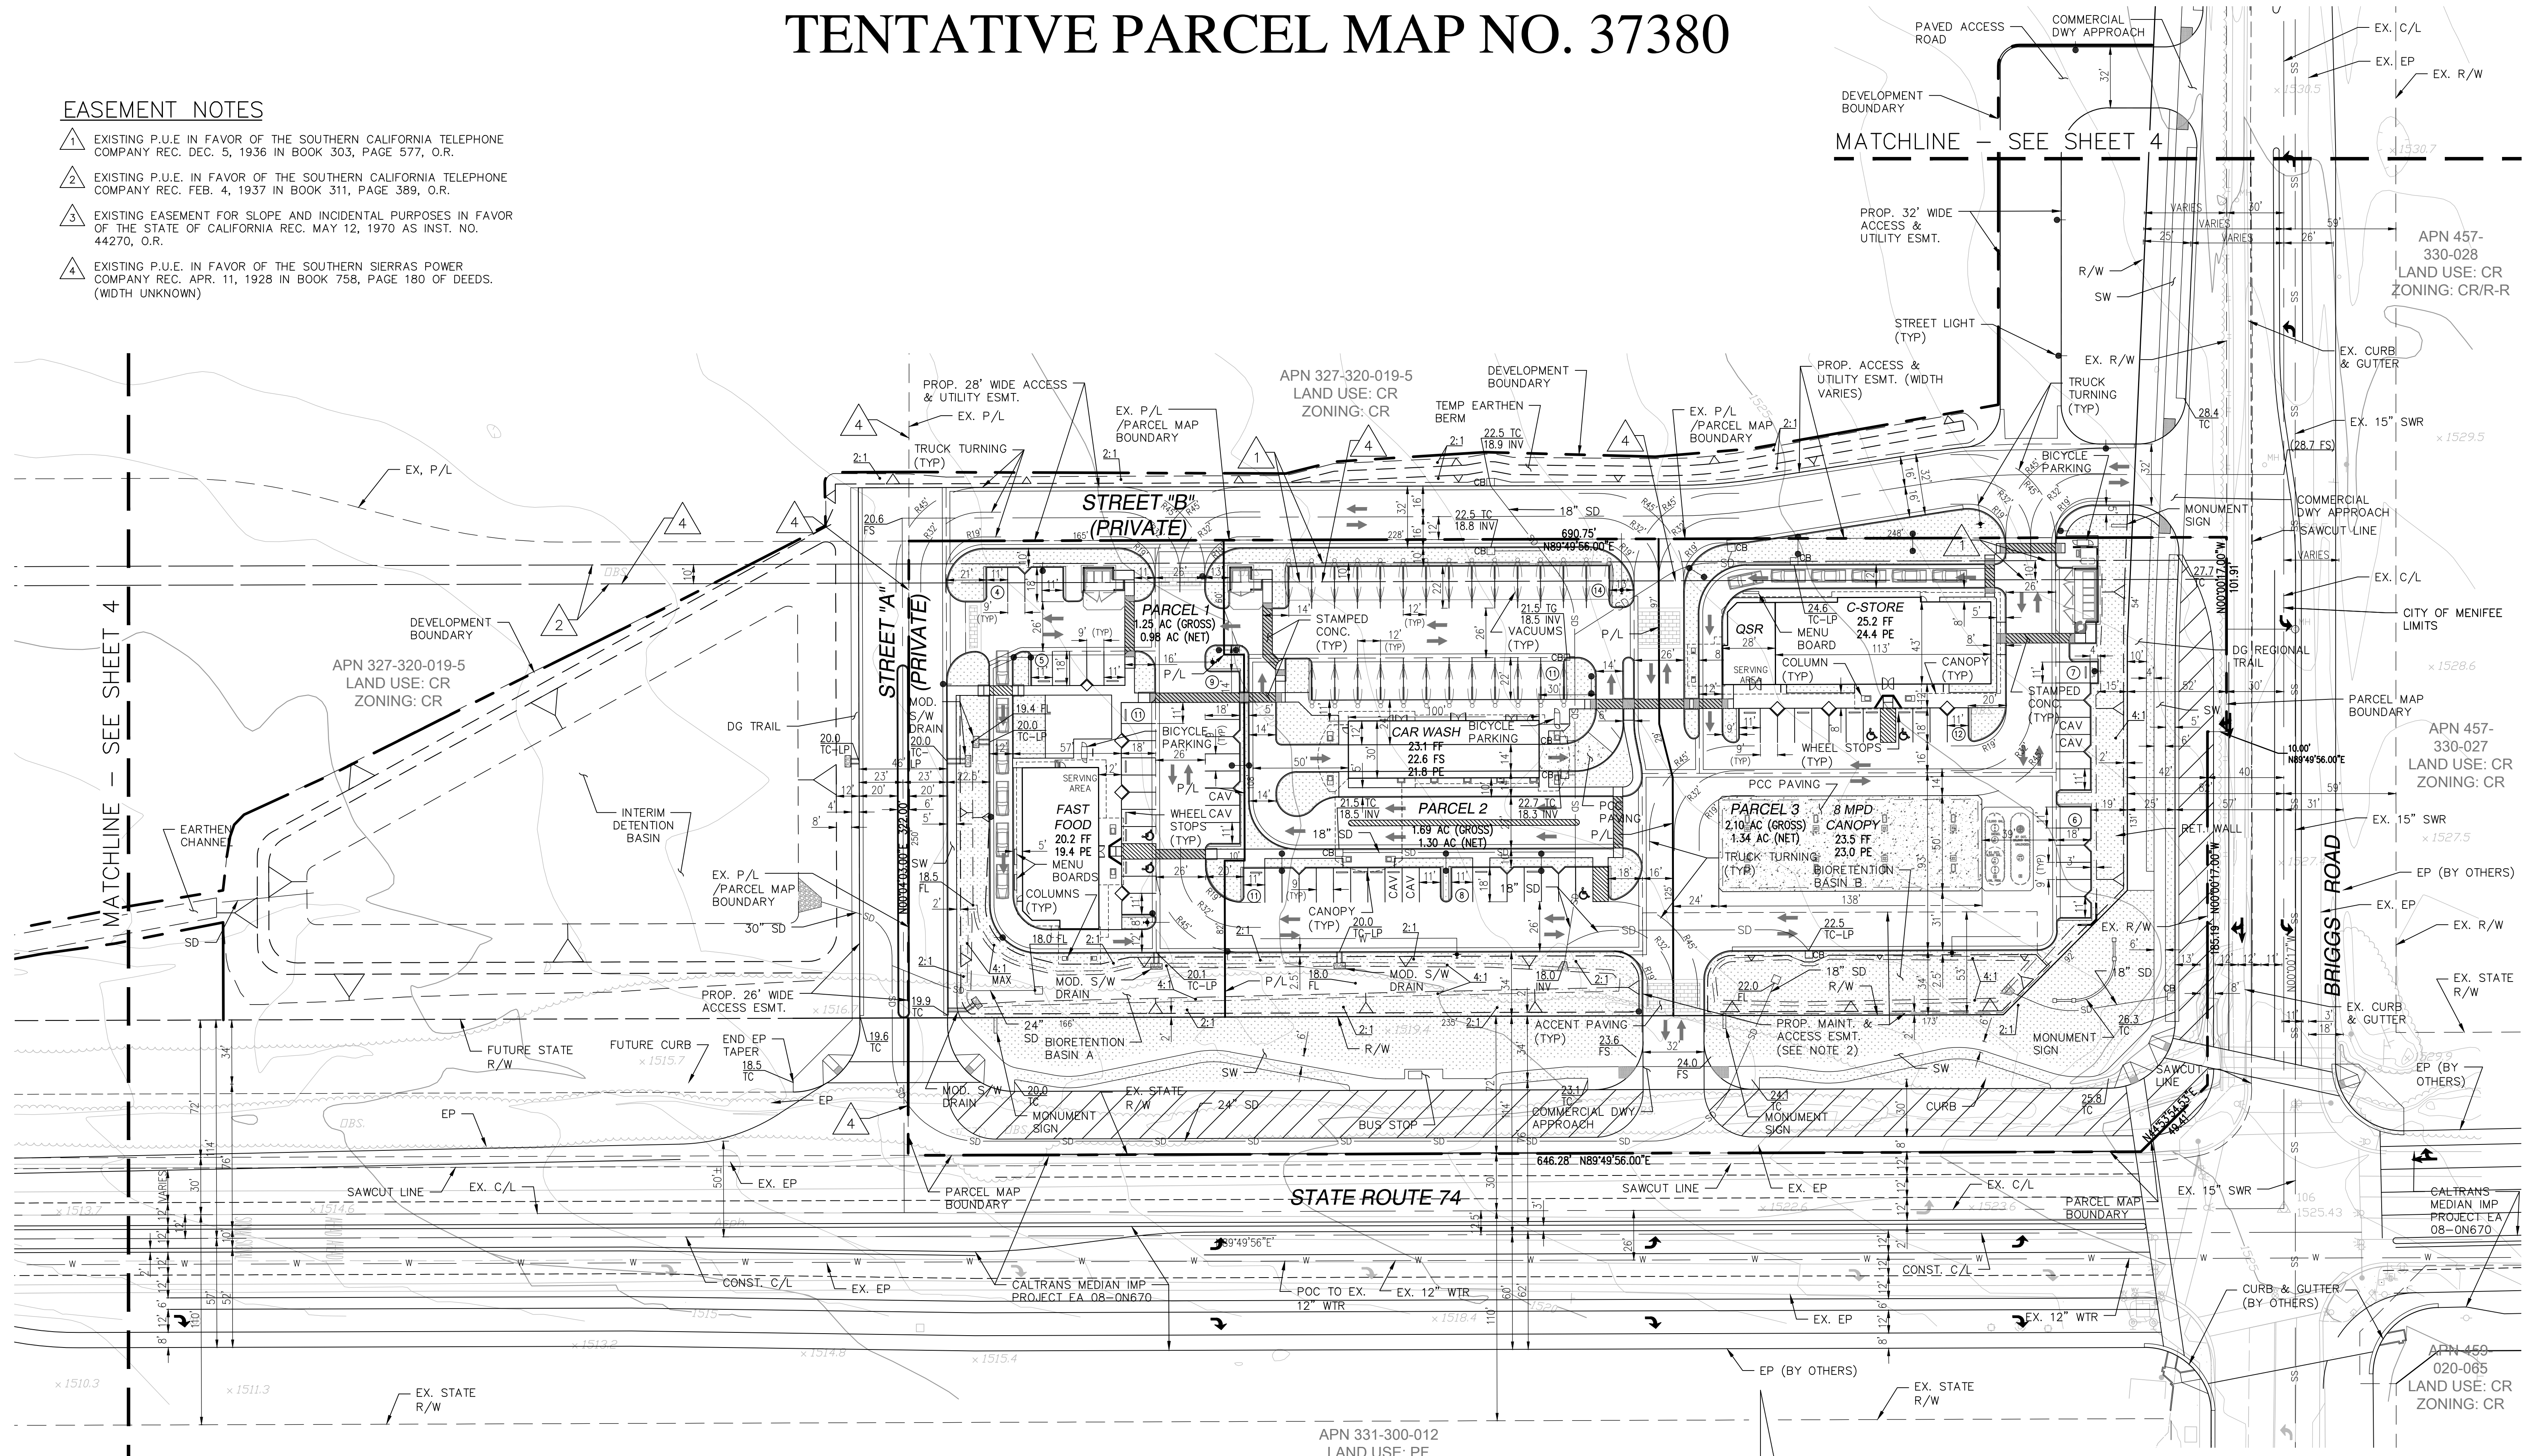

NOTES

1. PROPOSED BLANKET EASEMENT FOR RECIPROCAL ACCESS AND PARKING, UTILITIES, DRAINAGE, AND MAINTENANCE SHALL BE RECORDED ON PARCELS 1-3 AS PART OF THIS PARCEL MAP.
2. PROPOSED MAINTENANCE AND ACCESS EASEMENT IN FAVOR OF THE CITY OF MENIFEE.

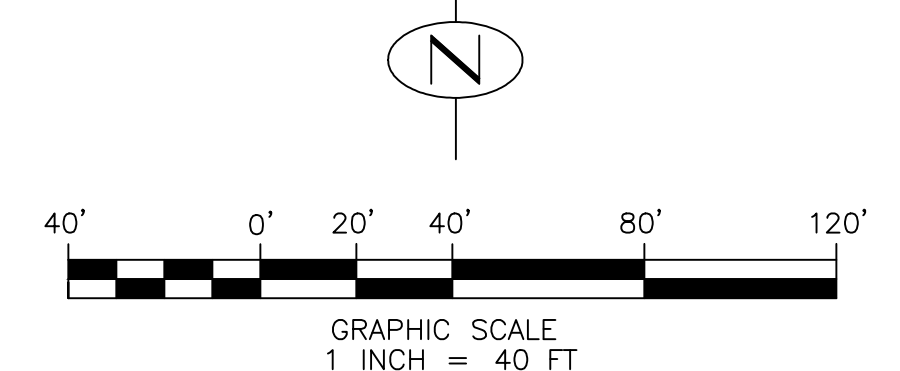

| NO | DESCRIPTION | APPR | DATE |
|----|-------------|------|------|
| | | | |
| | | | |
| | | | |




TENTATIVE PARCEL MAP NO. 37380

SITE PLAN

CITY OF MENIFEE, COUNTY OF RIVERSIDE,
STATE OF CALIFORNIA

| | |
|--|---|
| ENGINEER: ANDERSON CONSULTING ENGINEERS, INC. | 12526 HIGH BLUFF DRIVE, SUITE 300 SAN DIEGO, CA 92130 (858) 925-7918 |
| SCALE: 1" = 40' DATE: 5/21/2019 DESIGNED BY: JAA DRAWN BY: IMC CHECKED BY: JAA | SHEET 3 OF 5 |

TENTATIVE PARCEL MAP NO. 37380

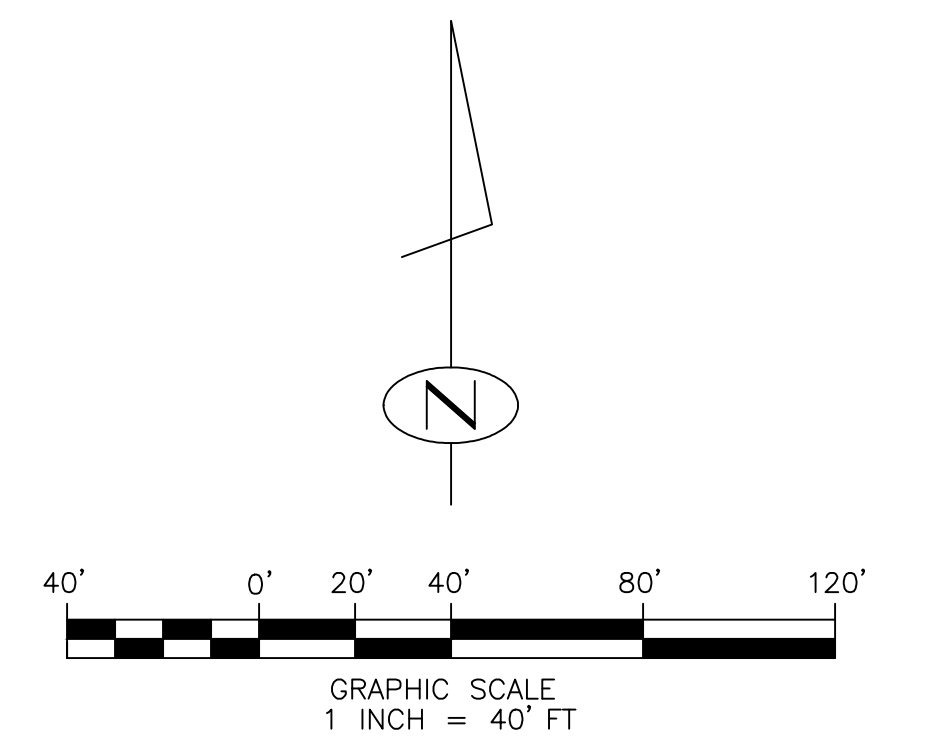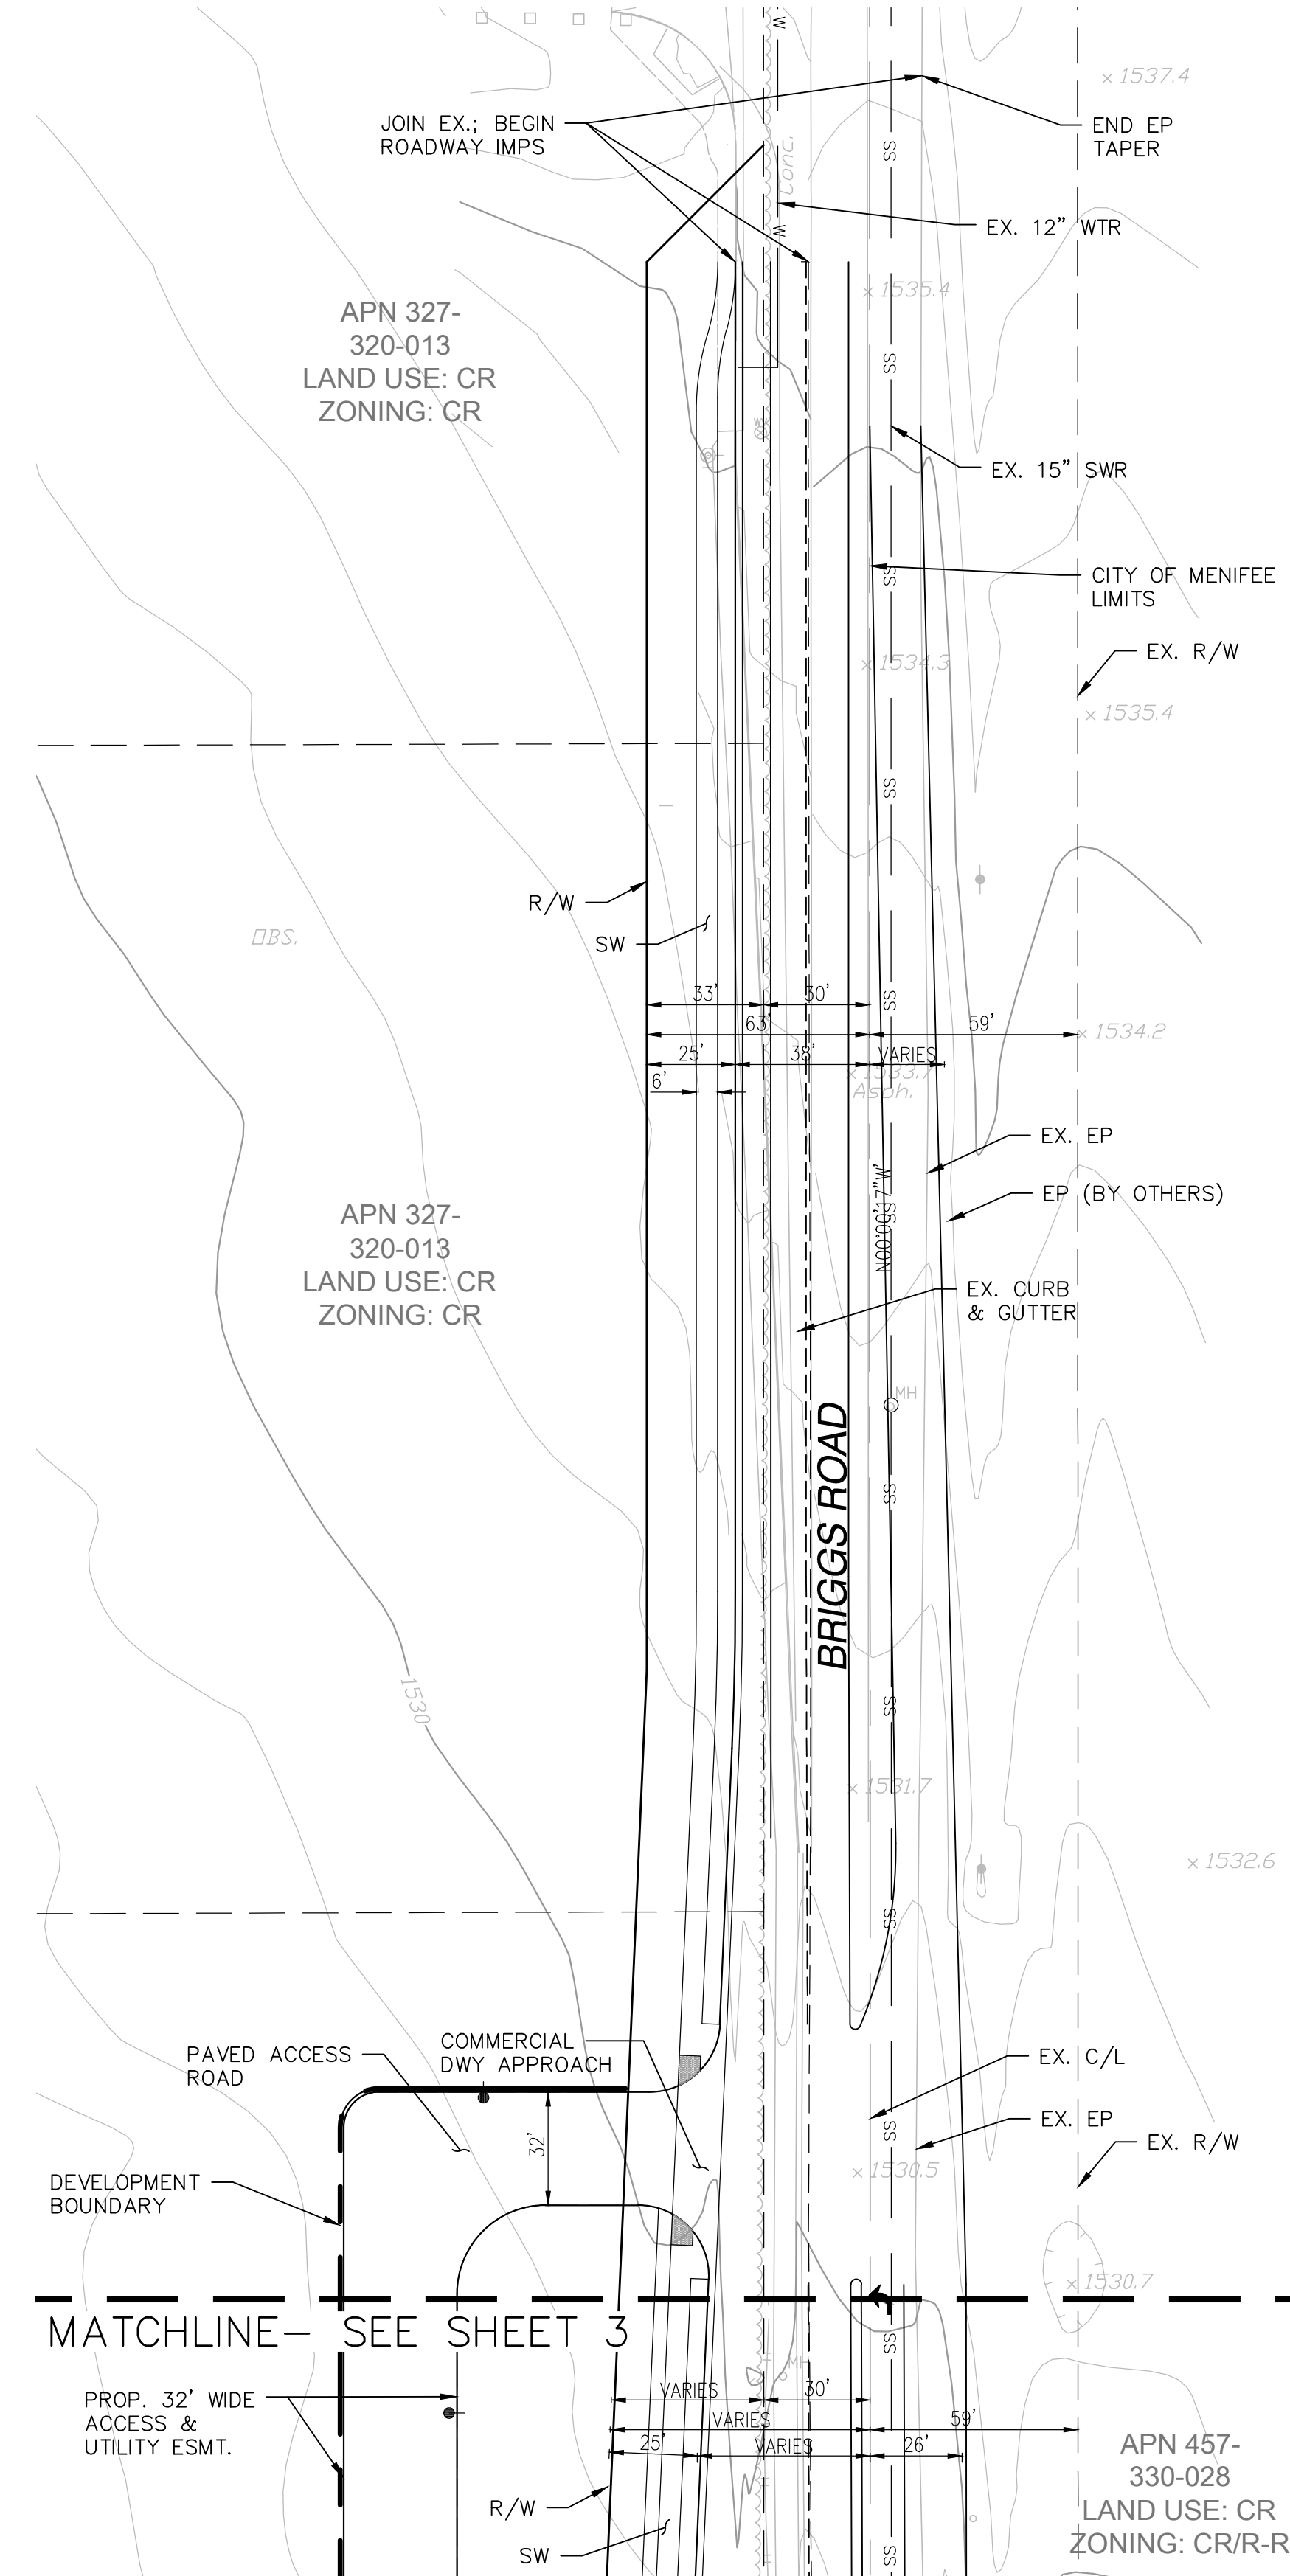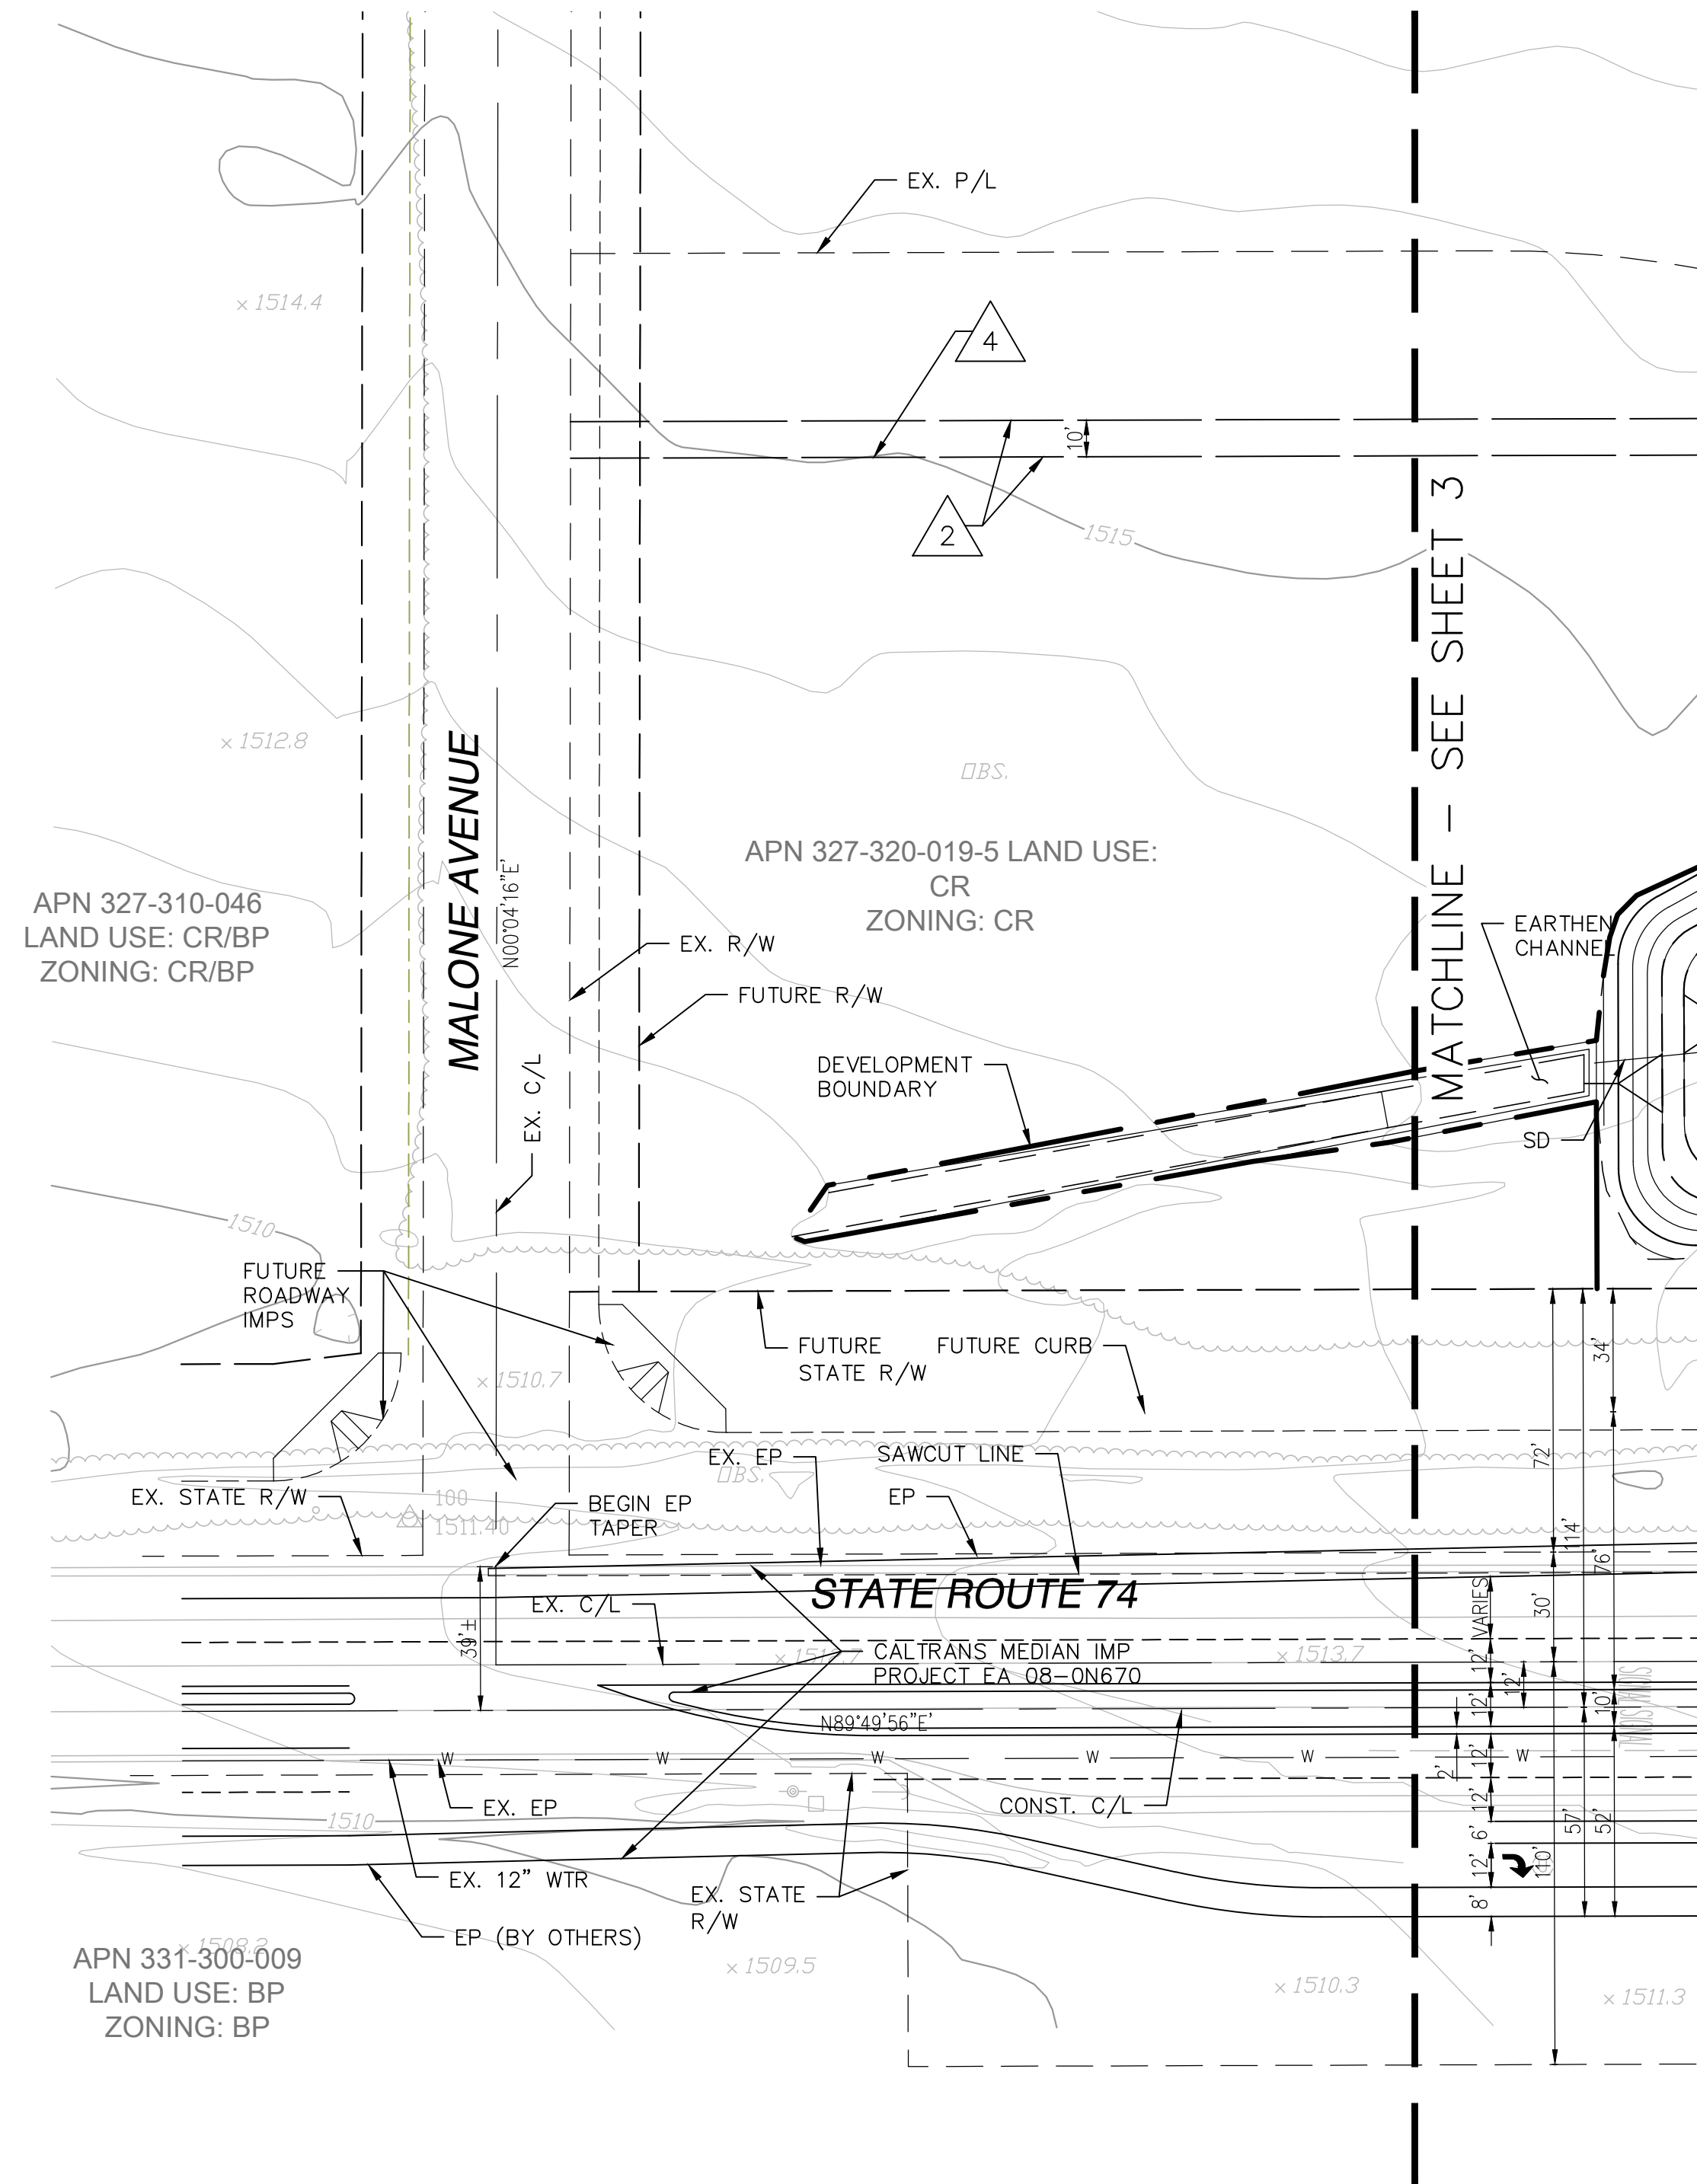

| REVISIONS: | | | |
|------------|-------------|------|------|
| NO | DESCRIPTION | APPR | DATE |
| | | | |
| | | | |
| | | | |

TENTATIVE PARCEL MAP NO. 37380

SITE PLAN


CITY OF MENIFEE, COUNTY OF RIVERSIDE,
STATE OF CALIFORNIA

| | |
|---|--|
| ENGINEER: ANDERSON CONSULTING ENGINEERS, INC. | SCALE: 1" = 40' DATE: 5/21/2019 DESIGNED BY: JAA DRAWN BY: IMC CHECKED BY: JAA |
| 12526 HIGH BLUFF DRIVE, SUITE 300 SAN DIEGO, CA 92130 (858) 925-7918 | SHEET 4 OF 5 |

TENTATIVE PARCEL MAP NO. 37380


EASEMENT NOTES

- 1. EXISTING P.U.E. IN FAVOR OF THE SOUTHERN CALIFORNIA TELEPHONE COMPANY REC. DEC. 5, 1936 IN BOOK 303, PAGE 577, O.R.
- 2. EXISTING P.U.E. IN FAVOR OF THE SOUTHERN CALIFORNIA TELEPHONE COMPANY REC. FEB. 4, 1937 IN BOOK 311, PAGE 389, O.R.
- 3. EXISTING EASEMENT FOR SLOPE AND INCIDENTAL PURPOSES IN FAVOR OF THE STATE OF CALIFORNIA REC. MAY 12, 1970 AS INST. NO. 44270, O.R.
- 4. EXISTING P.U.E. IN FAVOR OF THE SOUTHERN SIERRAS POWER COMPANY REC. APR. 11, 1928 IN BOOK 758, PAGE 180 OF DEEDS. (WIDTH UNKNOWN)

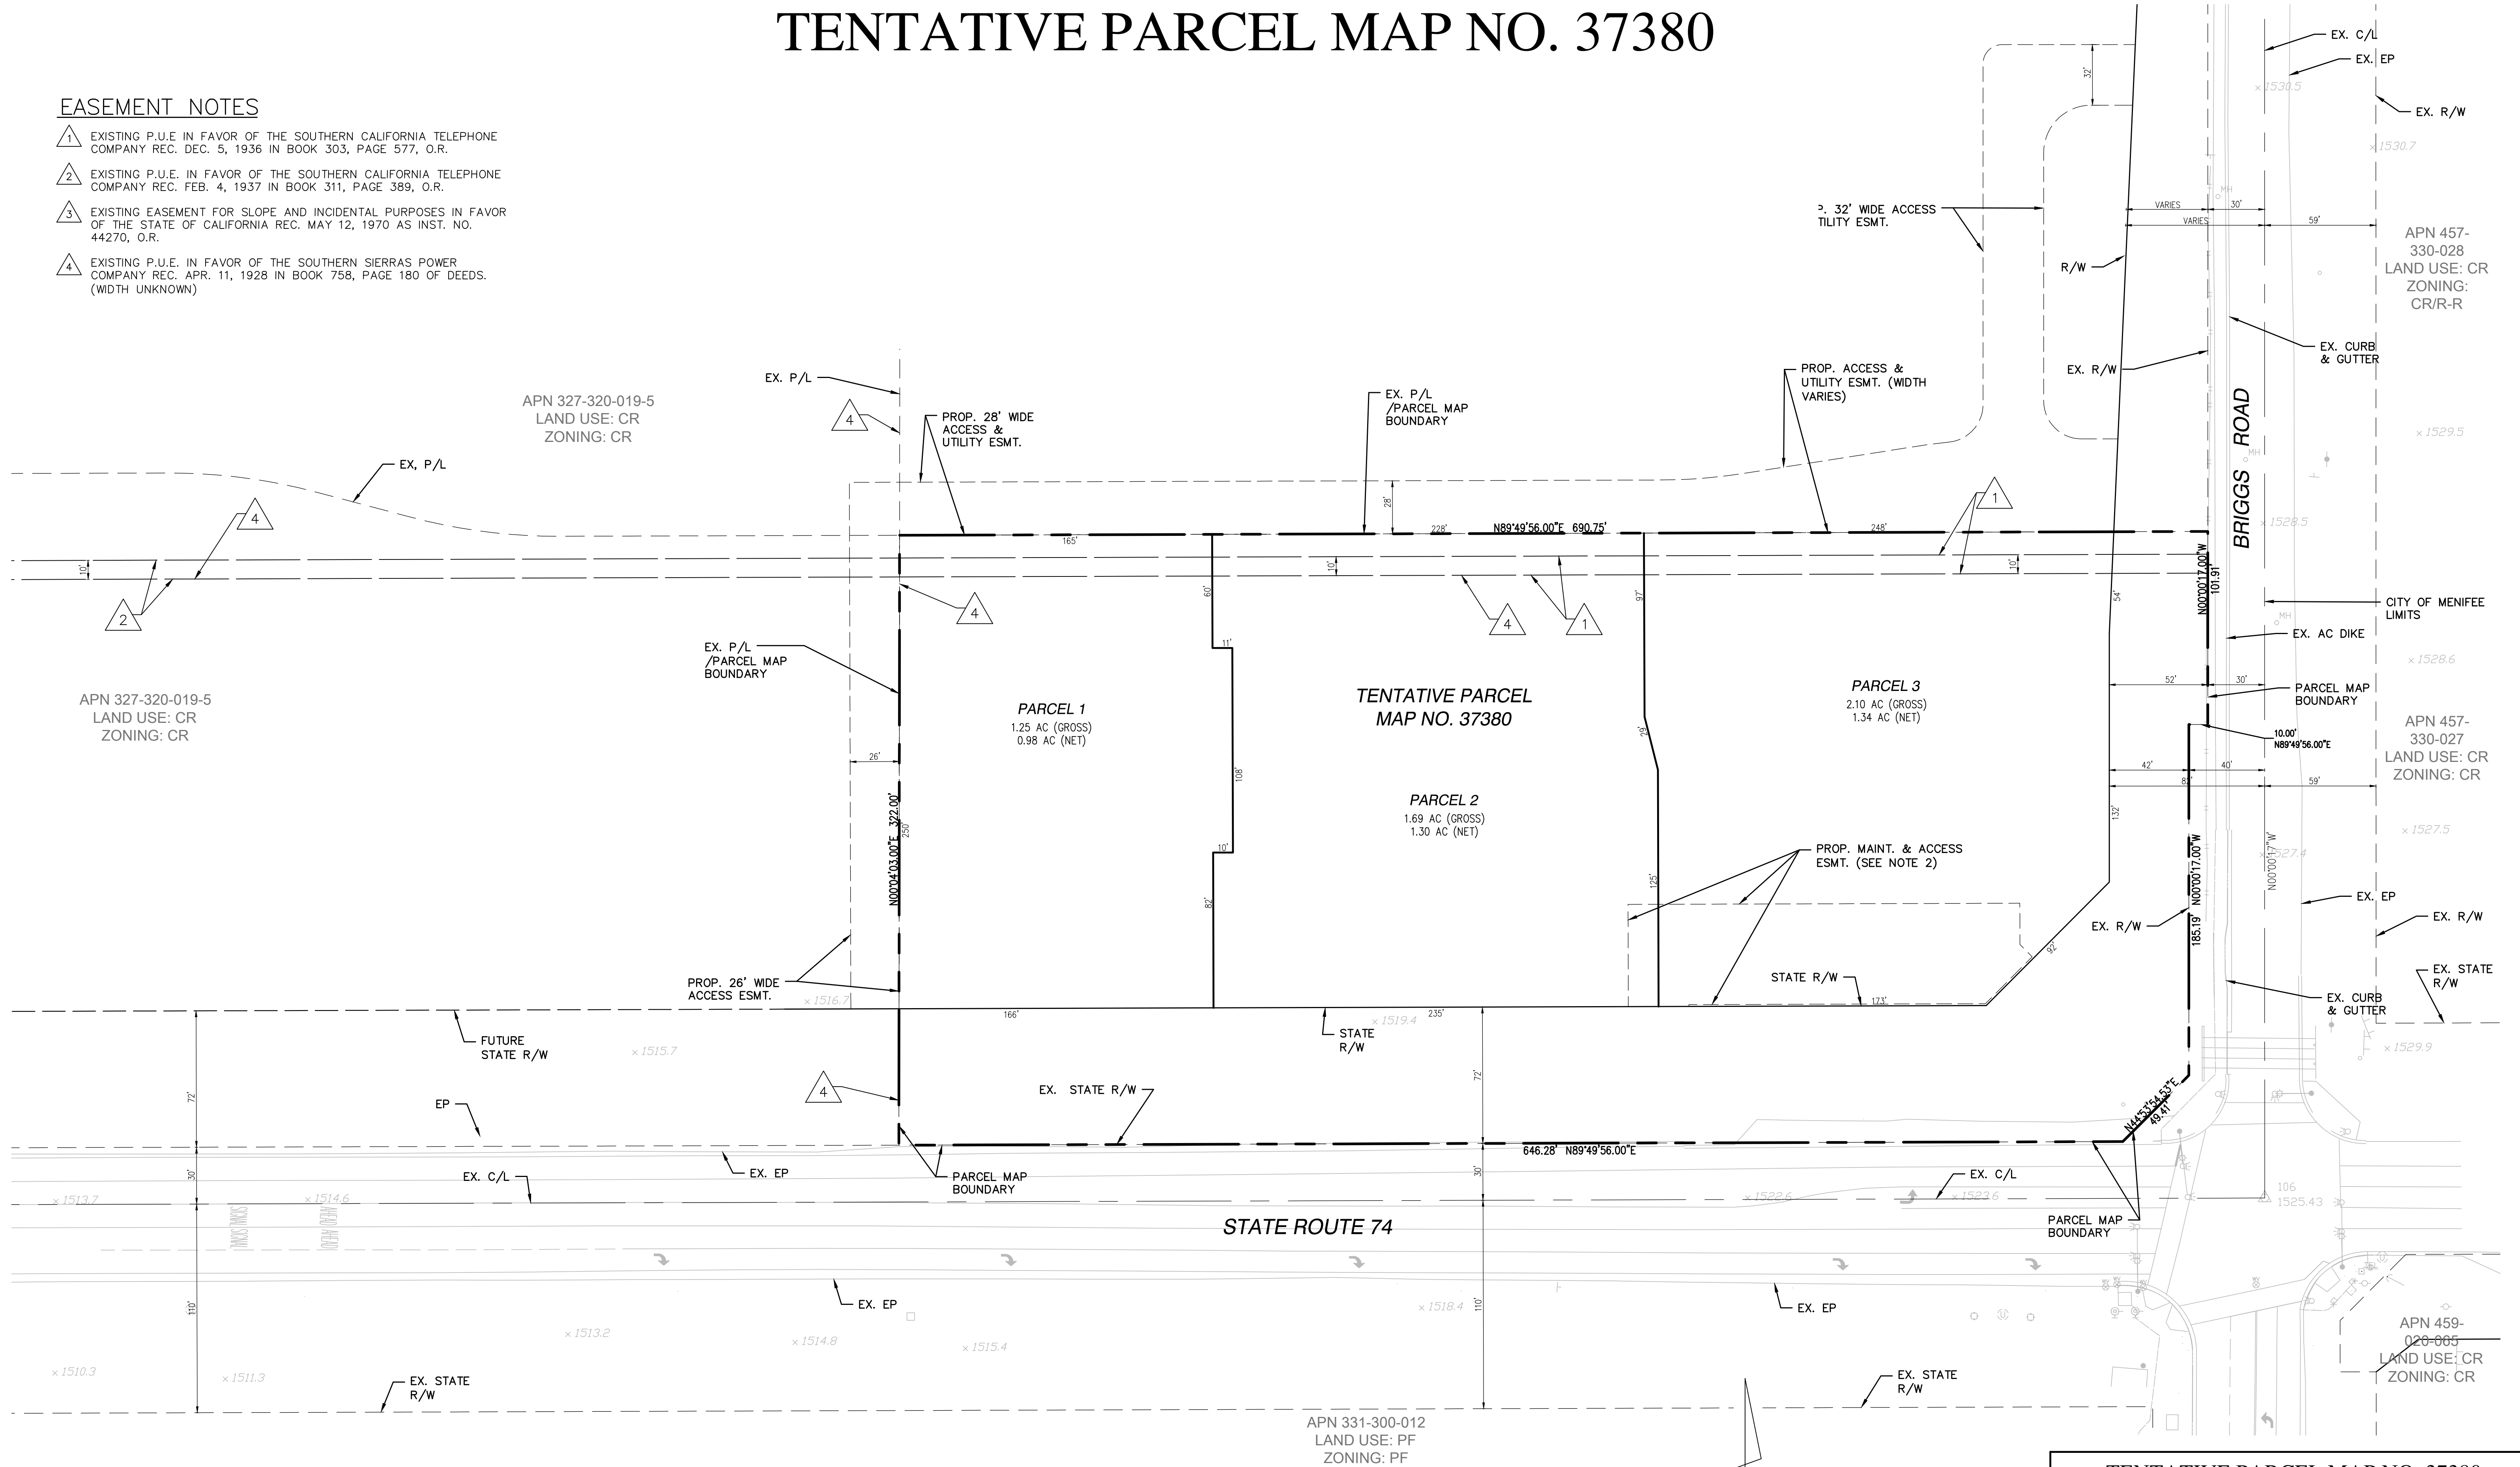

NOTES

1. PROPOSED BLANKET EASEMENT FOR RECIPROCAL ACCESS AND PARKING, UTILITIES, DRAINAGE, AND MAINTENANCE SHALL BE RECORDED ON PARCELS 1-3 AS PART OF THIS PARCEL MAP.
2. PROPOSED MAINTENANCE AND ACCESS EASEMENT IN FAVOR OF THE CITY OF MENIFEE.

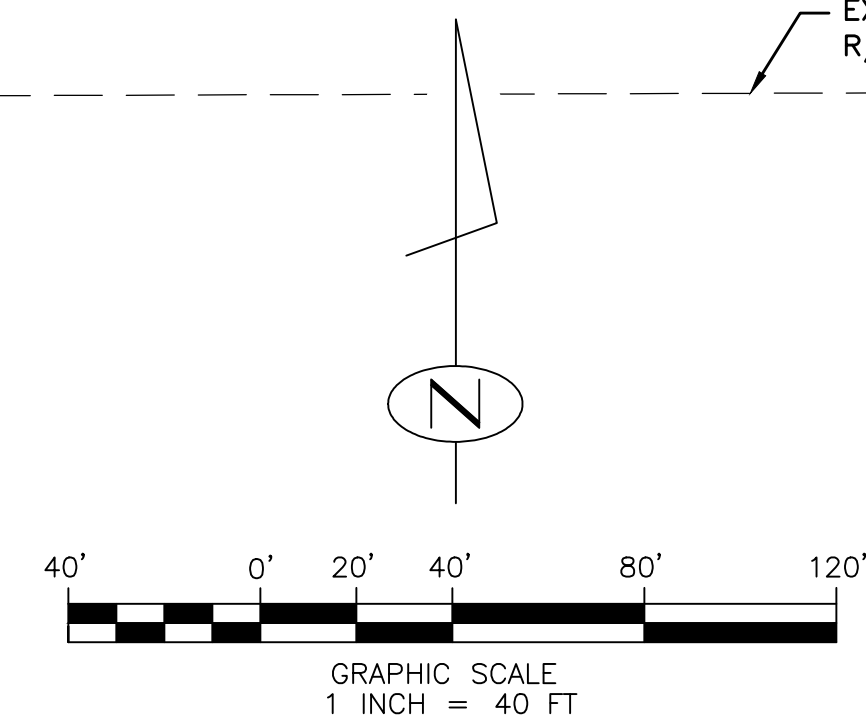


| REVISIONS: | | | |
|------------|-------------|------|------|
| NO | DESCRIPTION | APPR | DATE |
| | | | |
| | | | |
| | | | |
| | | | |

TENTATIVE PARCEL MAP NO. 37380

PARCEL EXHIBIT

CITY OF MENIFEE, COUNTY OF RIVERSIDE,
STATE OF CALIFORNIA

| | |
|--|---|
| ENGINEER: ANDERSON CONSULTING ENGINEERS, INC. | 12526 HIGH BLUFF DRIVE, SUITE 300 SAN DIEGO, CA 92130 (858) 925-7918 |
| SCALE: 1" = 40' DATE: 5/21/2019 DESIGNED BY: JAA DRAWN BY: IMC CHECKED BY: JAA | SHEET 5 OF 5 |

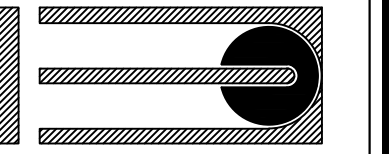


All ideas, designs and layouts shown on these drawings, including all documents on electronic media are the property of empire design group, and are intended to be used in connection with this specific project only and shall not otherwise be used for any purpose whatsoever without the written consent, and may not be reproduced or used without the written permission of empire design group.
All rights reserved.

CLIENT:

**BRIGGS AND
HIGHWAY 74, LP**

**BRIGGS AND HIGHWAY 74, LP
SEC HWY. 74 & BRIGGS ROAD
MENIFEE, CA 92585**

Architect of Record:
GREGORY S. HANN, AIA
24861 WASHINGTON AVE.
MURRIETA, CA 92562
TEL: 951-696-1490
CEL: 951-809-7601
FAX: 951-696-1443
E-MAIL: ghann@empiregr.biz

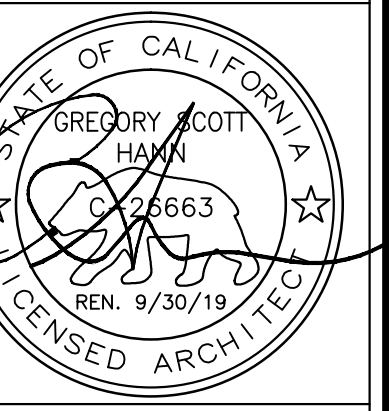

Date: SEPTEMBER 11, 2018

Project Number: EDG# 04408

| NO. | DATE | REVISION DESCRIPTION |
|-----|------|----------------------|
| | | |
| | | |
DESIGNED BY: GH
CHECKED BY: GH
DRAWN BY: AH

DRAWING TITLE:

**RESTAURANT
FLOOR PLAN**

SHEET NO:

A 1.1

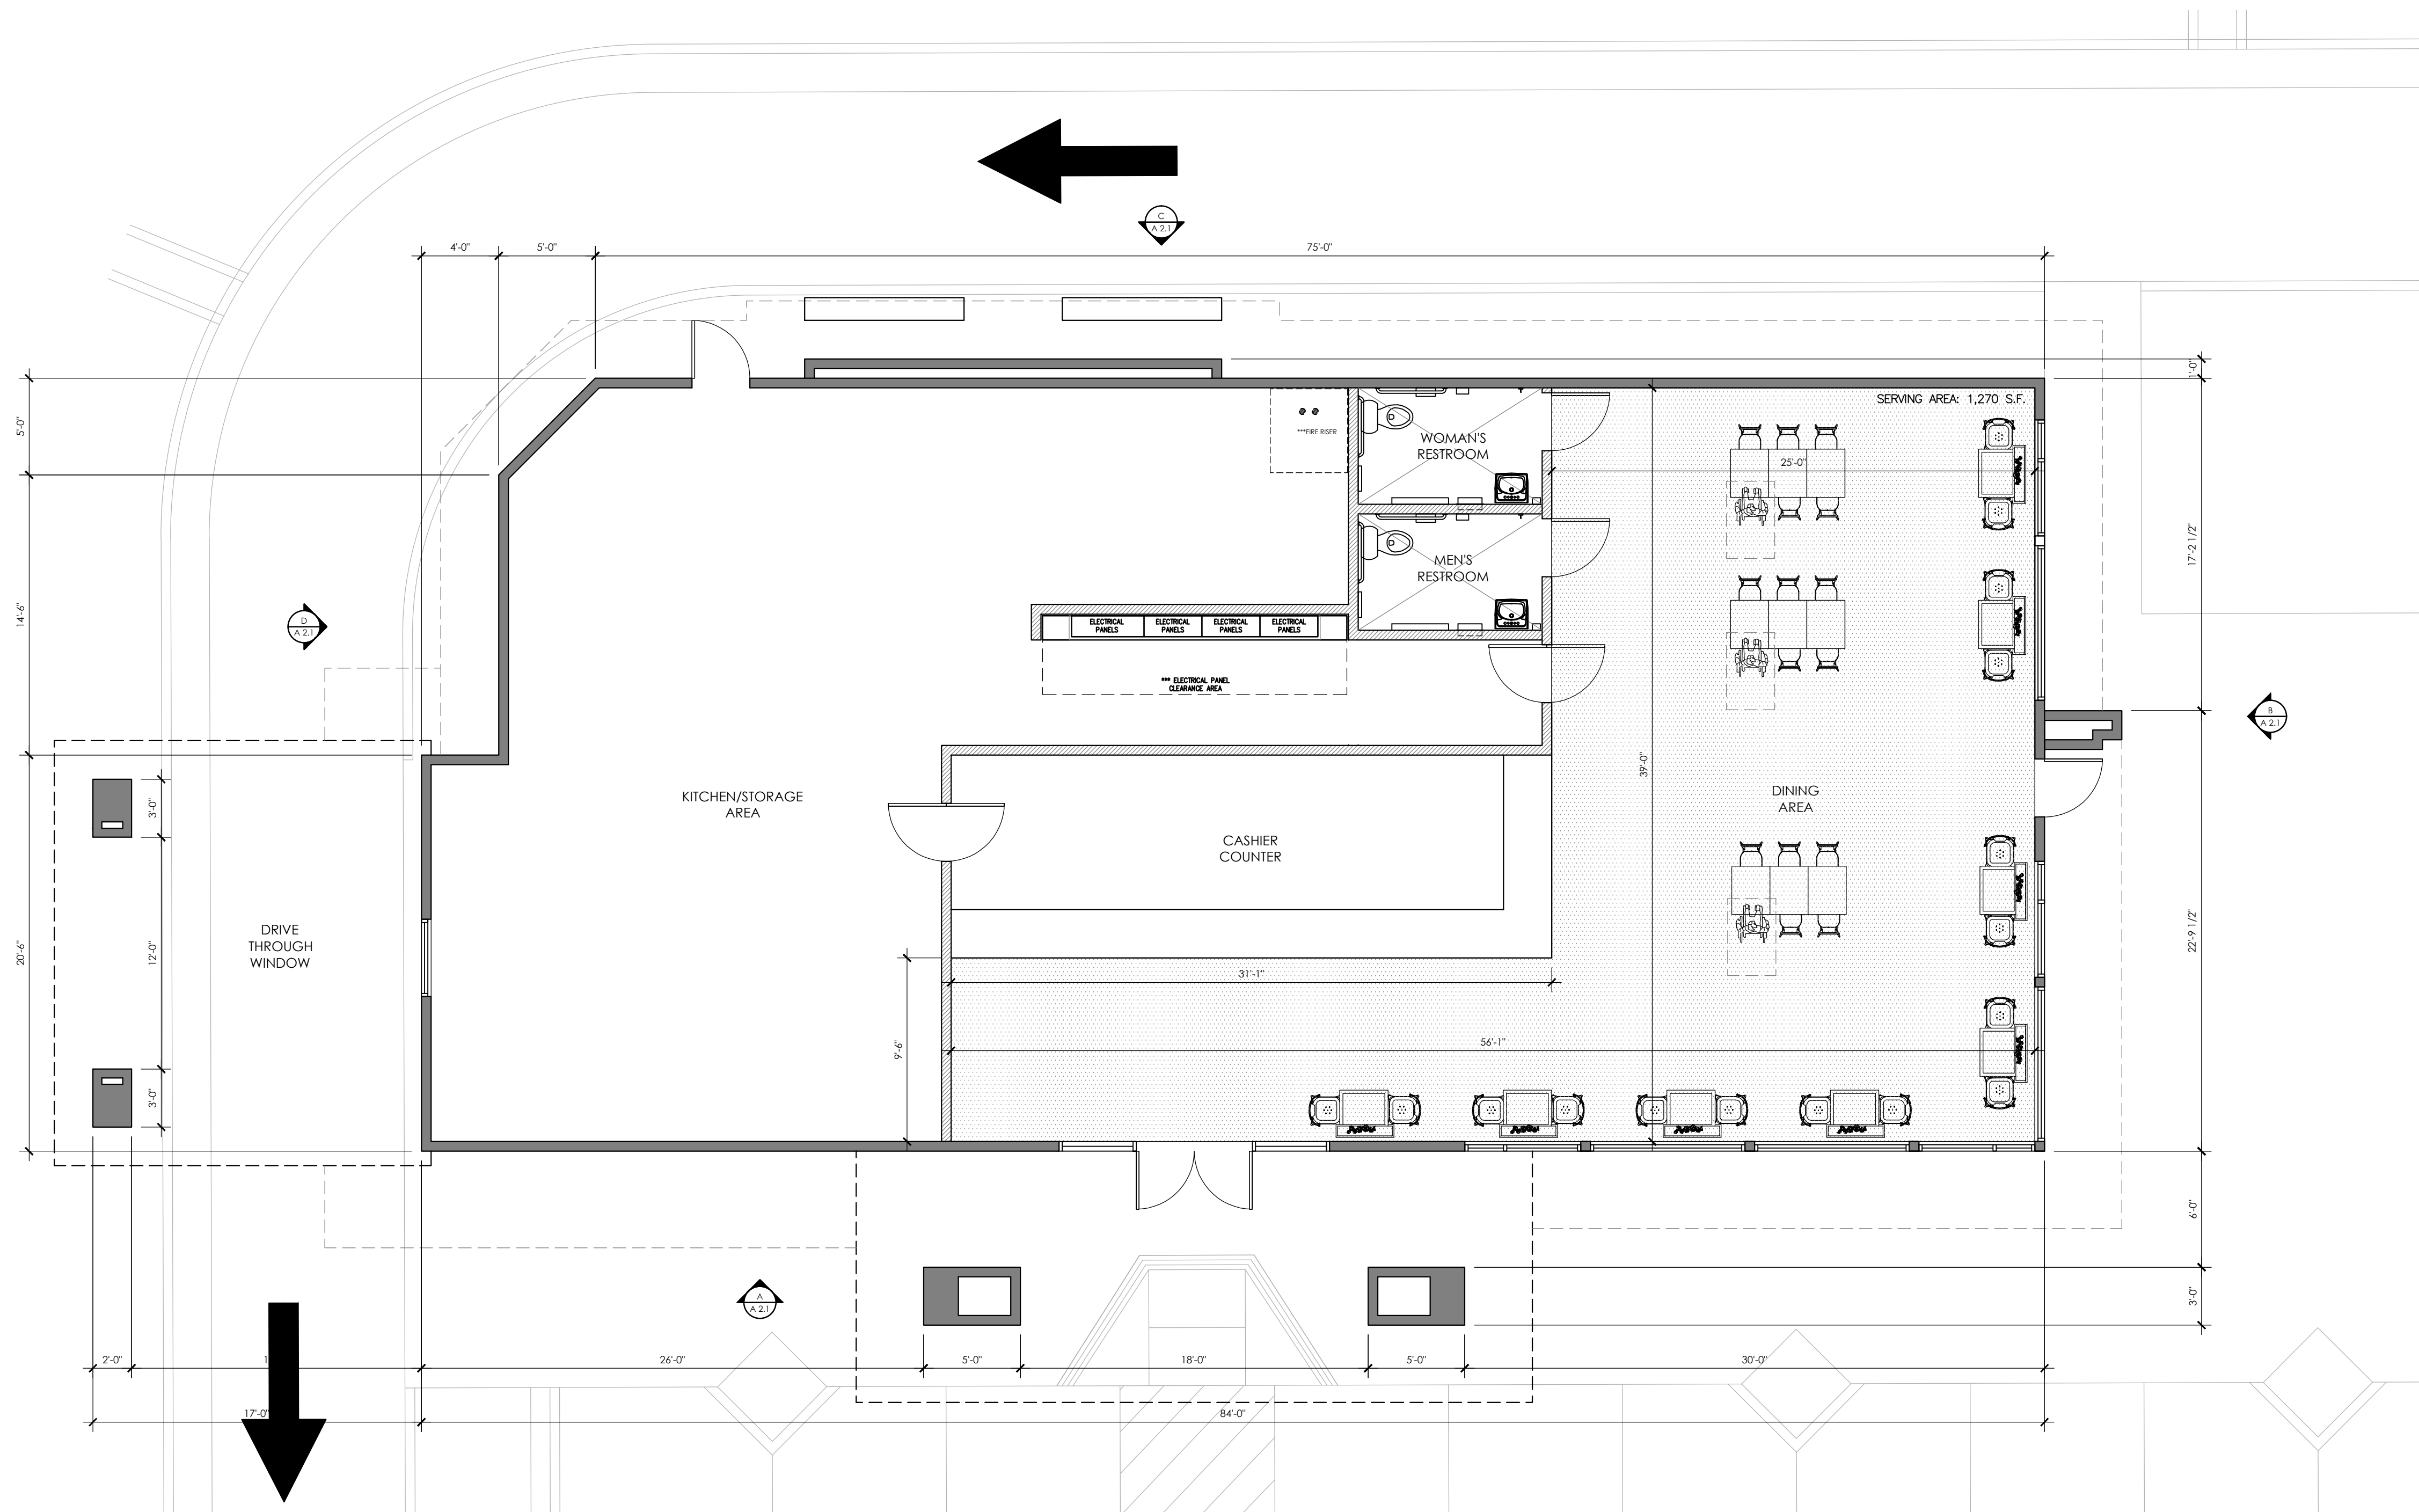


A (CASUAL DINING) RESTAURANT FLOOR PLAN
SCALE: 3/16"=1'-0" 3,268 SQ.FT.

NOTES:
HOURS OF OPERATION: FAST FOOD : 7 AM - 12 AM
BEER & WINE LICENSE: FAST FOOD : NONE


PLANTING LEGEND

| SYMBOL | BOTANICAL NAME | COMMON NAME | SIZE | NUMBER | REMARKS | WUCOLS IV |
|----------------|--------------------------------------|-------------------------|------------|-----------|---|-----------|
| TREES: | | | | | | |
| | LAGERSTROEMIA FAURI 'TUSCARORA' | RED CREPE MYRTLE | 36"/24"BOX | 5/18 | DOUBLE STAKE / HEIGHT 8-10' , SPREAD 3'-4' MIN. | M |
| | CHITALPA TASHKENTENSIS | PINK FLOWERING CHITALPA | 24" BOX | 50 | DOUBLE STAKE / HEIGHT 8-10' , SPREAD 3'-4' MIN. | L |
| | RHUS LANCEA | AFRICAN SUMAC | 24" BOX | 57 | DOUBLE STAKE / HEIGHT 8-10' , SPREAD 3'-4' MIN. | L |
| | PISTACIA CHINENSIS | CHINESE PISTACIA | 24" BOX | 36 | DOUBLE STAKE / HEIGHT 8-10' , SPREAD 3'-4' MIN. | L |
| SHRUBS: | | | | | | |
| | BACCHARIS PILLULARIS 'PIGEON POINT' | PROSTRATE COYOTE BUSH | 1 GAL | 1673 | TRIANGULAR SPACING @ 5' O.C. | L |
| | HESPERALOE PARVIFLORA | RED YUCCA | 5 GAL | 387 | FULL & BUSHY @ 3' O.C. | L |
| | LEUCOPHYLLUM FRUTESCENS 'OR. CLOUD' | GREEN TEXAS RANGER | 5 GAL | 504 | FULL & BUSHY @ 5' O.C. | L |
| | ANAGOZANTHUS FLAVIDUS 'VELVET AMBER' | AMBER KANGAROO PAWS | 1 GAL | 507 | FULL & BUSHY @ 3' O.C. | L |
| | SALVIA GREGGII | AUTUMN SAGE | 5 GAL | 600 | FULL & BUSHY @ 3' O.C. | L |
| | LOMANDRA LONGIFOLIA | LOMANDRA | 1 GAL. | 1016 | FULL & BUSHY @ 3' O.C. IN BIORETENTION BASINS | L |
| | ROSA RED FLOWER CARPET | RED FLOWER CARPET ROSE | 5 GAL. | 101 | FULL & BUSHY @ 4' O.C. | M |
| | WESTRINGIA FRUTICOSUM 'MUNDI' | PROSTRATE CAPE ROSEMARY | 1 GAL. | 493 | FULL & BUSHY @ 5' O.C. | L |
| VINES: | | | | | | |
| | MACFADYENA UNGUIS-CATI | CAT'S CLAW | 5 GAL | 56 | ATTACH TO TRASH ENCLOSURE WALLS & FENCES | L |
| MULCH: | | | | | | |
| | MEDIUM GRIND WOOD MULCH | SHREDDED WOOD MULCH | 3" MAX. | AS REQ'D. | 3" DEEP - INSTALL TO ALL PLANTING AREAS | |
| NOT SHOWN | | | | | | |

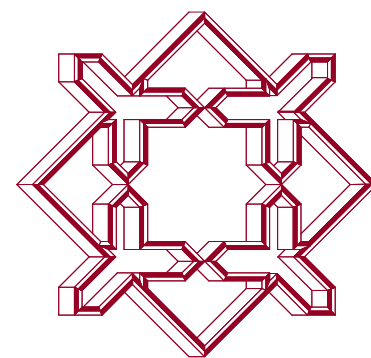

ALHAMBRA GROUP
 LANDSCAPE ARCHITECTURE
 California license #2017
 RECREATION FACILITIES PLANNING



41635 Enterprise Circle North, Suite C
 Temecula, CA 92590 (951) 296-6802 FAX 296-6803
 JOB #17-122 12-04-18

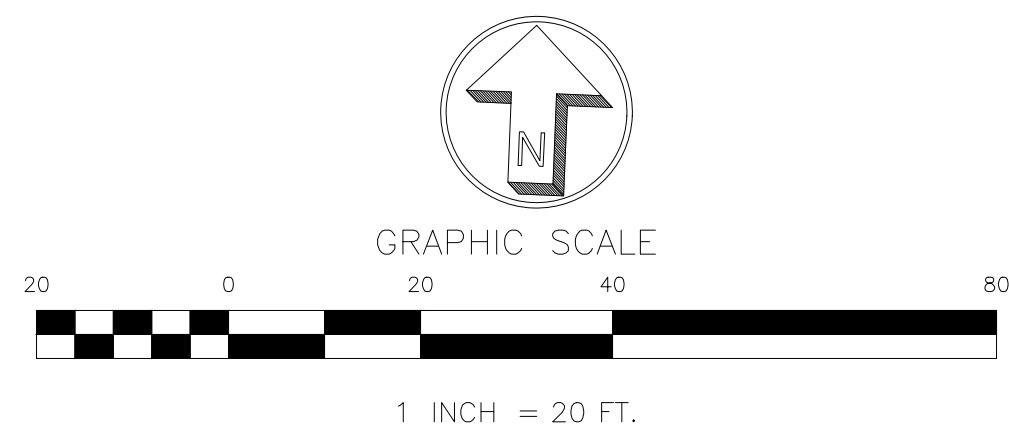

BRIGGS and 74 LLC CENTER
 RANCON GROUP
 41391 KALMIA ST., SUITE 200, MURRIETA, CA. 92562





BRIGGS LLC CENTER MONUMENT SIGN

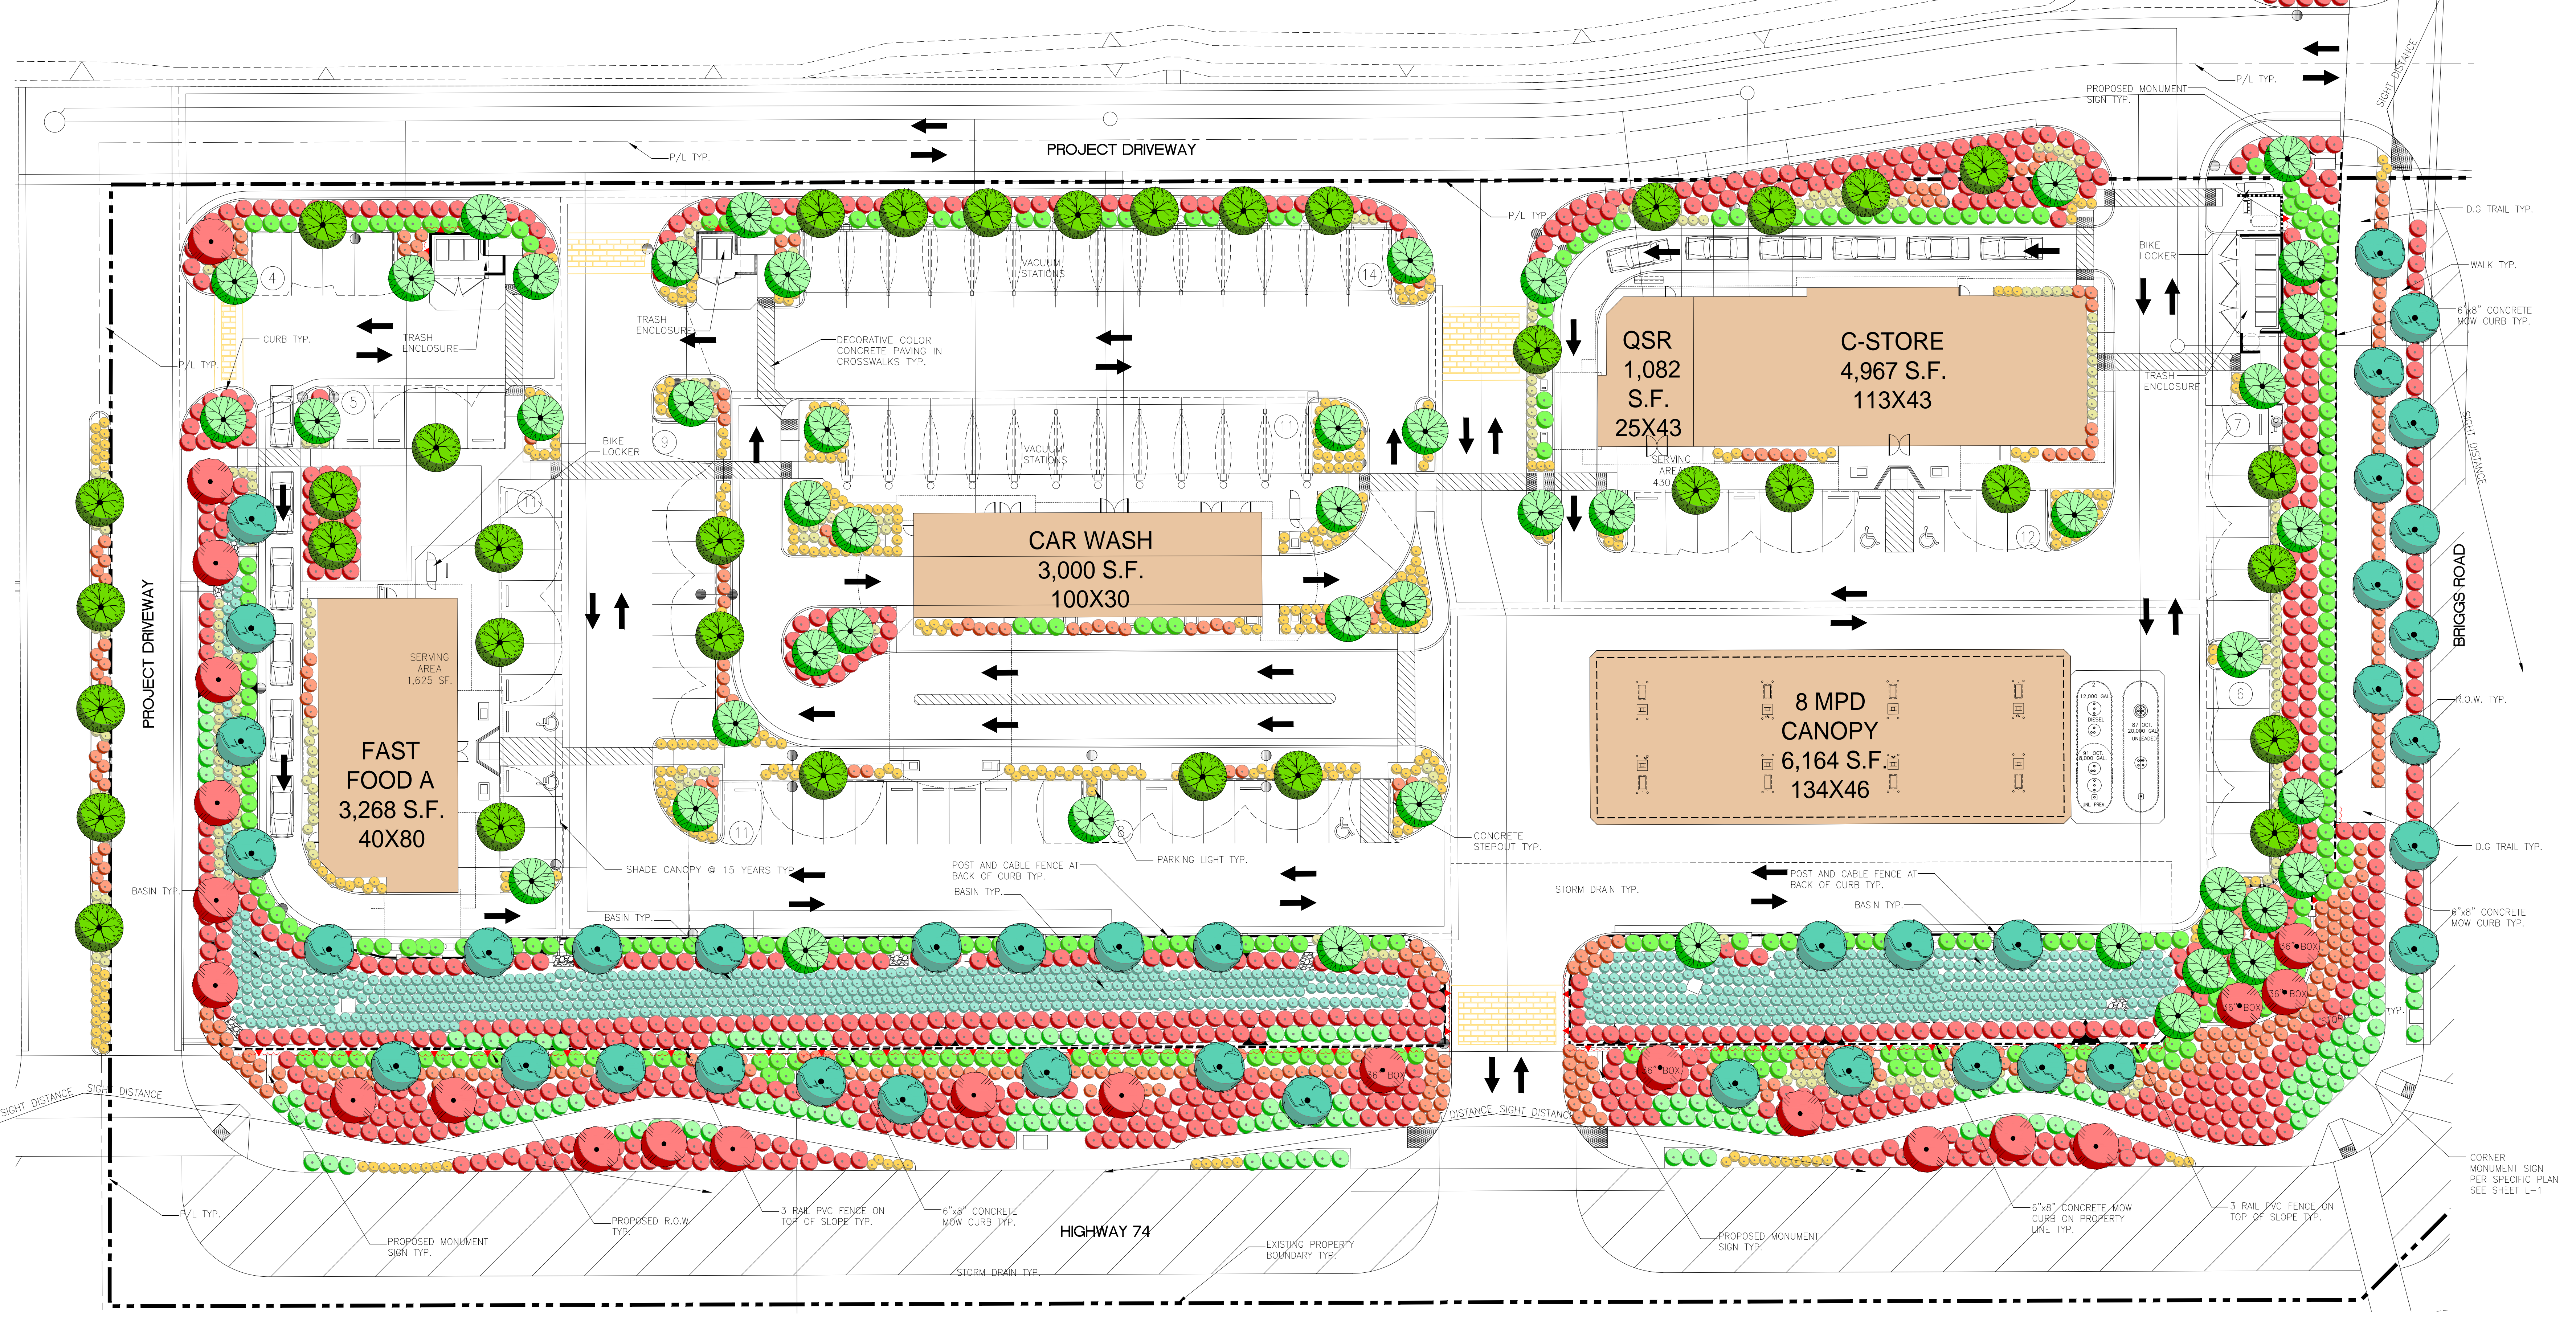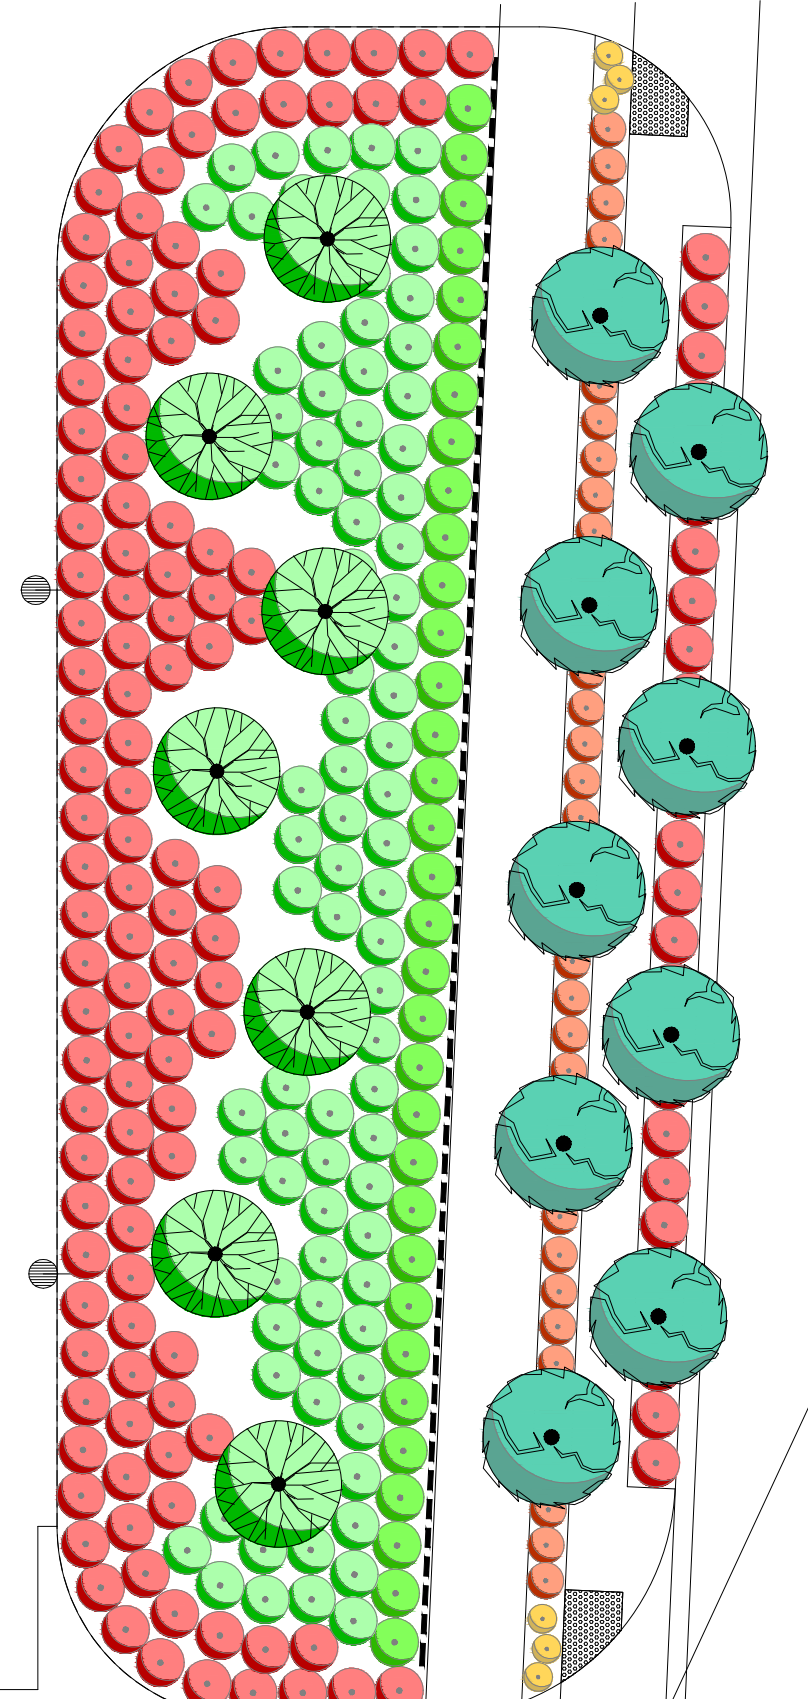


COLOR CONCEPT PLAN

ALHAMBRA GROUP
 LANDSCAPE ARCHITECTURE
 California License #2017
 RECREATION FACILITIES PLANNING
 41835 Elmhurst Circle, Suite C
 Temecula, CA 92590 (951) 266-8602 FAX 951-266-8603

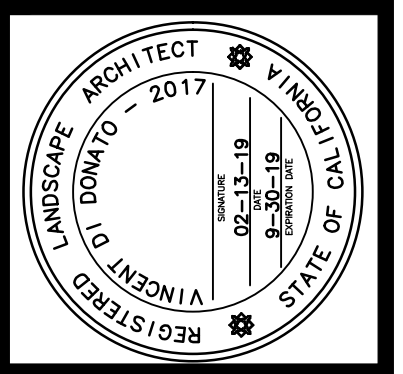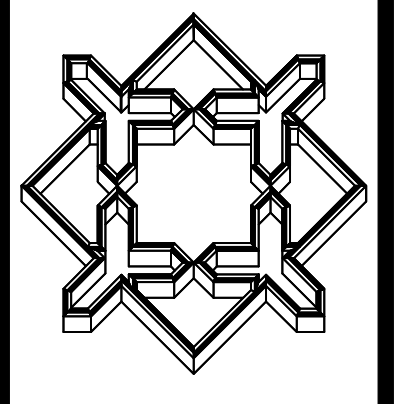


PROJECT: BRIGGS and 74, LLC CENTER
OWNER: BRIGGS and 74, LLC CO/ MR56 LLC/ RANCON GROUP
 4591 KALMA ST. SUITE 200
 MURRIETA, CA 92562 (951) 200-2867 CONTACT: DAN LONG


drawn: V.D.
 checked: V.D.
 date: 2-7-18
SHEET
 L-1
 of 2 sheets
 JOB NO.
 17-122

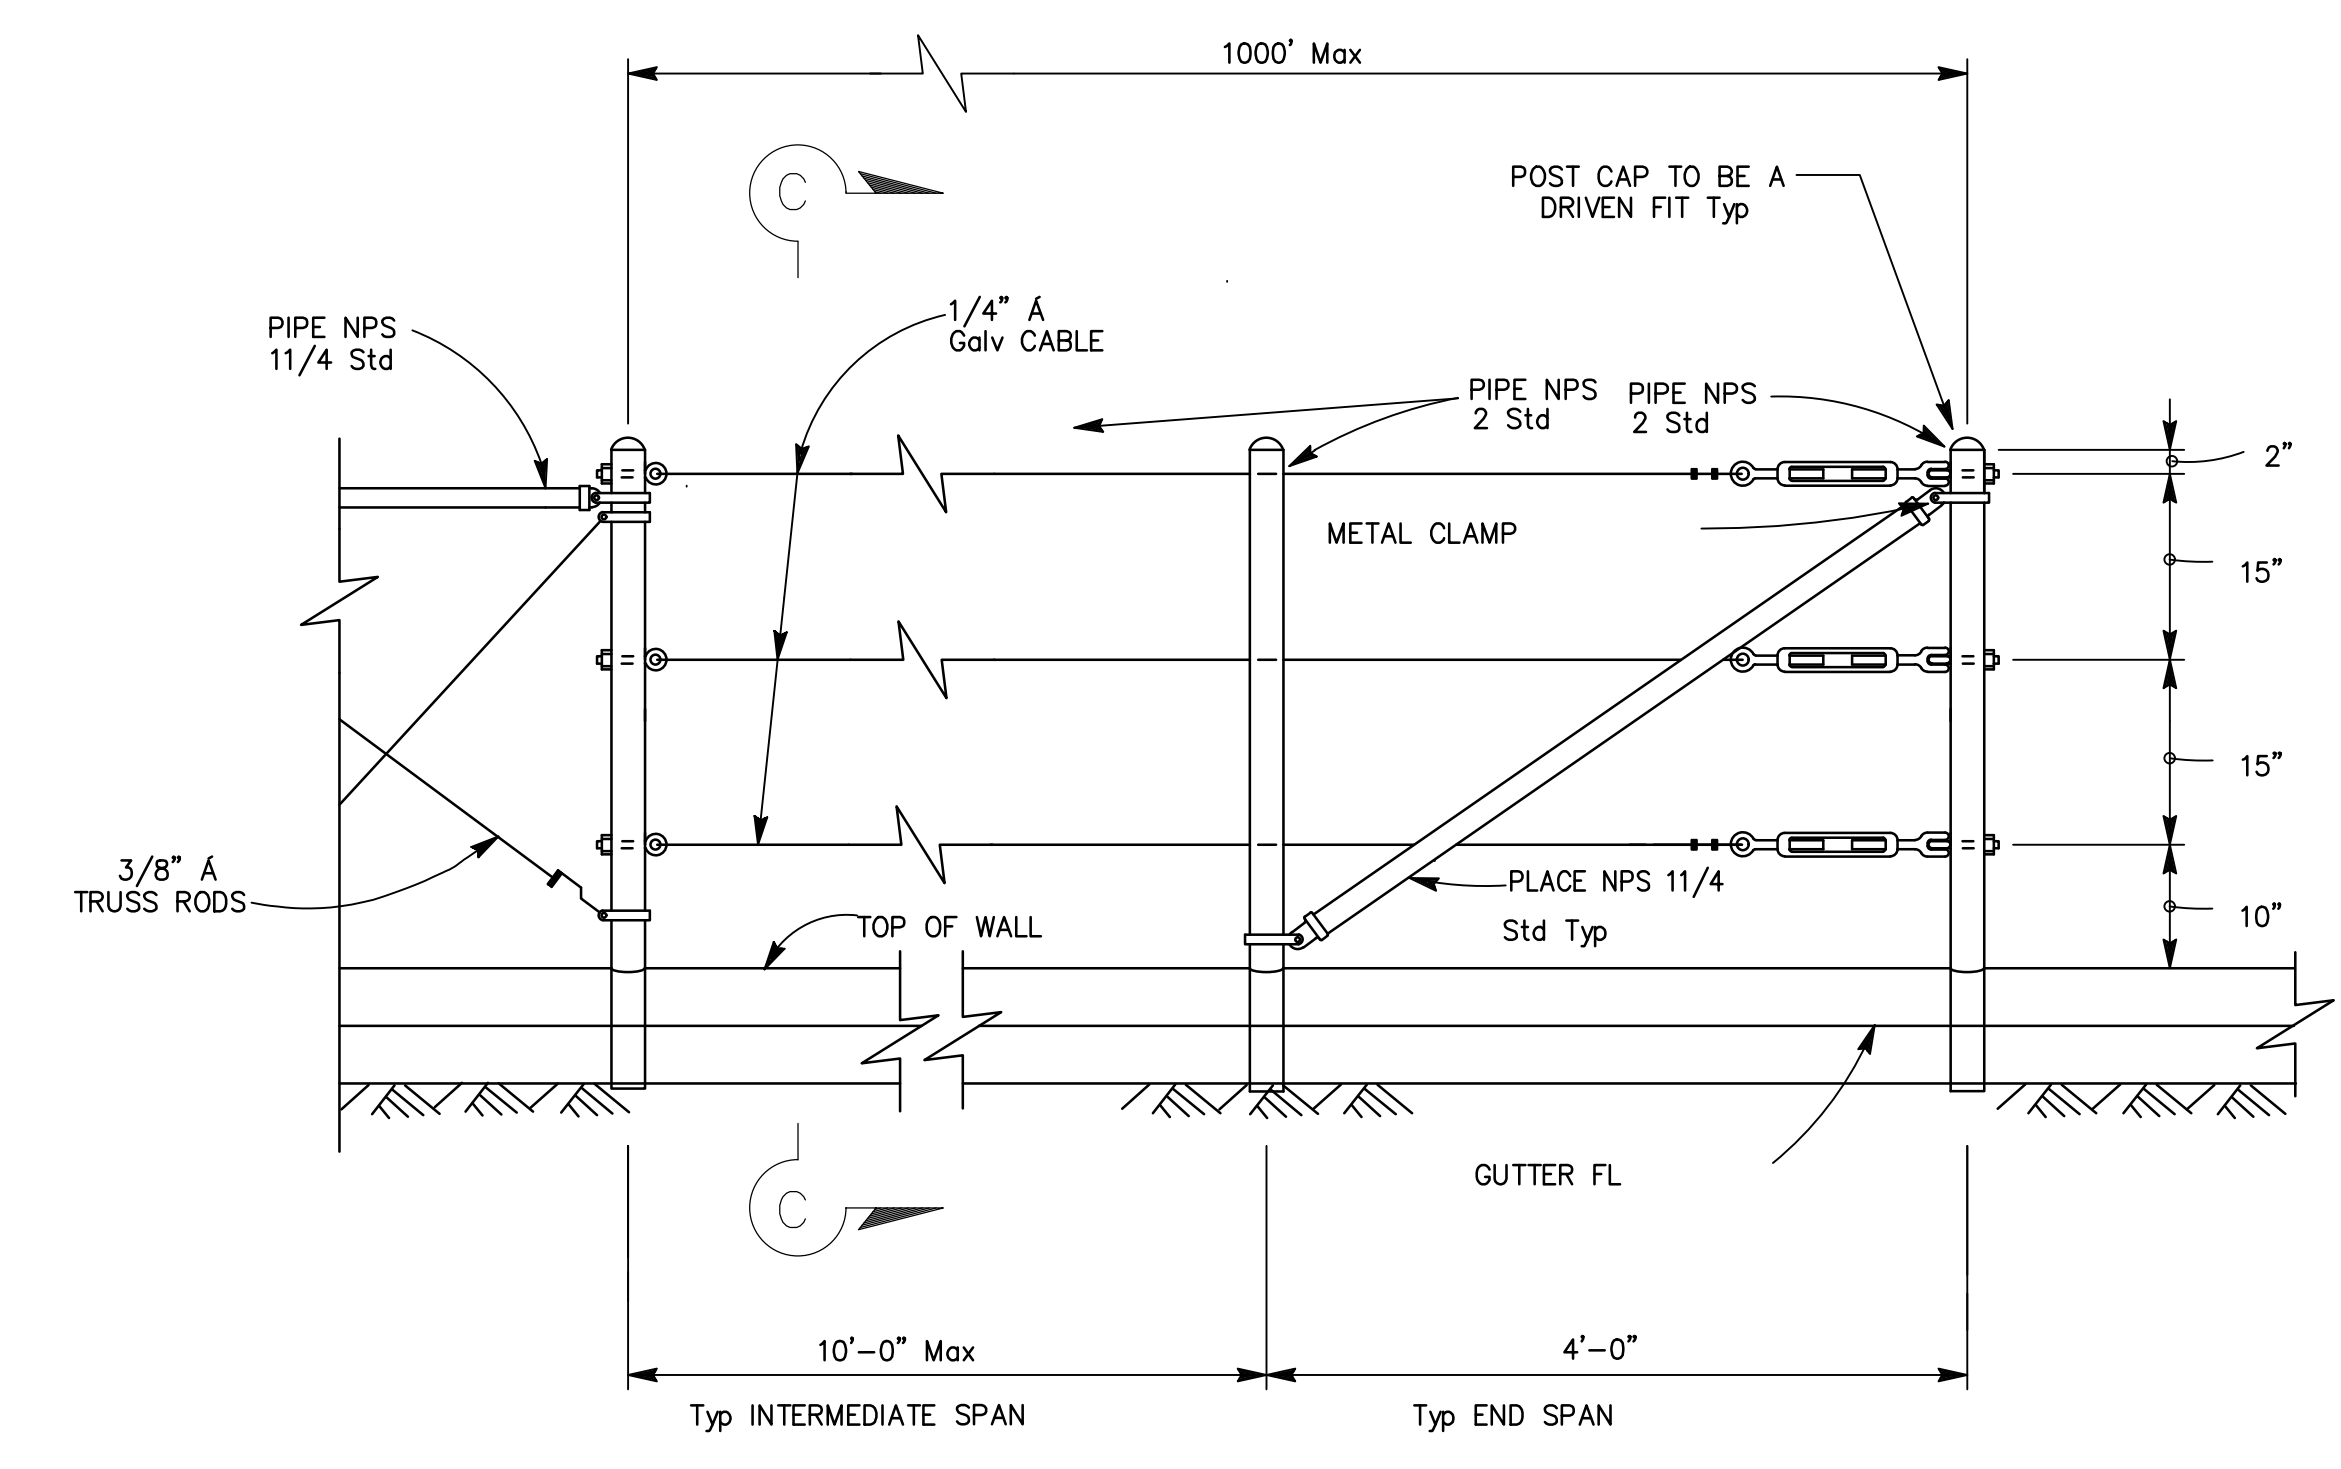


POST and CABLE FENCE
 N.T.S.

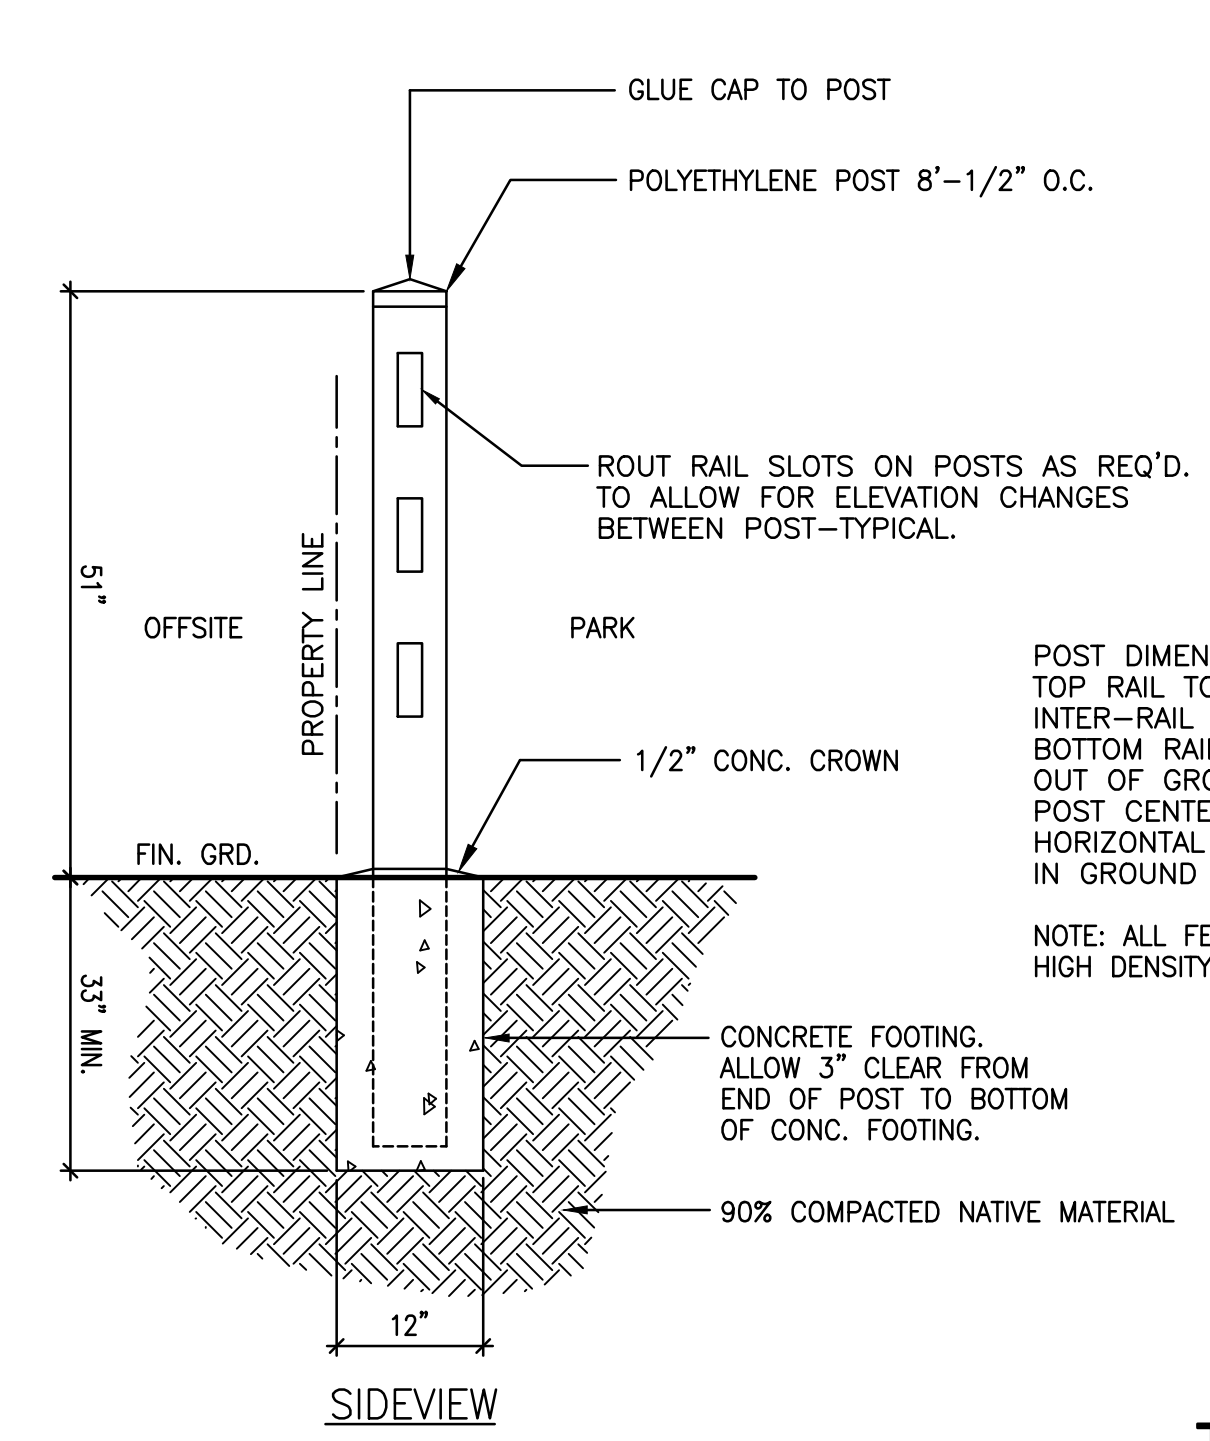


THREE RAIL FENCE
 N.T.S.

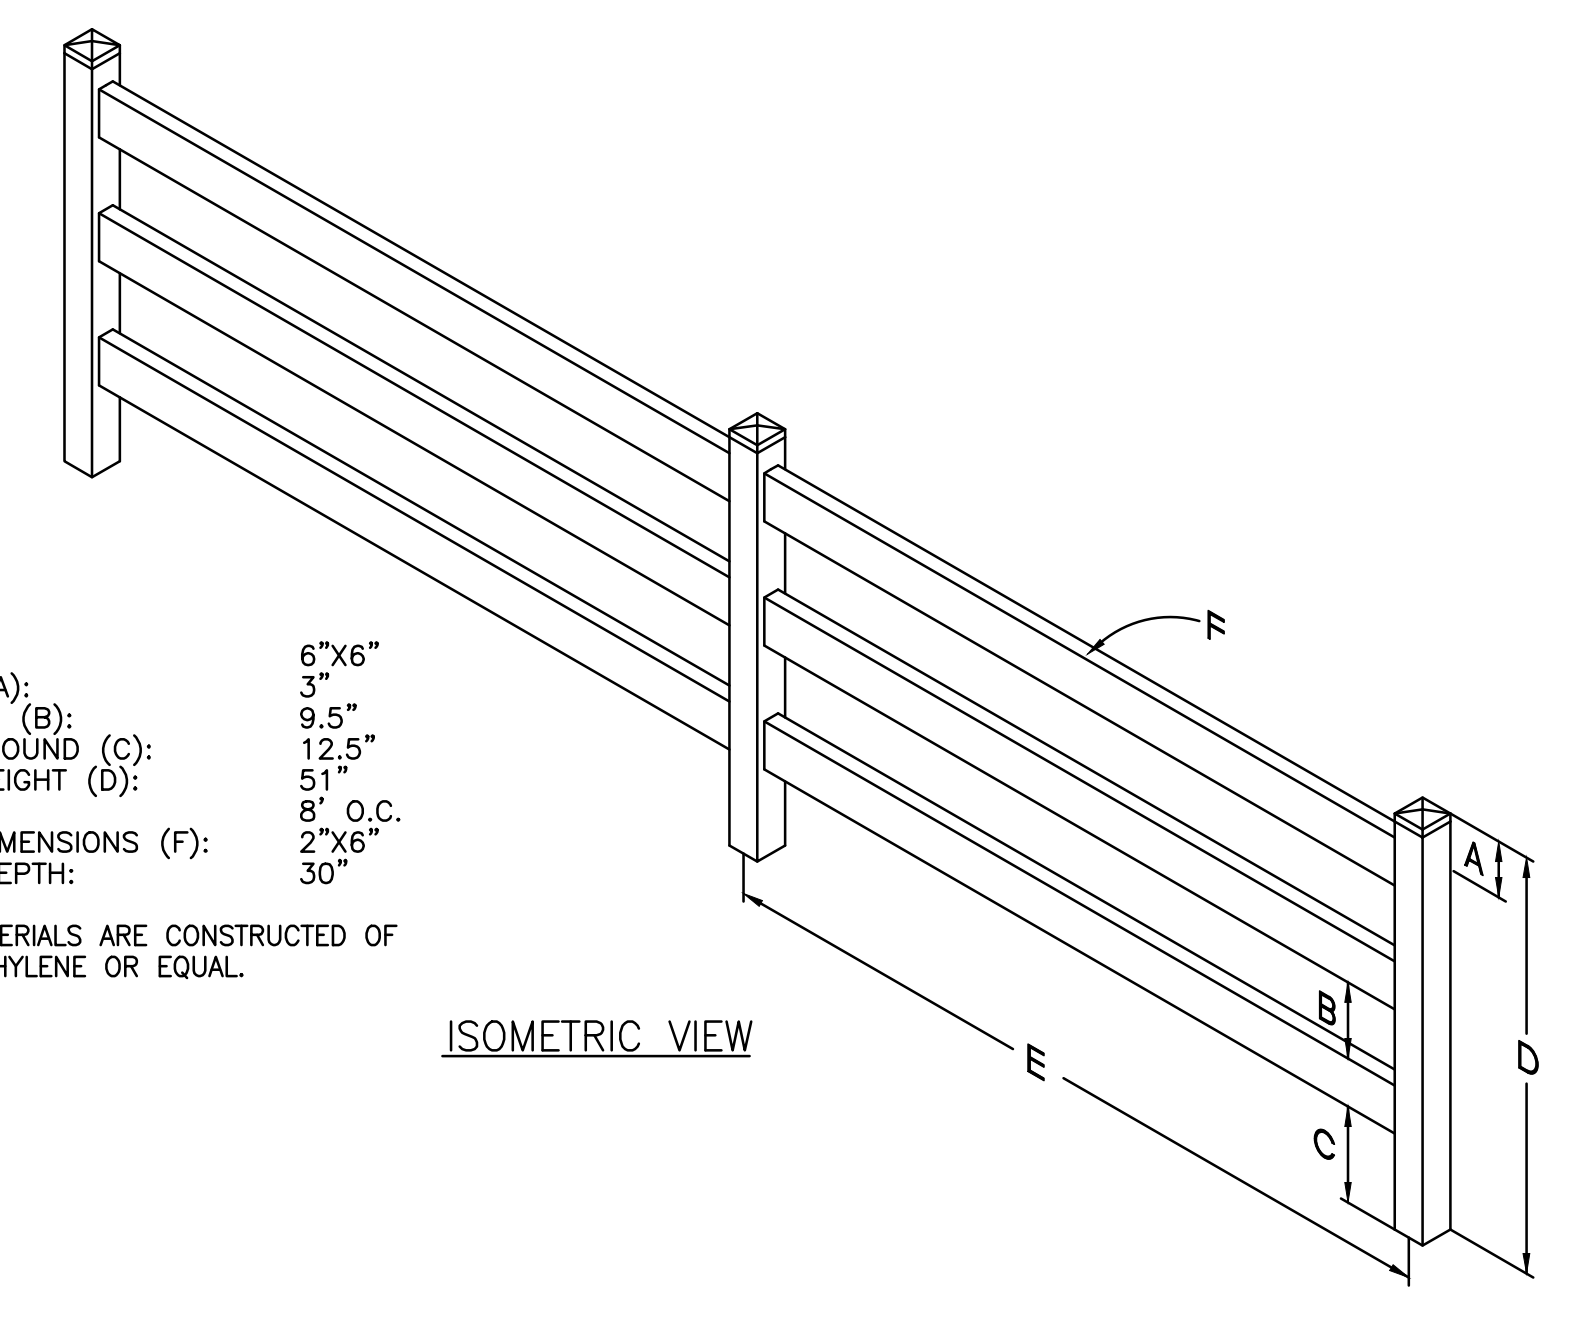


ISOMETRIC VIEW

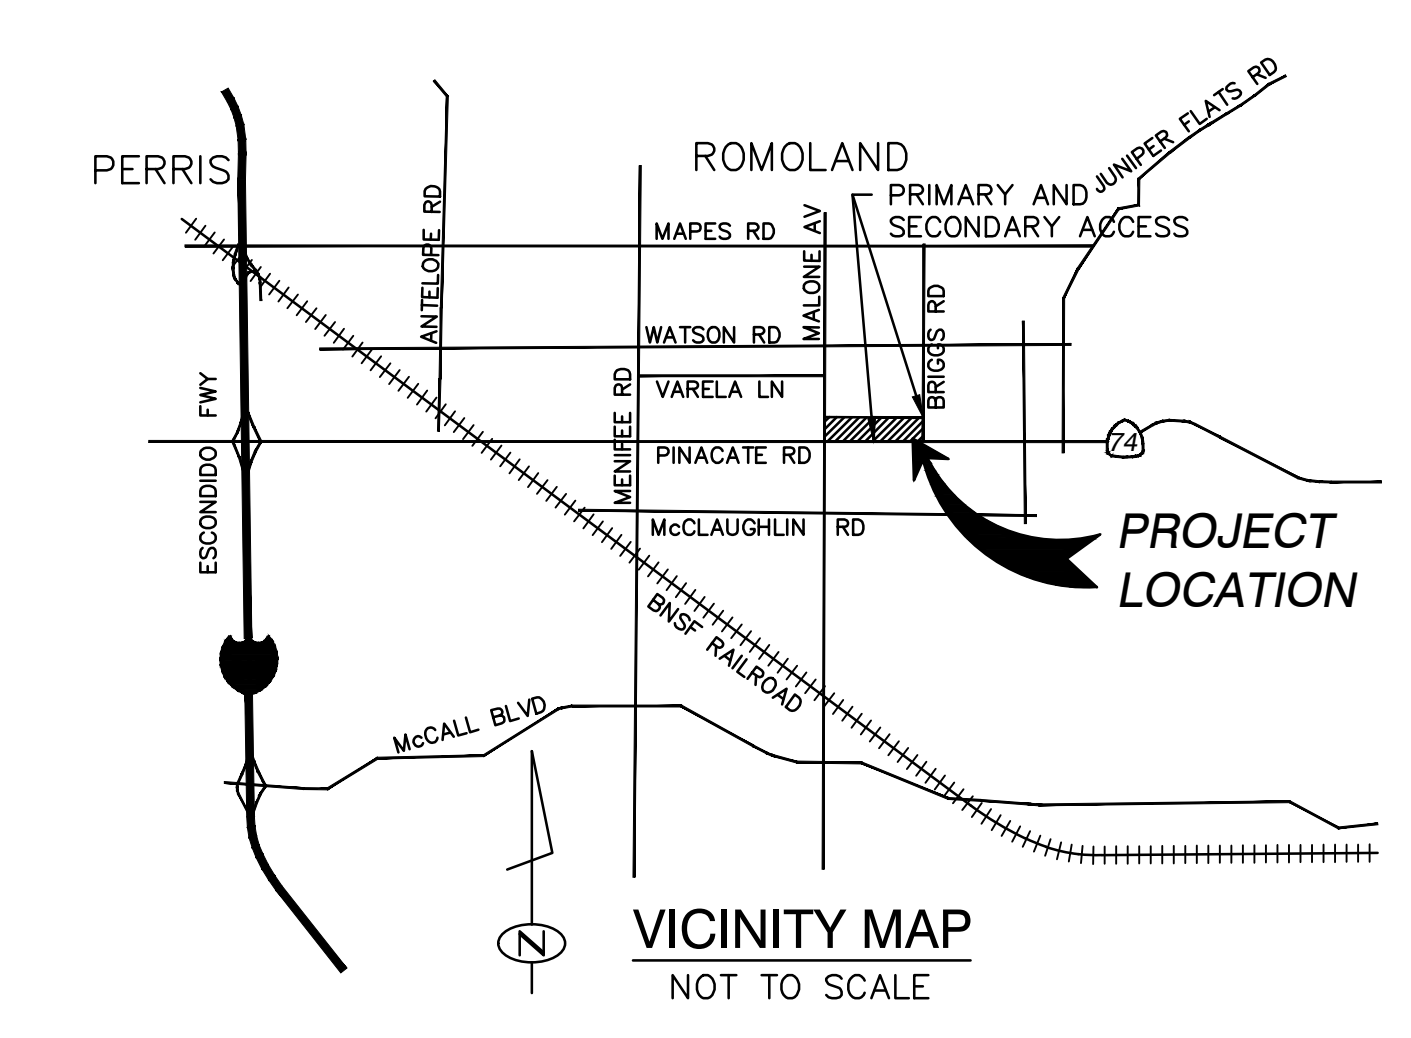

VICINITY MAP
 NOT TO SCALE

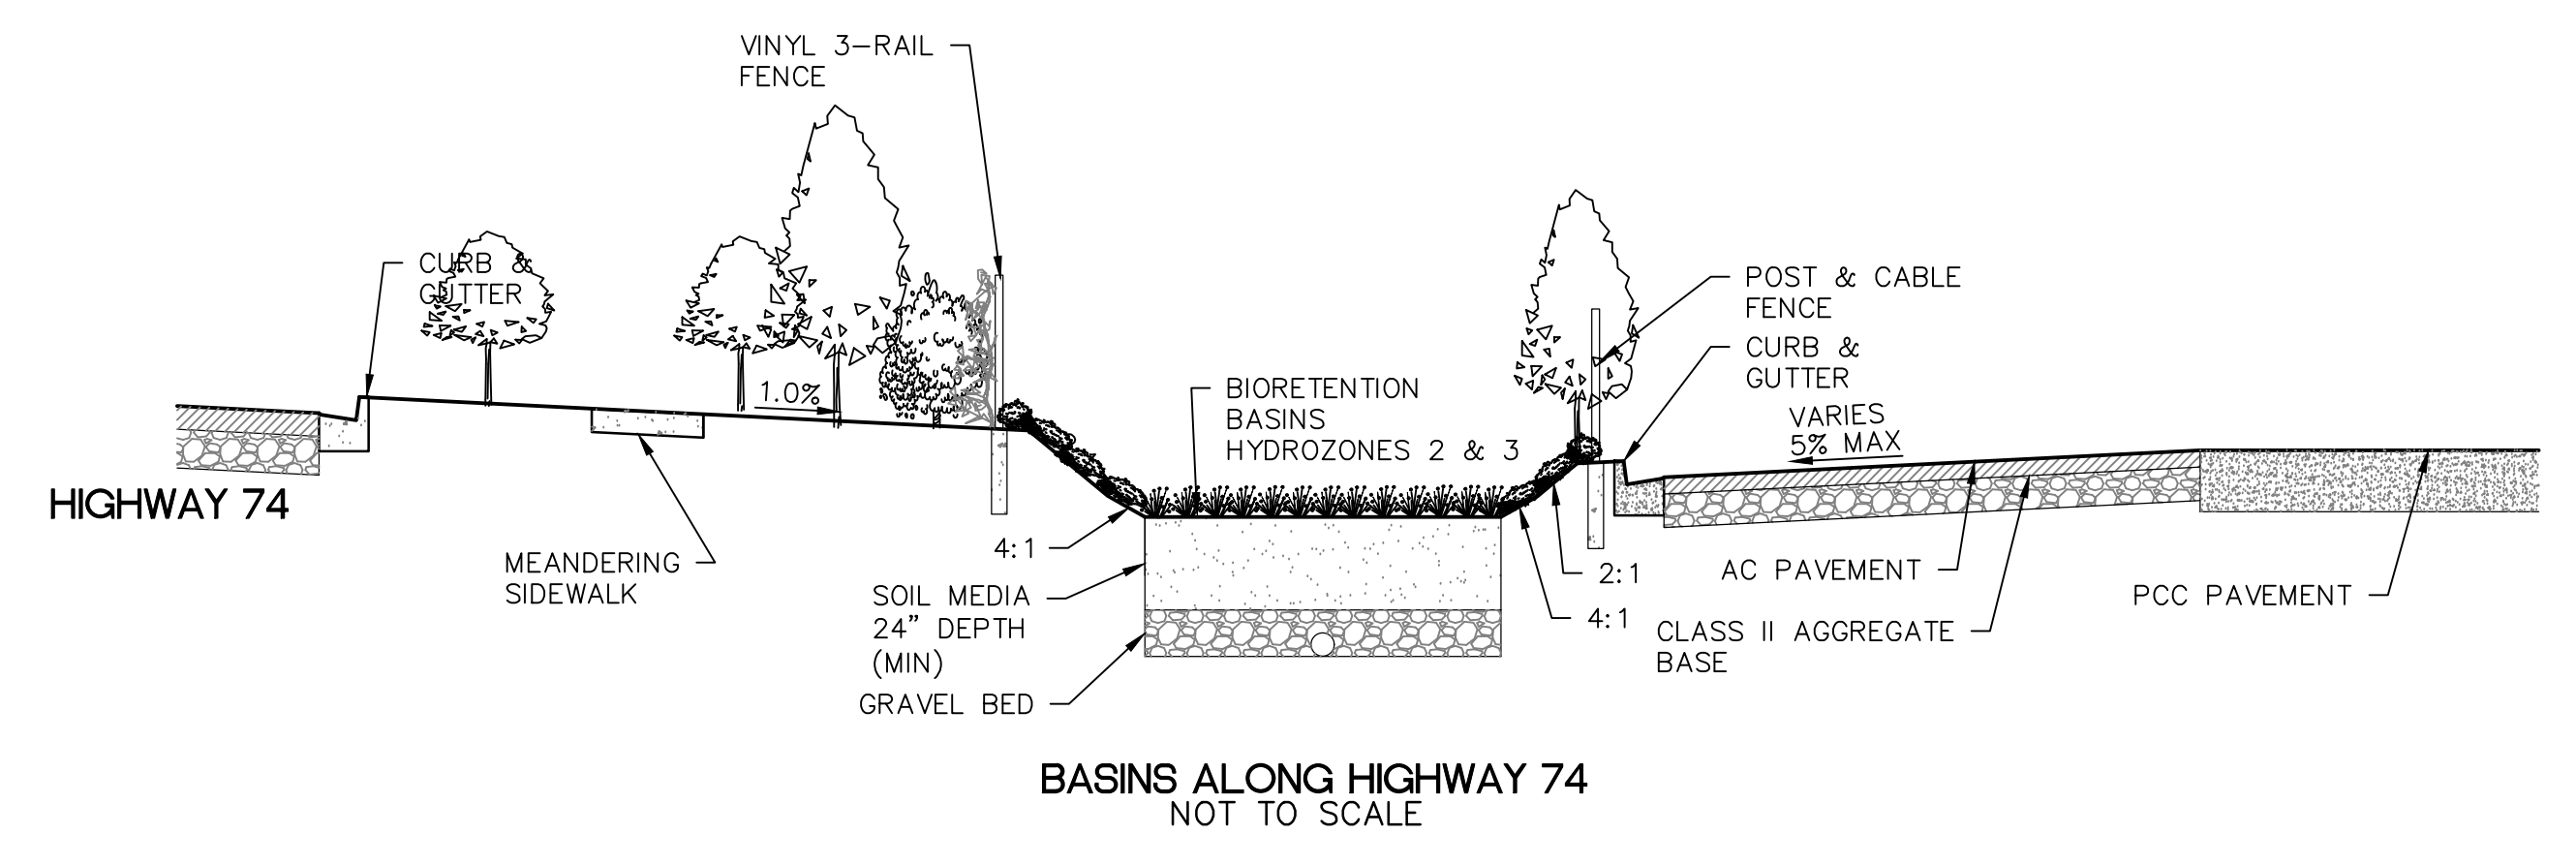


BASINS ALONG HIGHWAY 74
 NOT TO SCALE

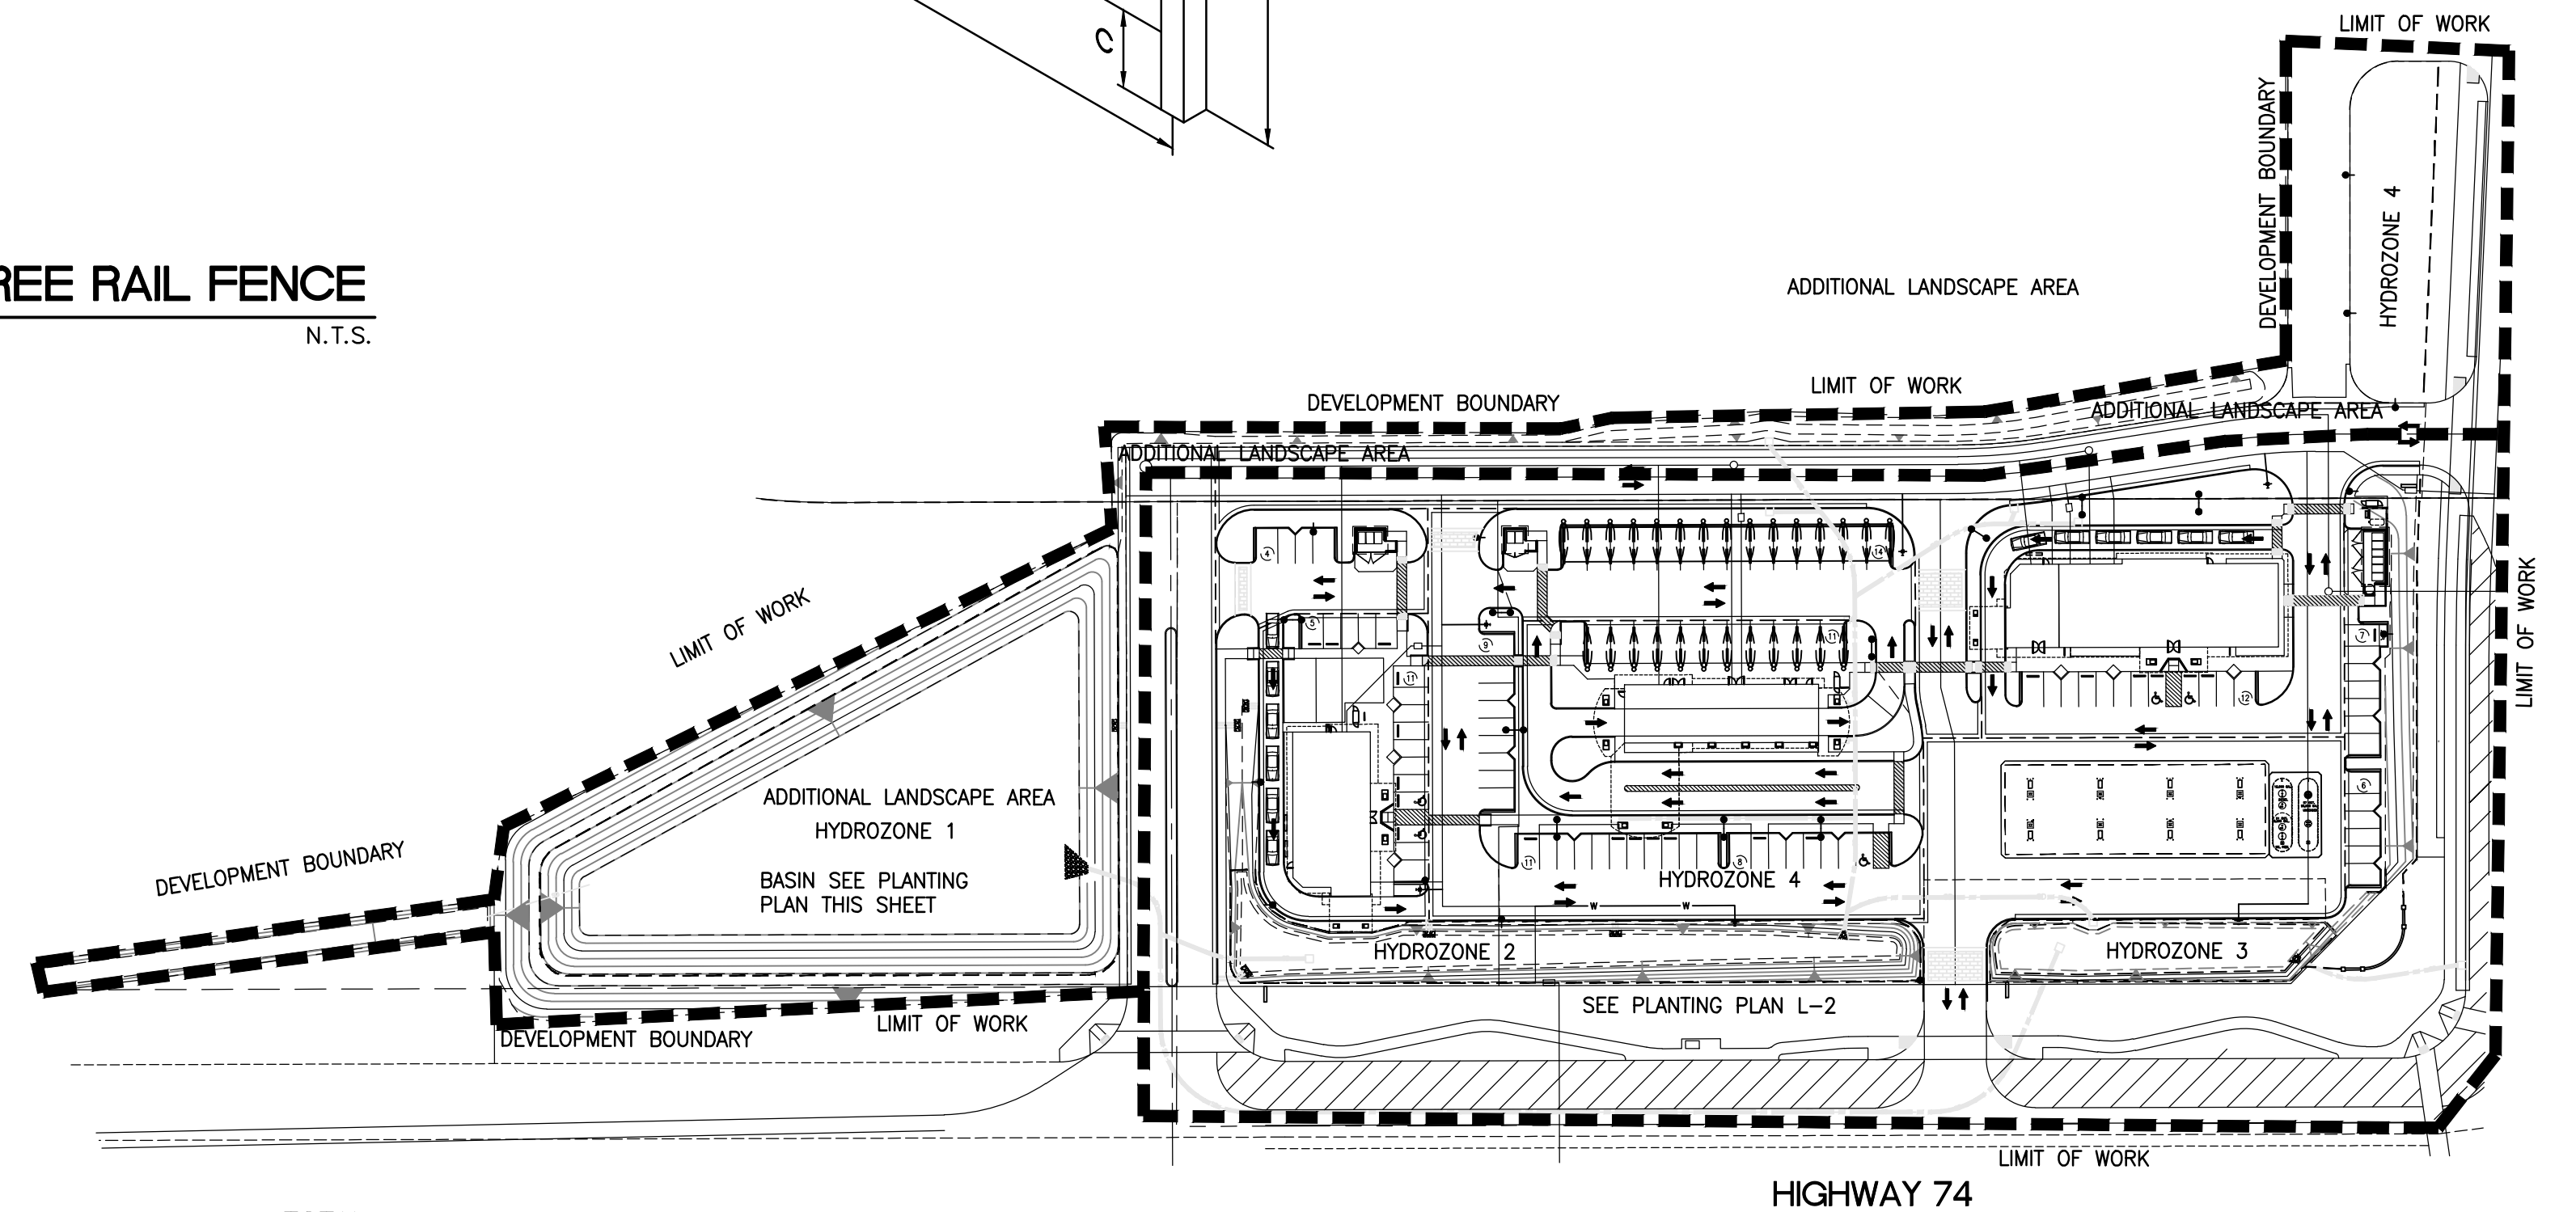

TOTAL SITE WITHOUT ADDITIONAL LANDSCAPE AREA - 219,542 S.F.
 TOTAL LANDSCAPE AREA FOR ABOVE SITE AREA - 60,542 S.F.

SITE MAP
 NOT TO SCALE

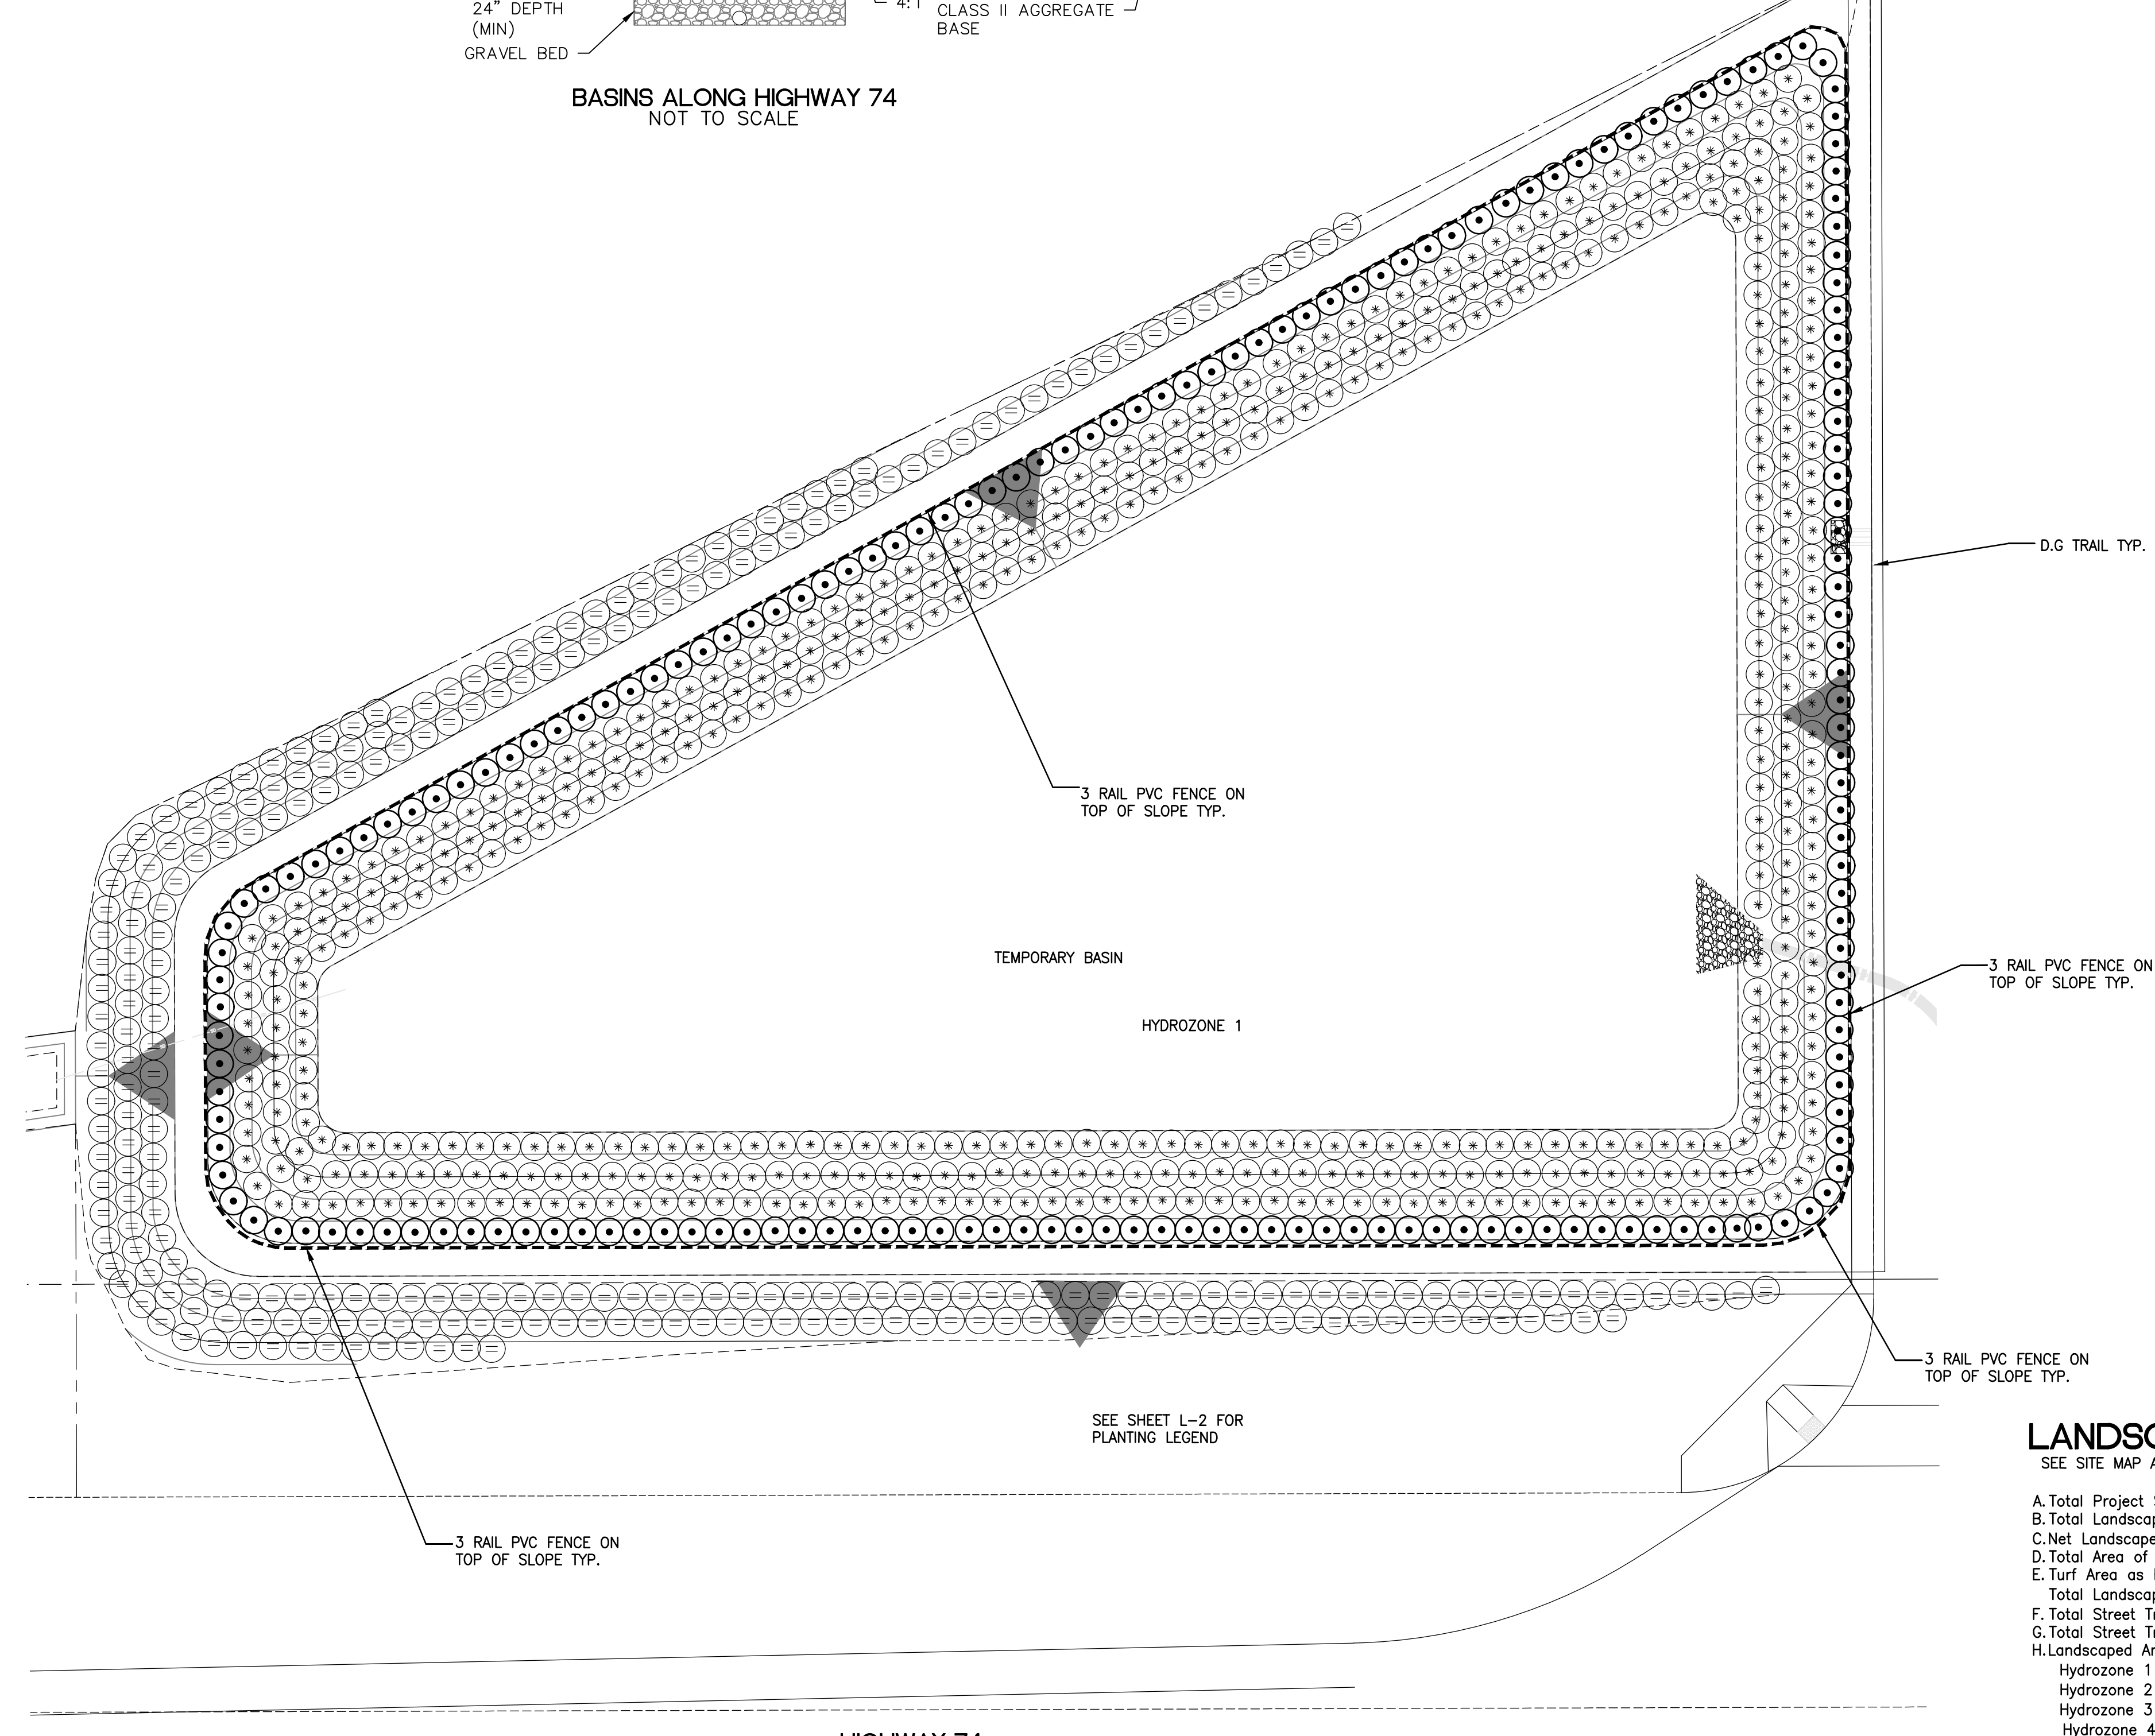

LANDSCAPE CALCULATIONS
 SEE SITE MAP ABOVE

| | |
|--|--------------|
| A. Total Project Site Area: W/Additional Landscape) | 274,555 s.f. |
| B. Total Landscaped Area: | 101,292 s.f. |
| C. Net Landscaped Area Percentage (B ÷ A): | 36.8 % |
| D. Total Area of Turf: | 0 s.f. |
| E. Turf Area as Percentage of Total Landscaped Area (D ÷ B): | 0 % |
| F. Total Street Trees Required (1 tree/30 l.f.): | 39 ea |
| G. Total Street Trees Provided: | 55 ea |
| H. Landscaped Areas by Hydrozone: | |
| Hydrozone 1 (Offsite W. Basin): | 28,928 s.f. |
| Hydrozone 2 (SW Basin): | 2,355 s.f. |
| Hydrozone 3 (S Basin): | 1,440 s.f. |
| Hydrozone 4 (Interior Landscape) | 68,569 s.f. |

WATER CALCULATIONS

LANDSCAPE IRRIGATION WATER ANALYSIS


| | |
|---|--------------------------|
| Project ETo: | 57.33 |
| ANNUAL MAXIMUM APPLIED WATER BUDGET: (BILLING UNITS/YEAR) | |
| AMA(WB-ETo)(0.5)(Total Sq Ft) | 1200 |
| $57.33 \times 0.5 \times 101,292$ | 2,420 BILLING UNITS/YEAR |
| | 1809970 Gallons Per Year |
| ESTIMATED ANNUAL WATER USE: (BILLING UNITS/YEAR) | |
| EAWU-(ETo)(C)(Coef)(Hydrozone Sq Ft) | |
| (Distribution Efficiency)(Application Efficiency)(1200) | |
| HYDROZONE # 1: (Medium Shrub Area with dip) | |
| $57.33 \times 0.5 \times 400$ | 12 B.U./Yr |
| $0.9 \times 0.85 \times 1200$ | 9343 Gallons Per Year |
| HYDROZONE # 2: (Low Shrub Area with dip) | |
| $57.33 \times 0.2 \times 100,892$ | 1,260 B.U./Yr |
| $0.9 \times 0.85 \times 1200$ | 942600 Gallons Per Year |
| ANNUAL WATER BUDGET: | 2,420 B.U./Yr |
| | 1809970 Gallons Per Year |
| TOTAL ESTIMATED ANNUAL WATER: | 1,273 B.U./Yr |
| | 951943 Gallons Per Year |

IRRIGATION SYSTEM DESIGN STATEMENT


A PERMANENT AUTOMATIC WEATHER/ET-SENSING IRRIGATION SYSTEM SHALL BE DESIGNED AND INSTALLED TO IRRIGATE ALL PLANTING AREAS. THE DESIGN OF THE IRRIGATION SYSTEM SHALL EMPHASIZE WATER CONSERVATION AND PROVIDE EFFICIENT AND UNIFORM DISTRIBUTION OF IRRIGATION WATER. IF THE SITE IS PLANNED TO UTILIZE RECYCLED WATER IN THE LANDSCAPE, THEN THE IRRIGATION SYSTEM SHALL BE DESIGNED IN ACCORDANCE WITH THE STATE OF CALIFORNIA AND EASTERN MUNICIPAL WATER DISTRICT (EMWD) RULES AND REGULATIONS FOR RECYCLED WATER USE.

DRIP AND/OR BUBBLER IRRIGATION, OR LOW-VOLUME, LOW-PRESSURE MICRO-IRRIGATION SYSTEM AS APPROVED BY THE CITY OF MENEFEE AND EMWD, SHALL BE INSTALLED IN PLANTER AREAS TO PROVIDE WATER DIRECTLY TO THE ROOT ZONE OF PLANTS. THE IRRIGATION SYSTEM MAY UTILIZE EFFICIENT ROTATOR NOZZLES IN LARGE PLANTING AREAS, SUBJECT TO THE APPROVAL OF EMWD AND THE CITY. THE AUTOMATIC IRRIGATION SYSTEM SHALL BE DESIGNED IN ACCORDANCE WITH THE CITY OF MENEFEE ORDINANCE NO. 2009-61, "LANDSCAPE WATER USE EFFICIENCY REQUIREMENTS" AND CITY LANDSCAPE STANDARDS.

FOR SITES UTILIZING POTABLE WATER FOR LANDSCAPE IRRIGATION, A REDUCED PRESSURE BACKFLOW PREVENTER SHALL BE INSTALLED AFTER THE WATER METER TO PROTECT THE POTABLE WATER SUPPLY IN ACCORDANCE WITH STATE OF CALIFORNIA, CITY OF MENEFEE, AND EMWD STANDARDS AND REQUIREMENTS.

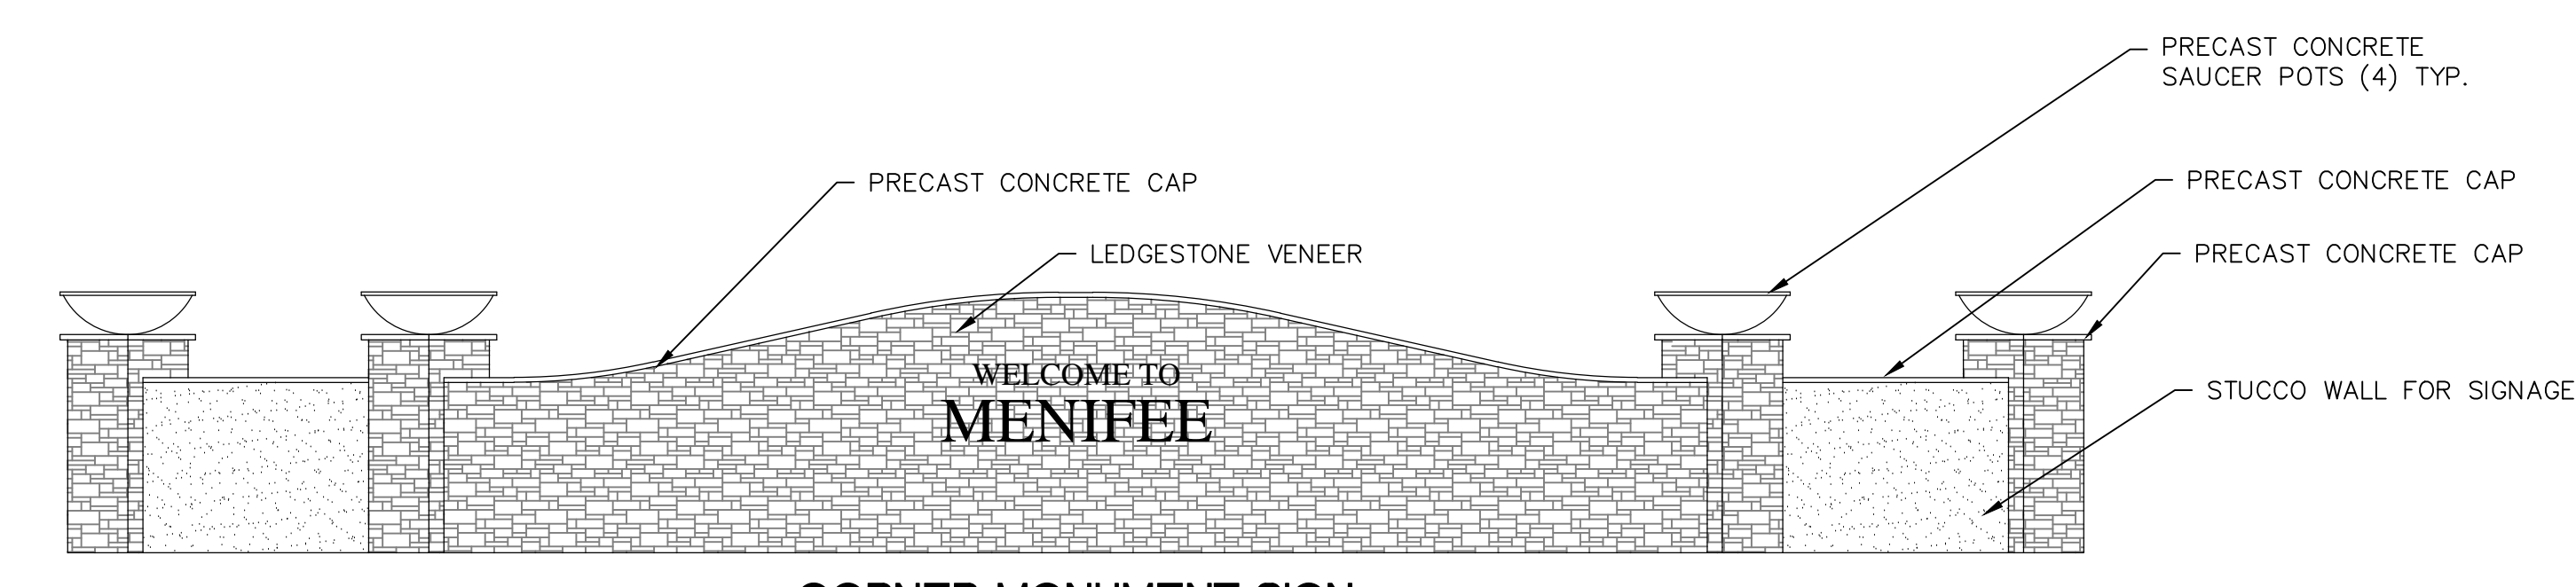

CORNER MONUMENT SIGN
 NOT TO SCALE

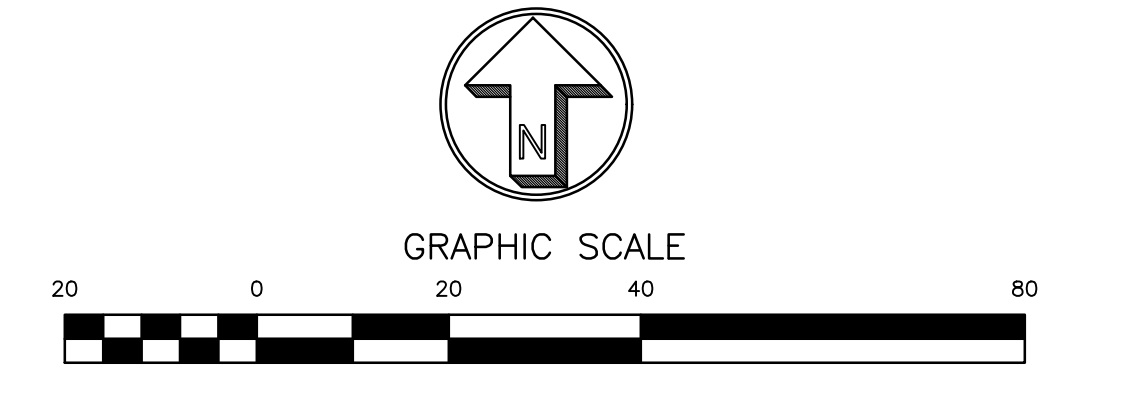

PRELIMINARY PLANTING PLAN SUBMITTAL LOG

| | |
|----------|---------------|
| 2-13-19 | 5th SUBMITTAL |
| 12-21-18 | 4th SUBMITTAL |
| 9-13-18 | 3rd SUBMITTAL |
| 2-7-18 | 2nd SUBMITTAL |
| 8-01-17 | 1ST SUBMITTAL |

PRELIMINARY PLANTING PLAN

PLANTING LEGEND

Table with columns: SYMBOL, BOTANICAL NAME, COMMON NAME, SIZE, NUMBER, REMARKS, WUCOLS IV. Lists various trees, shrubs, vines, and mulch types with their respective specifications.

NOTES:

- 1. ALL PLANTING AND IRRIGATION SHALL CONFORM TO THE CITY OF MENIFEE MUNICIPAL CODE CHAPTER 15.04, "LANDSCAPE WATER USE EFFICIENCY REQUIREMENTS" AND STATE OF CALIFORNIA A.S. 1871 (2015).
2. LINEAR DEEP ROOT BARRIERS SHALL BE INSTALLED FOR ANY TREES WITHIN 6' FROM ANY HARDSCAPE TYP.
3. ALL MATURE PLANTING SHALL NOT INTERFERE WITH UTILITY LINES OR TRAFFIC SITE LINES.
4. ALL UTILITIES SHALL BE SCREENED W/ PLANTING TYP.
5. ALL PLANTING SHALL RECEIVE 3" DEEP OF MULCH SPECIFIED IN THE LEGEND.
6. ALL PROPOSED IRRIGATION SHALL BE POINT TO POINT DRIP IRRIGATION TYP.
7. ALL GROUND MOUNTED MECHANICAL OR UTILITY EQUIPMENT (IF ANY) SHALL BE SCREENED WITH THE TEXAS RANGER OR OTHER DENSE EVERGREEN SHRUB.
8. LANDSCAPE IMPROVEMENTS IN OFF SITE AREAS/PUBLIC RIGHTS-OF-WAY SHALL BE SEPARATED FROM PRIVATELY-MAINTAINED ON SITE LANDSCAPE AREAS WITH A CITY STANDARD, CONTINUOUS CONCRETE MOW CURB (6"x8") ALONG THE PROPERTY LINE (ON SITE).
9. TREES & SHRUBS SHALL BE PLACED A MINIMUM OF 5' AWAY FROM WATER METER, GAS METER, OR SEWER LATERALS; A MINIMUM OF 10' AWAY FROM UTILITY POLES; & A MINIMUM OF 8' AWAY FROM FIRE HYDRANTS & FIRE DEPARTMENT SPRINKLER & STANDPIPE CONNECTIONS.
10. LANDSCAPING WITHIN CALTRANS RIGHT-OF-WAY SHALL COMPLY WITH SECTION 506 ("LANDSCAPE") OF CALTRANS ENCROACHMENT PERMIT MANUAL.

LANDSCAPE MAINTENANCE NOTE



THE LANDSCAPE CONCEPT PLAN INDICATES LANDSCAPE IMPROVEMENTS FOR BOTH ON SITE AND OFF SITE (PUBLIC RIGHTS-OF-WAY, PARKS, ETC) AREAS. THE PROPERTY OWNER SHALL MAINTAIN OFF SITE AREAS UNTIL SUCH TIME AS THE OFF SITE LANDSCAPE AREAS ARE ANNEXED INTO A SPECIAL DISTRICT (CFD OR L&LMD) AND ACCEPTED BY THE CITY FOR MAINTENANCE PURPOSES. THE PROPERTY OWNER ACKNOWLEDGES THAT SEPARATE WATER METERS FOR IRRIGATION USE ARE REQUIRED TO BE INSTALLED BY THE OWNER PRIOR TO THE CITY'S ACCEPTANCE OF THE OFF SITE AREAS FOR MAINTENANCE BY THE SPECIAL DISTRICT. IN ADDITION PROPERTY OWNER ACKNOWLEDGES THAT THE COSTS FOR ANNEXATION INTO THE SPECIAL DISTRICT AND INSTALLATION OF THE IRRIGATION WATER METERS, SHALL BE BORNE BY THE PROPERTY OWNER.

PARKING LOT SHADE REQUIREMENT



TOTAL PARKING AREA = 16,038 S.F.
50% PARKING AREA SHADE REQUIRED = 8,019 S.F.
TOTAL PARKING AREA SHADED = 11,820 S.F.

PRELIMINARY PLANTING PLAN SUBMITTAL LOG

Table with columns: DATE, SUBMITTAL. Lists dates from 2-13-19 to 8-01-17 and corresponding submittal numbers (1st to 5th).

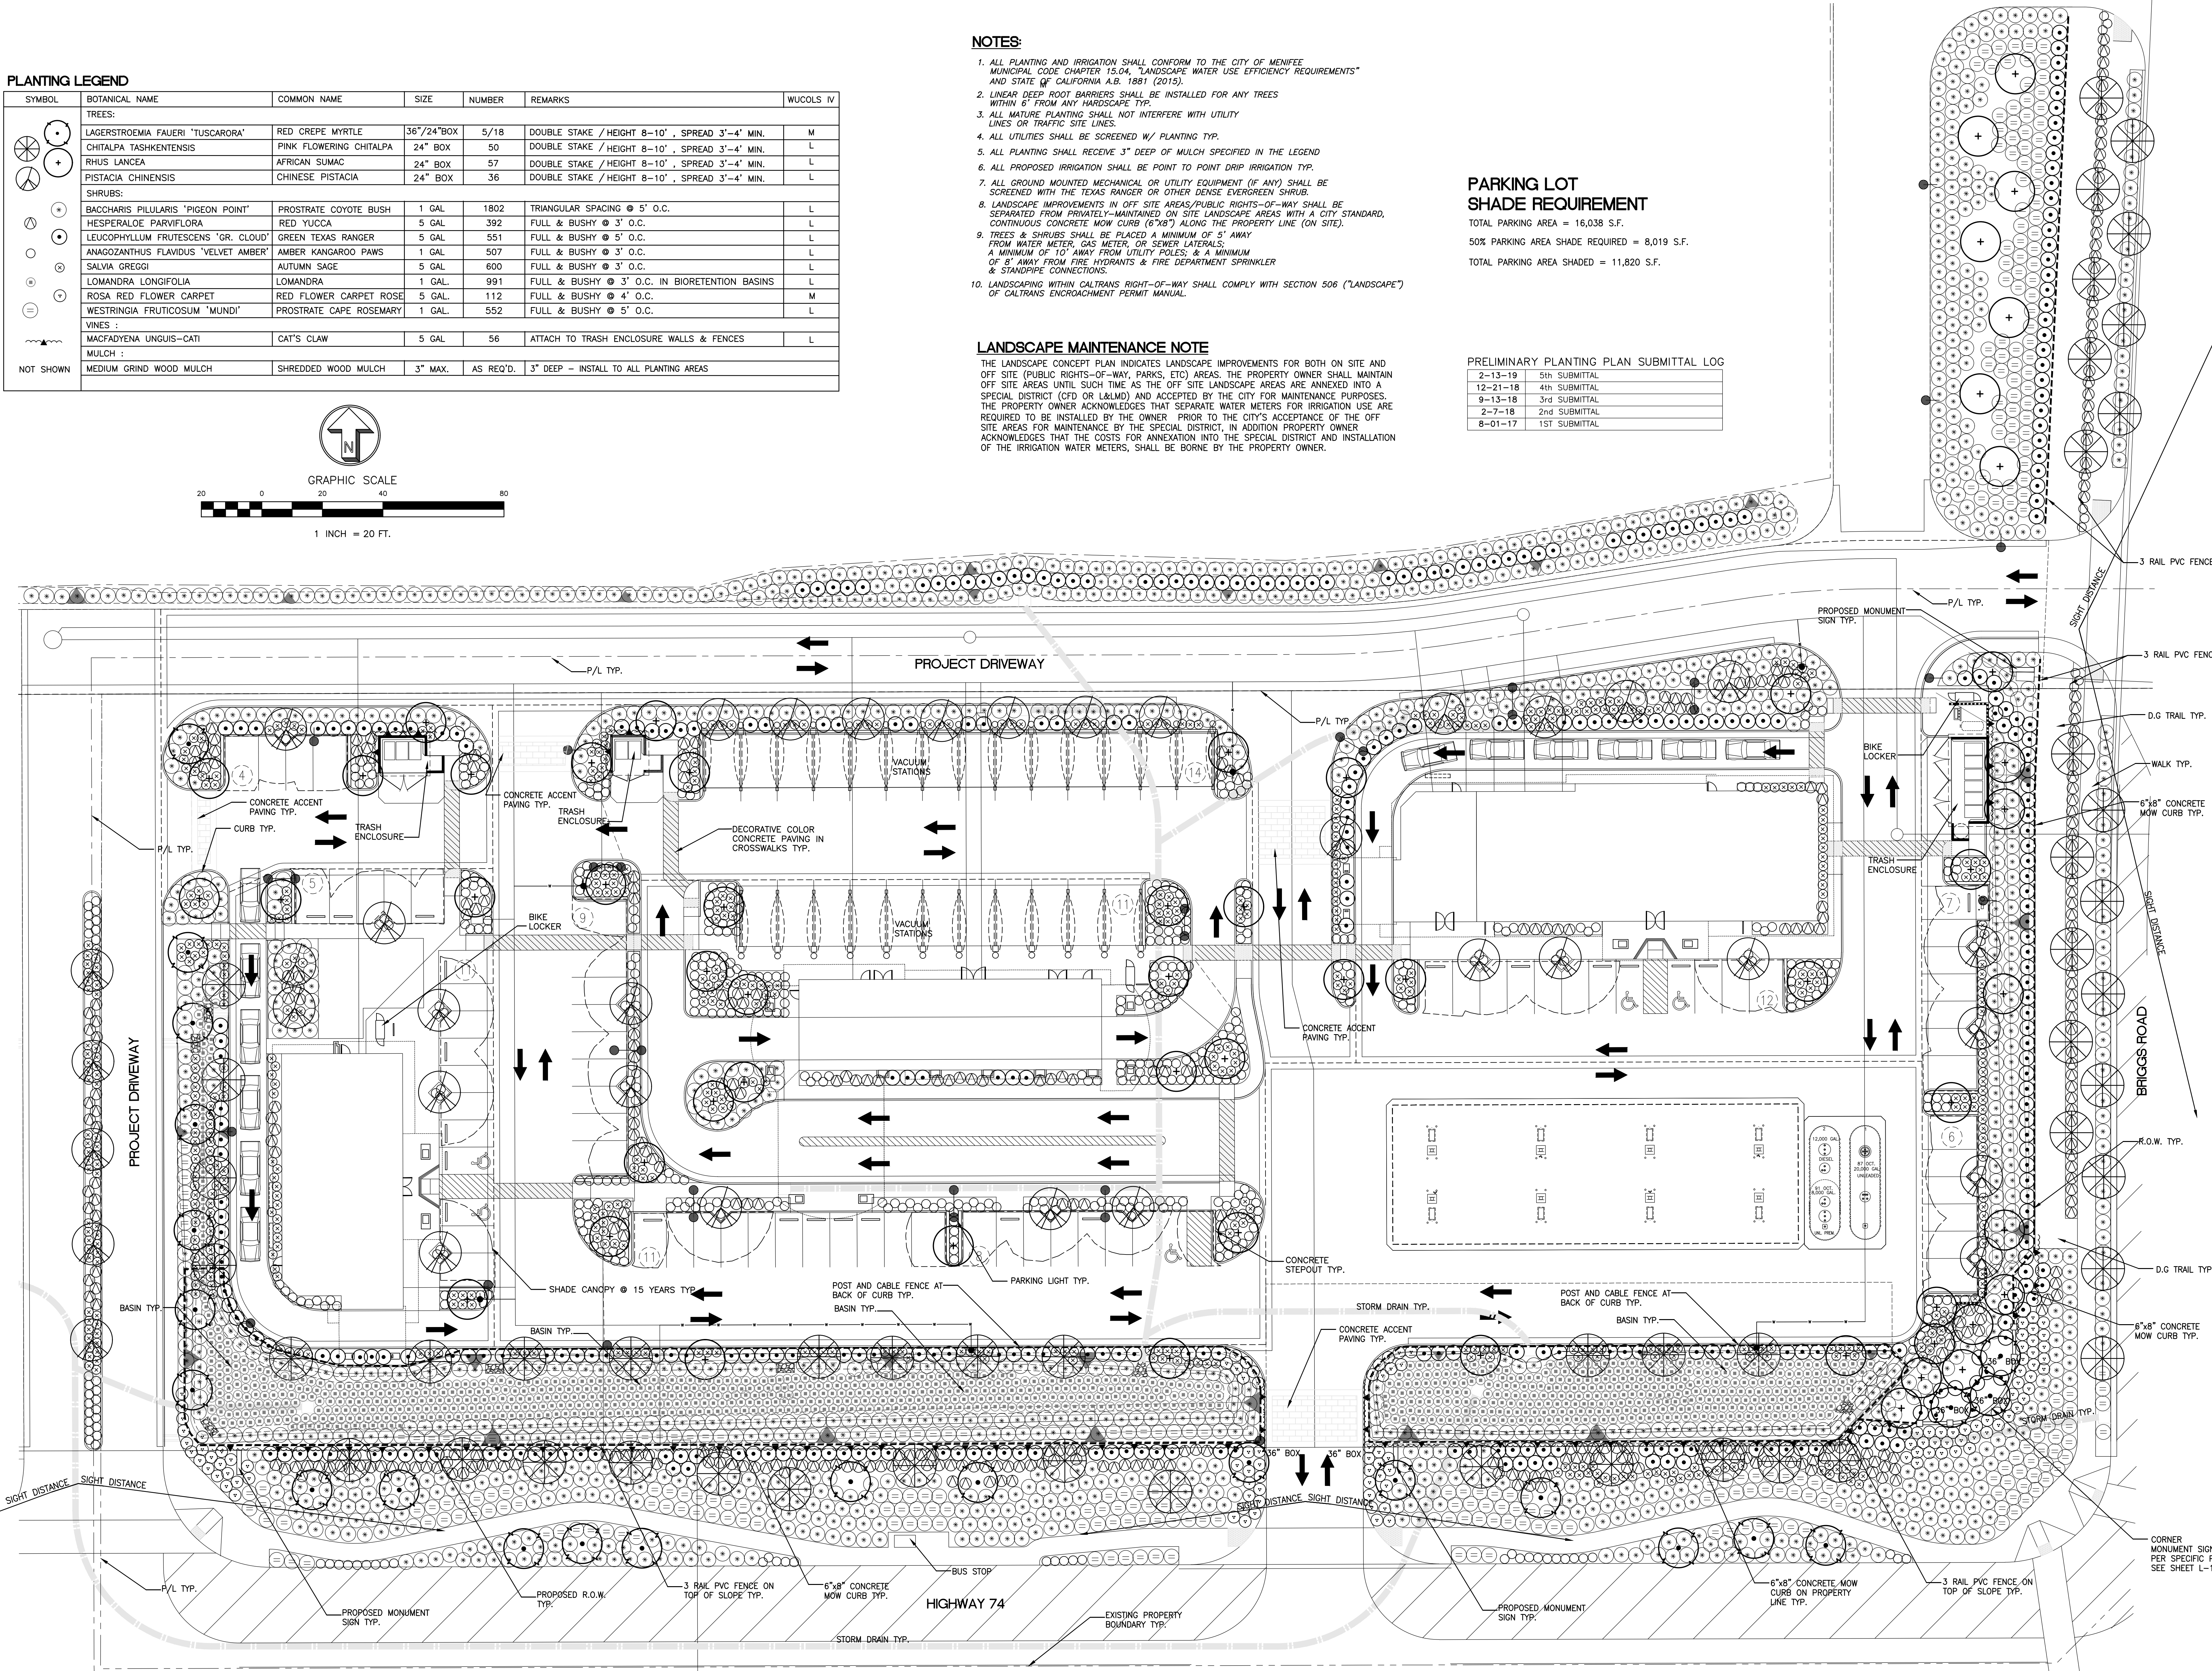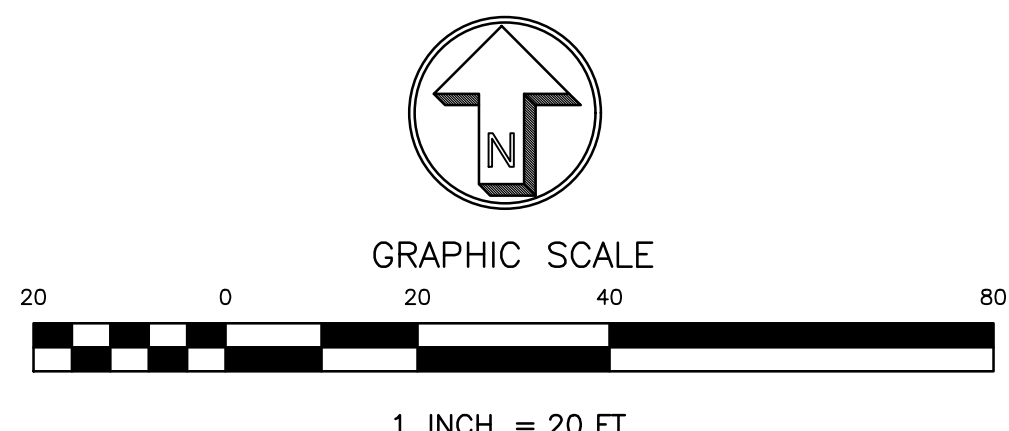

ALHAMBRA GROUP
LANDSCAPE ARCHITECTURE
California license #2017
RECREATION FACILITIES PLANNING
41635 Enterprise Circle North, Suite C
Temecula, CA 92590 (951) 296-6602 FAX 296-6803

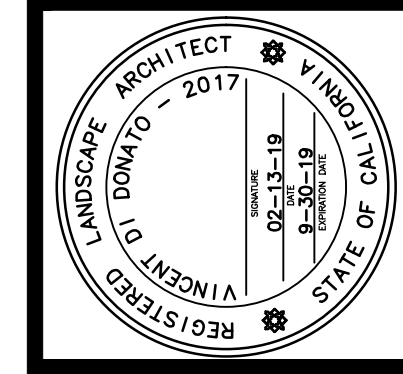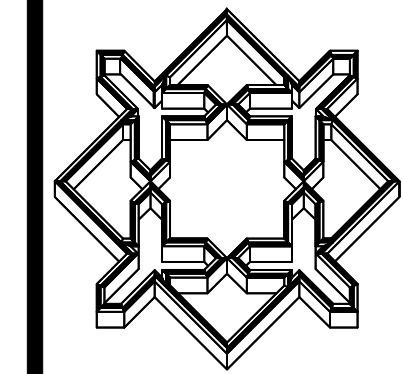

PROJECT: BRIGGS and 74, LLC CENTER
OWNER: BRIGGS and 74, LLC CO/ MR56 LLC/ RANCON GROUP
41391 KALAMIA ST. SUITE 200
MURRIETA, CA 92562 (651) 200-2867 CONTACT: DAN LONG


drawn: V.D.
checked: V.D.
date: 2-7-18
SHEET L-2 of 2 sheets
JOB NO. 17-122

PRELIMINARY PLANTING PLAN



ALL IDEAS, DESIGNS, & ARRANGEMENTS REPRESENTED HEREON ARE THE PROPERTY OF ALHAMBRA GROUP LANDSCAPE ARCHITECTS & SHALL BE USED FOR THIS PROJECT ONLY EXCEPT WITH THE WRITTEN PERMISSION OF SAID ARCHITECTS. ANY CHANGE MADE BY PARTIES OTHER THAN SAID ARCHITECTS SHALL RELIEVE ARCHITECTS OF RESPONSIBILITY FOR THE FACILITY OR AFFECTED PORTION THEREOF. CONTRACTORS SHALL VERIFY ALL DIMENSIONS AND CONDITIONS PRIOR TO THE START OF ANY WORK & SHALL REPORT ANY DISCREPANCY TO THE ARCHITECT.

| Luminaire Schedule | | | | | | | | |
|--------------------|-----|-------|-------------|-------------------------------------|-------|-------------|------------------|------------|
| Symbol | Qty | Label | Arrangement | Description | LLF | Lumens/Lamp | Arr. Lum. Lumens | Arr. Watts |
| | 24 | A | SINGLE | CRUS-SC-LED-VHD-50 MTD @ 28.5' | 1.000 | N.A. | 22418 | 159.1 |
| | 13 | B | SINGLE | XDLM-FT-LED-HO-CW-SINGLE-14' MT HGT | 1.000 | N.A. | 19927 | 204.7 |
| | 10 | C | D180° | XDLM-FT-LED-HO-CW-SINGLE-14' MT HGT | 1.000 | N.A. | 39854 | 409.4 |
| | 18 | D | SINGLE | AD150-10-CW-LED VARIOUS HGTS | 1.000 | N.A. | 905 | 11.4 |
| | 27 | E | SINGLE | XPG3-S-LED-50-550-CW-UE MTD @ 10' | 1.000 | N.A. | 8952 | 90.4 |

| Calculation Summary | | | | | | | |
|------------------------|-------------|-------|-------|------|------|---------|---------|
| Label | CalcType | Units | Avg | Max | Min | Avg/Min | Max/Min |
| ALL CALC POINTS | Illuminance | Fc | 3.95 | 53.6 | 0.0 | N.A. | N.A. |
| GAS CANOPY | Illuminance | Fc | 37.30 | 48.8 | 20.6 | 1.81 | 2.37 |
| INSIDE CURB C-STORE | Illuminance | Fc | 7.85 | 24.3 | 1.0 | 7.85 | 24.30 |
| INSIDE CURB CAR WASH | Illuminance | Fc | 6.05 | 29.9 | 0.3 | 20.17 | 99.67 |
| INSIDE CURB RESTAURANT | Illuminance | Fc | 8.43 | 33.4 | 0.8 | 10.54 | 41.75 |

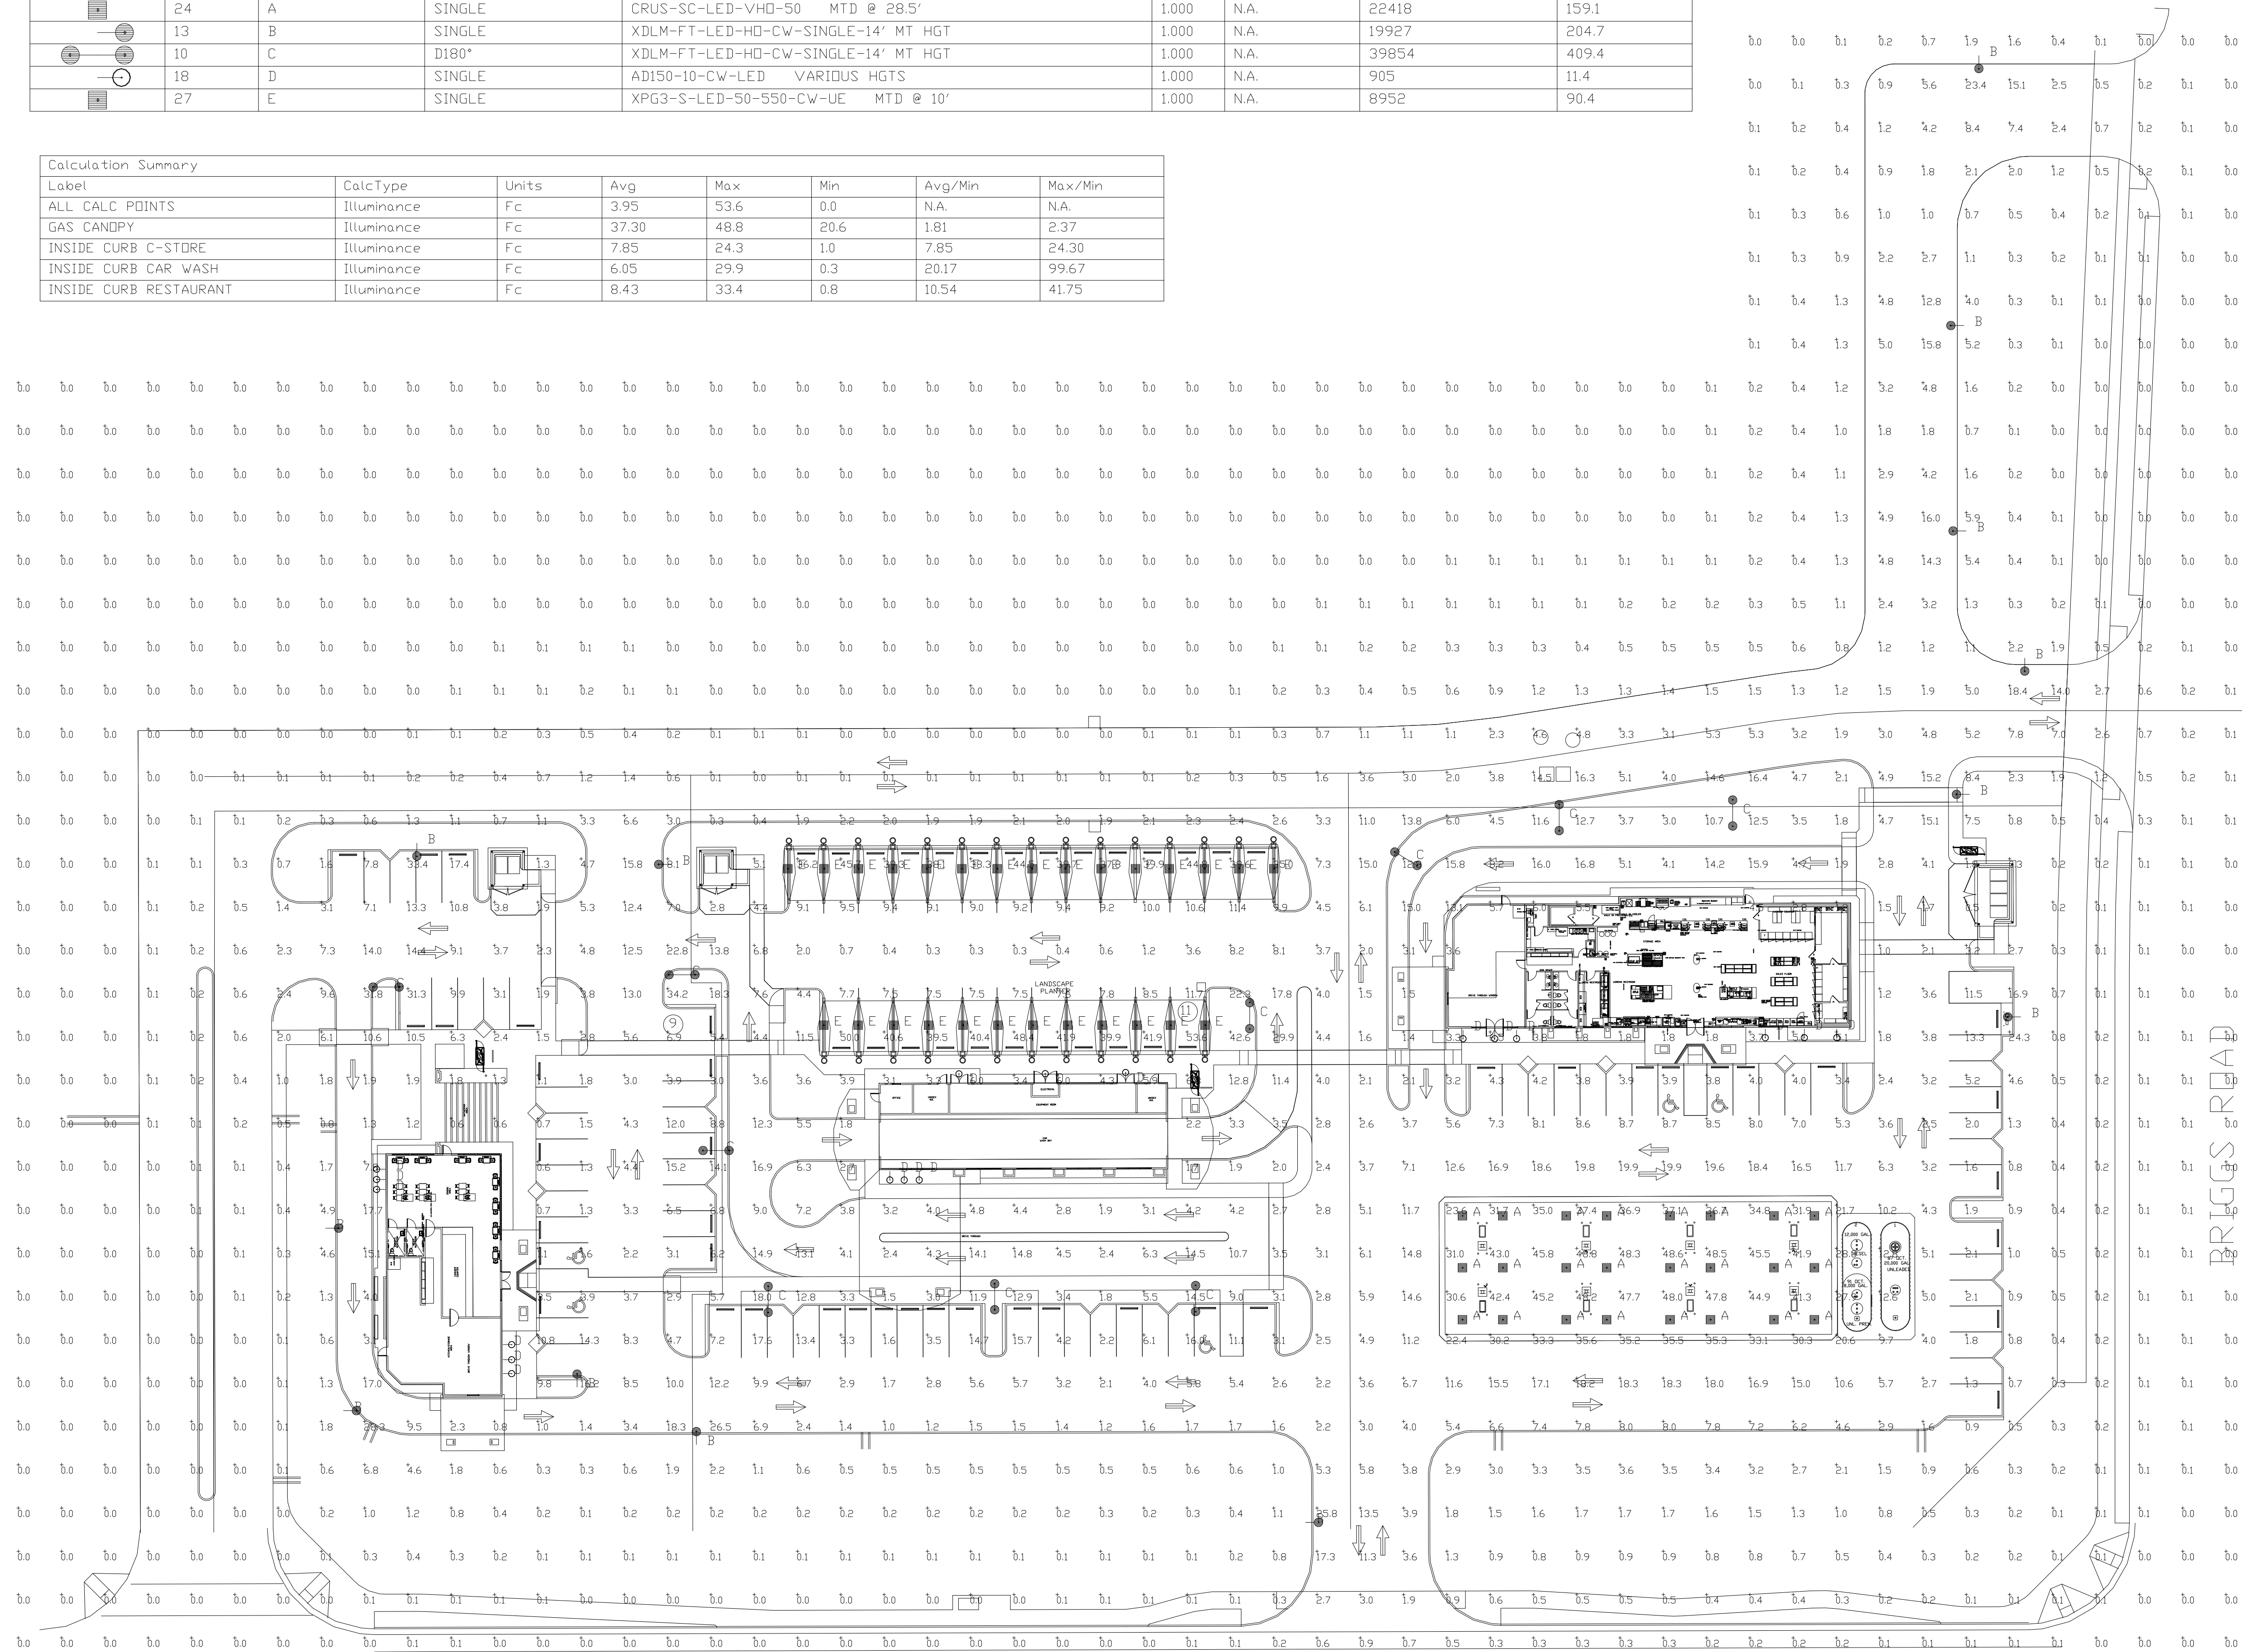

**CRUS-SC-LED
LED CANOPY LIGHT - LEGACY**

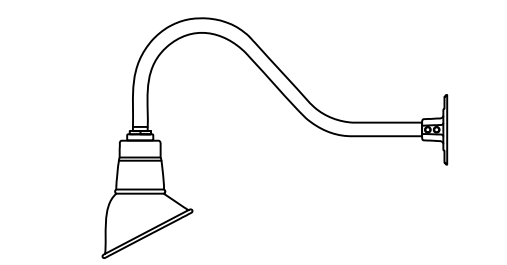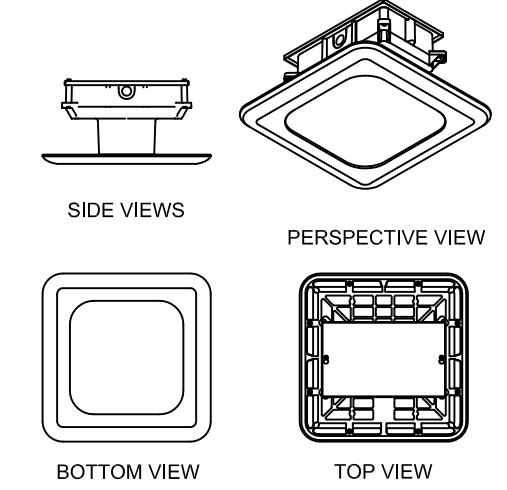

**RLM ANGLED
REFLECTOR**




Based on the information provided, all dimensions and luminaire locations shown represent recommended positions. The engineer and/or architect must determine the applicability of the layout to existing or future field conditions.

This lighting plan represents illumination levels calculated from laboratory data taken under controlled conditions in accordance with The Illuminating Engineering Society (IES) approved methods. Actual performance of any manufacturer's luminaires may vary due to changes in electrical voltage, tolerance in lamps/LED's and other variable field conditions. Calculations do not include obstructions such as buildings, curbs, landscaping, or any other architectural elements unless noted. Fixture nomenclature noted does not include mounting hardware or poles. This drawing is for photometric evaluation purposes only and should not be used as a construction document or as a final document for ordering product.

HIGHWAY 74

Total Project Watts
Total Watts = 13219.52

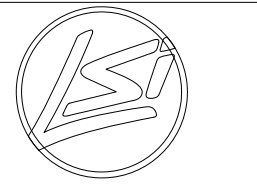

LIGHTING PROPOSAL LD-141445-1

BRIGGS AND HIGHWAY 74 LP
HWY 74 & BRIGGS RD
MENEFEE, CA

BY: MVE DATE: 01-18 REV: 07-18 SHEET 1 OF 1

SCALE: 1"=30'

LSI ABOLITE® LED ANGLED REFLECTOR (AD)




Directional Optics



Symmetrical Optics

DIMENSIONS

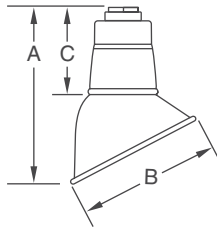

| Prefix | Height (A) | Diameter (B) | Neck (C) | Weight (lbs./kg) |
|--------|-----------------|--------------|----------------|------------------|
| AD 100 | 10" (254mm) | 7" (178mm) | 5" (127mm) | 2.0 (.9kg) |
| AD 150 | 11-1/2" (292mm) | 9" (229mm) | 5-1/4" (133mm) | 2.0 (.9kg) |
| AD 200 | 13-1/2" (343mm) | 11" (279mm) | 5-1/2" (140mm) | 2.5 (1.1kg) |

Also available in traditional light sources

US patents D598162 & D581585 & D581544 & 7697766 and US & Int'l. patents pending

APPLICATIONS - Signage Lighting and Accent Lighting. Interior or Exterior.

PRODUCT HIGHLIGHTS

- **“Green” Energy-Saving** - Reduces greenhouse gas emissions, slashes operating costs, extends life and eliminates costly lamp disposal involving mercury waste.
- **Long Lasting Sparkle** - LED light beam contains no heat, and no UV, which means degradation in color or quality of the product under display is minimized.
- **Dramatically Lower Maintenance Costs** - 60,000-hour LED source extends life 3 to 5 times as compared to conventional HID sources, 30 times incandescent.
- **Integrated Power Supply** - Built into fixture allowing RLM to be connected directly to line voltage.

EXPECTED LIFE - Minimum 60,000 hours to 100,000 hours depending upon the ambient temperature of the installation location.

LEDS - Select high-brightness LEDs in Cool White (5000K), Neutral White (4000K), and Warm White (3500K) color temperature. 70 CRI CW. 80 CRI NW and WW.

OPTIONAL DIRECTIONAL OPTICS - Allows field adjustment of the light beam for directional illumination of signage.

REFLECTOR - Heavy duty spun galvanized steel construction with polyester powder coat finish.

LIGHT OUTPUT - With an input power of 11 watts: DO - Optional Directional Optics (nominal) - Cool White - 970 lumen, Neutral White - 810 lumens and Warm White - 745 lumens. Symmetric Optics (nominal) - Cool White - 905 lumens, Neutral White - 760 lumens and Warm White - 700 lumens

MOUNTING - Fixed hub tapped for 3/4" NPT conduit. Pre-wired with 96" leads. Not designed for uplight applications.

ELECTRICAL - Integral, surge protected power supply operates on 120-240 VAC (50/60Hz) input; no external power supplies required.

DRIVER - State-of-the-art driver designed specifically for RLM fixtures provides unsurpassed system efficiency. Components are fully encased in potting material for moisture resistance. Driver complies with IEC and FCC standards.

OPERATING TEMPERATURE - -40°C to +50°C (-40°F to +122°F).

FINISH - Available in either architectural textured, high gloss or satin finish.

WARRANTY - LSI LED fixtures carry a limited 5-year warranty.

LISTING - Listed to U.S. and Canadian safety standards. Suitable for wet locations.

This product, or selected versions of this product, meet the standards listed below. Please consult factory for your specific requirements.



Project Name _____ Fixture Type _____
 Catalog # _____

10/09/15
 © 2015
 LSI INDUSTRIES INC.

LSI ABOLITE® LED ANGLED REFLECTOR (AD)

LUMINAIRE ORDERING INFORMATION

TYPICAL ORDER EXAMPLE: **AD 200 10 CW LED UE MSV LDS96 WL DO**

| Prefix | # of LED's | Color Temperature | Light Source | Input Voltage | Reflector Color | Mounting | Options |
|---|------------|--|--------------|----------------------|--|---|-------------------------|
| AD 100 ¹ AD 150 ¹ AD 200 ¹ | 10 | CW - Cool White (5000K) NW - Neutral White (4000K) WW - Warm White (3500K) | LED | 120-240 ² | MSV-Metallic Silver GWT-Gloss White GBK-Gloss Black GRD-Gloss Red GPT-Textured Graphite RUS-Textured Rust SCP-Satin Copper STQ-Satin Turquoise SVG-Satin Verde Green | LDS96 WL - Factory prewired leads for use with stem or bracket mounting | DO - Directional Optics |

1- Cordsets not available for AD Series.

2- Fixture will not operate on 277VAC (120-240 only).

| CANOPY ORDERING INFORMATION (Accessories are field installed) | |
|---|--------------|
| Description | Order Number |
| 3/4" (19mm) Tap Decorative Box Cover Aligner - Gloss White | BC600 3 GWT |
| 3/4" (19mm) Tap Round Box Cover Aligner - Zinc | BC585 ZINC |
| 3/4" (19mm) Tap Square Box Cover Aligner - Zinc | BC585SQ ZINC |

- Standard BC600 finish is Gloss White Powder; other RLM colors available.

| WIRE GUARD ORDERING INFORMATION (Accessories are field installed) | |
|---|--------------|
| Description | Order Number |
| 7" (178mm) Convex Wire Guard - Metallic Silver | COG 7 MSV |
| 9" (229mm) Convex Wire Guard - Metallic Silver | COG 9 MSV |
| 11" (279mm) Convex Wire Guard - Metallic Silver | COG 11 MSV |

- Standard finish is Metallic Silver Powder; other RLM colors available.

| CONDUIT SYSTEM ORDERING INFORMATION (Accessories are field installed) | |
|---|--------------|
| Description | Order Number |
| 3/4" x 3" (19mm x76mm) Aluminum Stem - Gloss White | ST 3 3 GWT |
| 3/4" x 6" (19mm x152mm) Aluminum Stem - Gloss White | ST 6 3 GWT |
| 3/4" x 12" (19mm x .4m) Aluminum Stem - Gloss White | ST 12 3 GWT |
| 3/4" x 18" (19mm x .5m) Aluminum Stem - Gloss White | ST 18 3 GWT |
| 3/4" x 24" (19mm x .6m) Aluminum Stem - Gloss White | ST 24 3 GWT |
| 3/4" x 36" (19mm x .9m) Aluminum Stem - Gloss White | ST 36 3 GWT |
| 3/4" x 48" (19mm x 1.2m) Aluminum Stem - Gloss White | ST 48 3 GWT |
| 3/4" x 60" (19mm x 1.5m) Aluminum Stem - Gloss White | ST 60 3 GWT |
| 3/4" x 72" (19mm x 1.8m) Aluminum Stem - Gloss White | ST 72 3 GWT |
| 3/4" (19mm) Alum. Stem Coupler - Gloss White | COP 3 GWT |

- Standard finish is Gloss White Powder; other RLM colors available.

| GOOSE NECK BRACKET ORDERING INFORMATION (Accessories are field installed) | |
|---|--------------|
| Description | Order Number |
| 3/4" (19mm) Aluminum Gooseneck Bracket - Gloss White | GB A 3 GWT |
| 3/4" (19mm) Aluminum Gooseneck Bracket - Gloss White | GB B 3 GWT |
| 3/4" (19mm) Aluminum Gooseneck Bracket - Gloss White | GB C 3 GWT |
| 3/4" (19mm) Aluminum Gooseneck Bracket - Gloss White | GB D 3 GWT |
| 3/4" (19mm) Aluminum Gooseneck Bracket - Gloss White | GB E 3 GWT |
| 3/4" (19mm) Aluminum Gooseneck Bracket - Gloss White | GB F 3 GWT |
| 3/4" (19mm) Aluminum Gooseneck Bracket - Gloss White | GB G 3 GWT |
| 3/4" (19mm) Aluminum Gooseneck Bracket - Gloss White | GB H 3 GWT |
| 3/4" (19mm) Aluminum Gooseneck Bracket - Gloss White | GB J 3 GWT |
| 3/4" (19mm) Aluminum Gooseneck Bracket - Gloss White | GB K 3 GWT |
| 3/4" (19mm) Aluminum Gooseneck Bracket - Gloss White | GB P 3 GWT |
| 3/4" (19mm) Aluminum Gooseneck Bracket - Gloss White | GB U 3 GWT |

| WALL BRACKETS ORDERING INFORMATION (Accessories are field installed) | |
|--|--------------|
| Description | Order Number |
| Contemporary Wall Bracket - Medium - Gloss White | CWBM 1 GWT |
| Contemporary Wall Bracket - Long - Gloss White | CWBL 1 GWT |
| Nostalgic Aluminum Wall Scroll Bracket - Gloss White | DWB 1 GWT |

BRACKETS

- See Indoor section for detail on bracket sizes and shapes.

- Standard finish is Gloss White Powder; colors available.

- Designed for mounting to recessed 4" (102mm) octagon box (by others).



Project Name _____ Fixture Type _____
Catalog # _____

10/09/15
© 2015
LSI INDUSTRIES INC.