# PROJECT DATA

CITY OF CHULA VISTA **APPLICABLE CODES:** 

2019 CALIFORNIA BUILDING CODE 2019 CALIFORNIA MECHANICAL CODE 2019 CALIFORNIA ELECTRICAL CODE

2019 CALIFORNIA PLUMBING CODE 2019 CALIFORNIA FIRE CODE (WITH LOCAL AMENDMENTS) 2019 STATE OF CALIFORNIA ENERGY CODE

2019 STATE OF CALIFORNIA GREEN BUILDING CODE 2019 STATE OF CALIFORNIA TITLE 24 ACCESSIBILITY STANDARDS TITLE 15 OF THE CHULA VISTA MUNICIPAL CODE (CVMC)

**ZONING CLASSIFICATION:** ILP (LIMITED INDUSTRIAL PRECISE PLAN)

LIMITED INDUSTRIAL **GENERAL PLAN DESIGNATION:** 

OCCUPANCY CLASSIFICATION:

PER CBC TABLE 508.4 - NO SEPARATION REQUIREMENT **OCCUPANCY SEPARATION:** 

TYPE OF CONSTRUCTION VB - PER CBC CHAPTER 6 (SECTION 602)

**SPRINKLERED: NUMBER OF STORIES:** 

**ASSESSOR'S PARCEL NO.: LEGAL DESCRIPTION:** 

THE LAND REFERRED TO HEREIN BELOW IS SITUATED IN THE CITY OF CHULA VISTA IN THE COUNTY OF SAN DIEGO, STATE OF CALIFORNIA. AND IS DESCRIBED AS FOLLOWS:

THAT PORTION OF LOT 1 IN SECTION 19, TOWNSHIP 18 SOUTH, RANGE 1 WEST. SAN BERNARDINO MERIDIAN, IN THE CITY OF CHULA VISTA, COUNTY OF SAN DIEGO, STATE OF CALIFORNIA ACCORDING TO OFFICIAL PLAT THEREOF, DESCRIBED AS

BEGINNING AT THE NORTHWEST CORNER OF SAID SECTION 19 THENCE SOUTH ALONG THE WEST LINE OF SAID SECTION, 812 FEET: THENCE EASTERLY AT RIGHT ANGLES TO SAID WEST LINE 515 FEET: THENCE SOUTHERLY PARALLEL WITH SAID WEST LINE 508 FEET; THENCE EASTERLY AT RIGHT ANGLES 13 FEET; THENCE NORTHERLY PARALLEL WITH THE WEST LINE OF SAID SECTION, 1320 FEET TO THE NORTH LINE OF SAID SECTION; THENCE WEST ALONG SAID NORTH LINE, 528 FEET TO THE POINT

**PROJECT SCOPE:** NEW 1-STORY WAREHOUSE BUILDING WITH TWO MEZZANINES

	TOTALING 178,156 SF			
TENANT OCCUPANCY:	WAREHOUSE (S-1)	173,432 SF		
LOT:			423,779 S.F.	9.72 (ACRES)
BUILDING AREA (FOOTPRINT	<u></u>		173,432	,
BUILDING COVERAGE:			41	%
FAR:			0.41	
LANDSCAPE AREA REQUIRE	D (15%):		63,567	S.F.
LANDSCAPE PROVIDED:——			63,978	S.F.
LANDSCAPE COVERAGE:—			15.1	%
TOTAL PARKING LOT AREA:-			44,461	S.F.
PARKING AREA LANDSCAPE	REQUIRED (10%):		4,446	S.F.
PARKING LANDSCAPE PROV	IDED:		<b>7,286</b>	S.F.
WAREHOUSE_168,926 S.F. /1	000		169	REQUIRED
OFFICE_4,506 S.F./300———			15	REQUIRED
MEZZANINE_4,724 S.F./300—			16	REQUIRED
TOTAL REQUIRED:			200	REQUIRED
TOTAL PROVIDED:			200	REQUIRED
STANDARD PARKING PROVI	DED:		192	STALLS
ACCESSIBLE PARKING REQU	JIRED:		6	STALLS
ACCESSIBLE PARKING PROV	/IDED:		6	STALLS
VAN ACCESSIBLE PARKING	PROVIDED:		1	STALLS
CLEAN AIR VEHICLE REQUIR	ED:		21	STALLS
EV CHARGING REQUIRED:—			18	STALLS
BICYCLE PARKING REQUIRE	D:		10	STALLS
BICYCLE LOCKERS REQUIRE	ED:		10	STALLS


# PROJECT DESCRIPTION

**VICINITY MAP** 

THIS PROJECT IS A NEW GROUND UP COMMERCIAL BUILDING (173,432 S.F.) ON CONCRETE SLAB WITH SHELL AND FUTURE FIRST FLOOR OFFICE AREA (4,506 S.F.) WITH MEZZANINE (4,724 S.F.) BUILD OUT, WAREHOUSE WITH LOADING DOCKS AND ROLL UP DOORS AND RAMPS, TRASH ENCLOSURE, LANDSCAPE AND ASSOCIATED SITE WORK, MECHANICAL, PLUMBING AND ELECTRICAL. INCLUDED IS A STAND-ALONE ELEVATOR TOWER PROVIDING ACCESS FROM STREET LEVEL TO BUILDING PAD

# SHINOHARA BUSINESS CENTER

517 SHINOHARA LANE CHULA VISTA, CALIFORNIA 91911

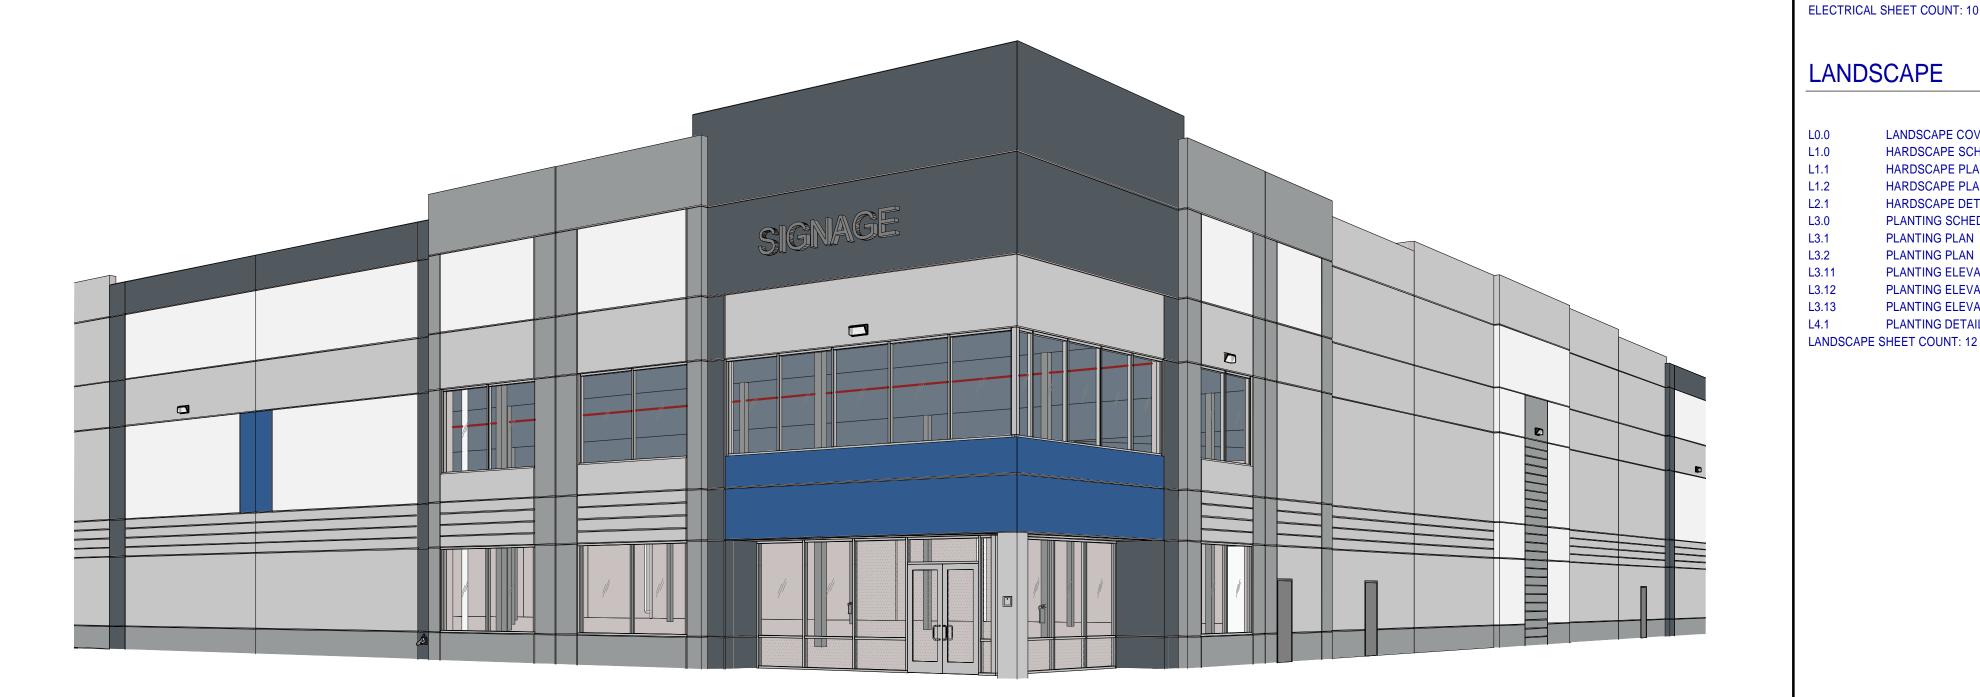

# **VWP-OP SHINOHARA OWNER, LLC**

GENERAL CONTRACTOR

2390 E. CAMELBACK RD. STE. 305 PHOENIX, AZ 85016

**ARCHITECT** 

**OWNER** 

858-378-4036

PROJECT SITE

NOT TO SCALE

Andrew Gracey 858-378-4036 andrew@onpointdev.vom

SOLANA BEACH, CA 92075

GEOCON, INCORPORATED

6960 FLANDERS DRIVE

SAN DIEGO, CA 92127

**CIVIL ENGINEER** 

535 N. HIGHWAY 101, SUITE A

PASCO LARET SUITER & ASSOCIATES

**ROD MIKESELL** PH: (858) 558-6900 x 220

mikesell@geoconinc.com

GREGORY W. LANG

PH: (858) 259-8212 x 103

glang@plsaengineering.com

# LANDSCAPE ARCHITECT

**GEOTECHNICAL ENGINEER** 

OWNER'S CONSULTANTS

RIDGE LANDSCAPE ARCHITECTS 8841 RESEARCH DRIVE, SUITE 200 **IRVINE, CA 92618** 

### SOO WAI-KIN PH: (949) 387-1323 x 33 soo@ridgela.com

STRUCTURAL ENGINEER

9915 MIRA MESA BLVD., SUITE 200 SAN DIEGO, CA 92131

2615 CAMINO DEL RIO SOUTH, SUITE 402 SAN DIEGO, CA 92108

MARINO DESIGN CONSULTING, INC. 2615 CAMINO DEL RIO SOUTH, SUITE 402 SAN DIEGO, CA 92108

### **ELECTRICAL ENGINEER**

MPE CONSULTING 10807 THORNMINT RD SAN DIEGO, CA 92127

dan@mpeconsulting.com

gerald@mdcmechanical.com

# SHEET INDEX

### **ARCHITECTURAL**

TITLE SHEET AD1.0 SITE PLAN AD1.1 WALL AND FENCE PLAN AD2.0 OVERALL FLOOR PLAN AD2.1 PARTIAL FLOOR PLAN AD2.2 PARTIAL FLOOR PLAN **OVERALL ROOF PLAN** AD3.1 PARTIAL ROOF PLAN AD3.2 PARTIAL ROOF PLAN **EXTERIOR ELEVATIONS** AD4.2 **EXTERIOR ELEVATIONS** AD4.3 **EXTERIOR ELEVATIONS** BUILDING SECTIONS **BUILDING SECTIONS** AD6.0 **ELEVATOR & TRASH ENCLOSURE PLANS** AD7.0 PERSPECTIVES

### **ELECTRICAL**

ARCHITECTURAL SHEET COUNT: 16

E001 NOTE SHEET E002 LIGHTING DETAIL SHEET E010 SITE UTILITY PLAN SITE LIGHTING PLAN E012 **PHOTOMETRICS** E101 LIGHTING PLAN E201 POWER PLAN E301 SINGLE LINE DIAGRAM E401 DETAIL SHEET E402 **DETAIL SHEET 2 ELECTRICAL SHEET COUNT: 10** 

### LANDSCAPE

LANDSCAPE COVER SHEET HARDSCAPE SCHEDULES AND NOTES HARDSCAPE PLAN HARDSCAPE PLAN HARDSCAPE DETAILS L3.0 PLANTING SCHEDULES AND NOTES PLANTING PLAN L3.2 PLANTING PLAN PLANTING ELEVATIONS - VERDURA WALLS PLANTING ELEVATIONS - VERDURA WALLS PLANTING ELEVATIONS - VERDURA WALLS PLANTING DETAILS

PA/PM: M.F.C. DRAWN BY.: JDC JOB NO.: SDG21-0056-00

**WARE MALCOMB** 3911 SORRENTO VALLEY BLVD, MARIA CABRERA

SUITE #120, SAN DIEGO, CA 92121 P 858.638.7277 F 858.638.7506

PH (858) 638-7277 EXT. 1314 mcabrera@waremalcomb.com JAIME DIAZ CASTRO PH: (858) 638-7277 EXT. 1367 EMAIL: jdiazcastro@waremalcomb.com

# WISEMAN + ROHY STRUCTURAL ENGINEERS

**MECHANICAL ENGINEER** 

# MARINO DESIGN CONSULTING, INC.

PLUMBING ENGINEER **GERALD MARINO** PH: (619) 550-2615 x 402

ARCHITECT'S CONSULTANTS

DAN MAYORGAS PH: (858) 673-4445

JIM WISEMAN


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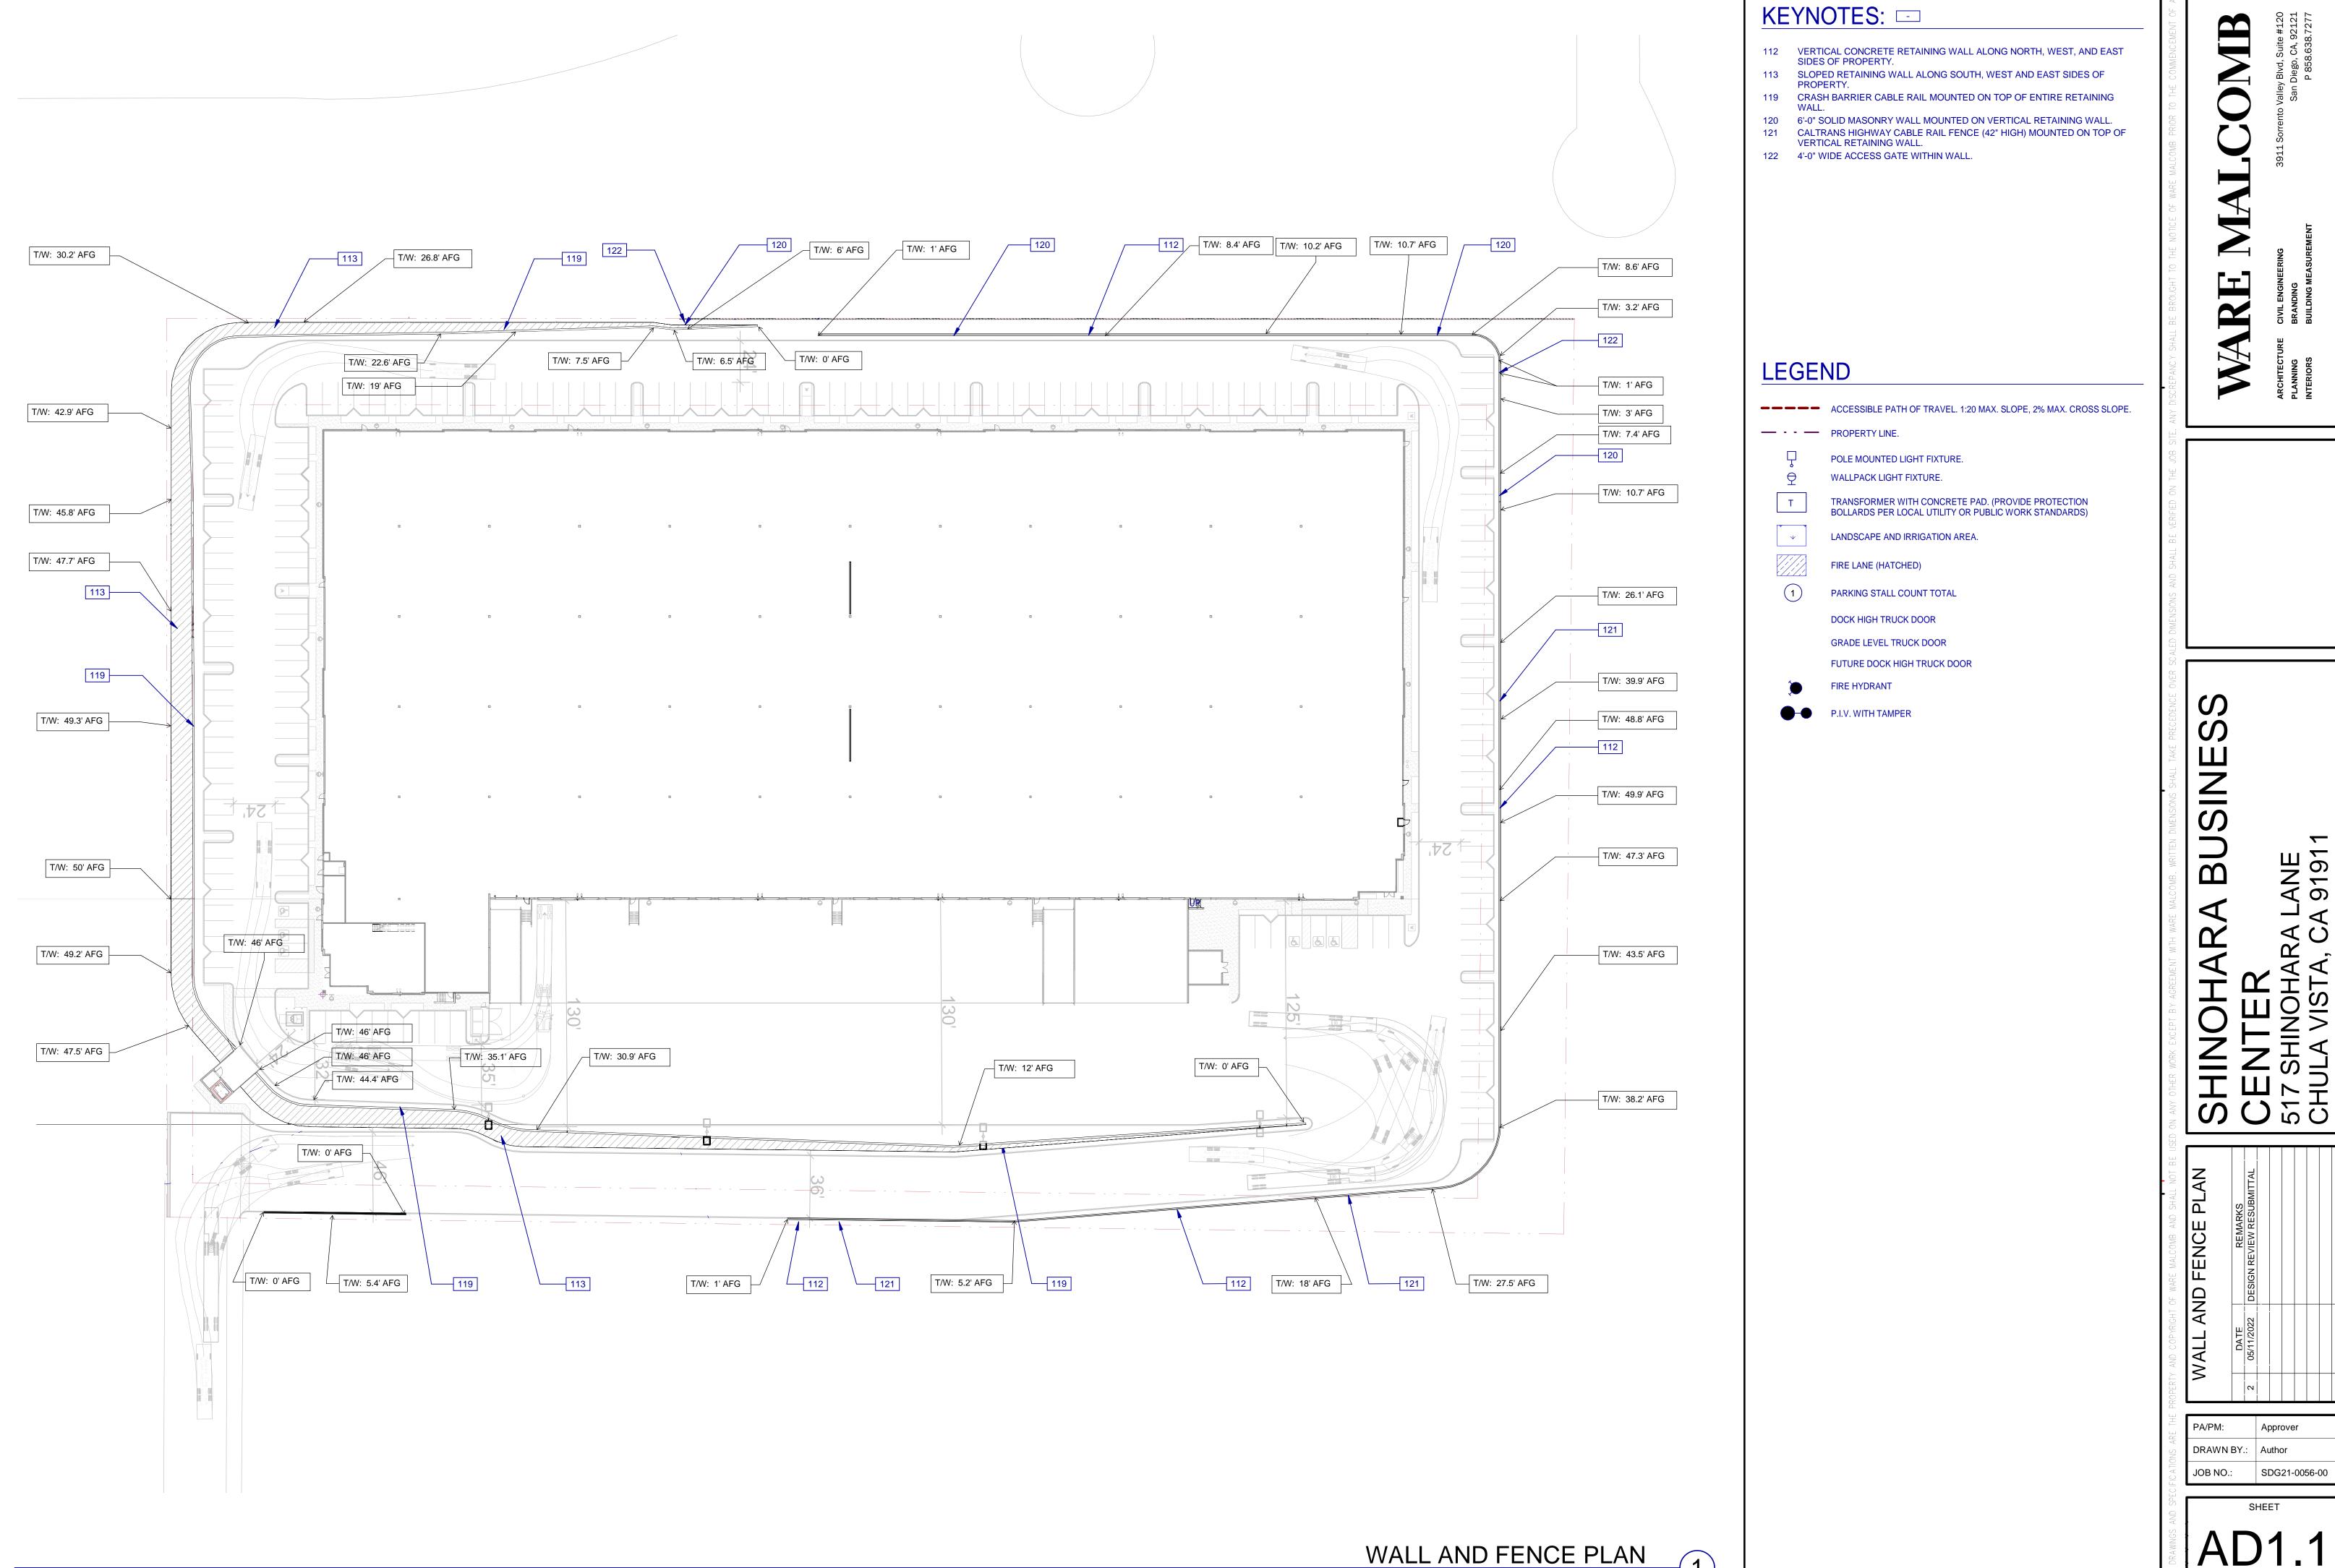
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PH: (858) 536-5166 x 314

jwiseman@wrengineers.com



AD1.0

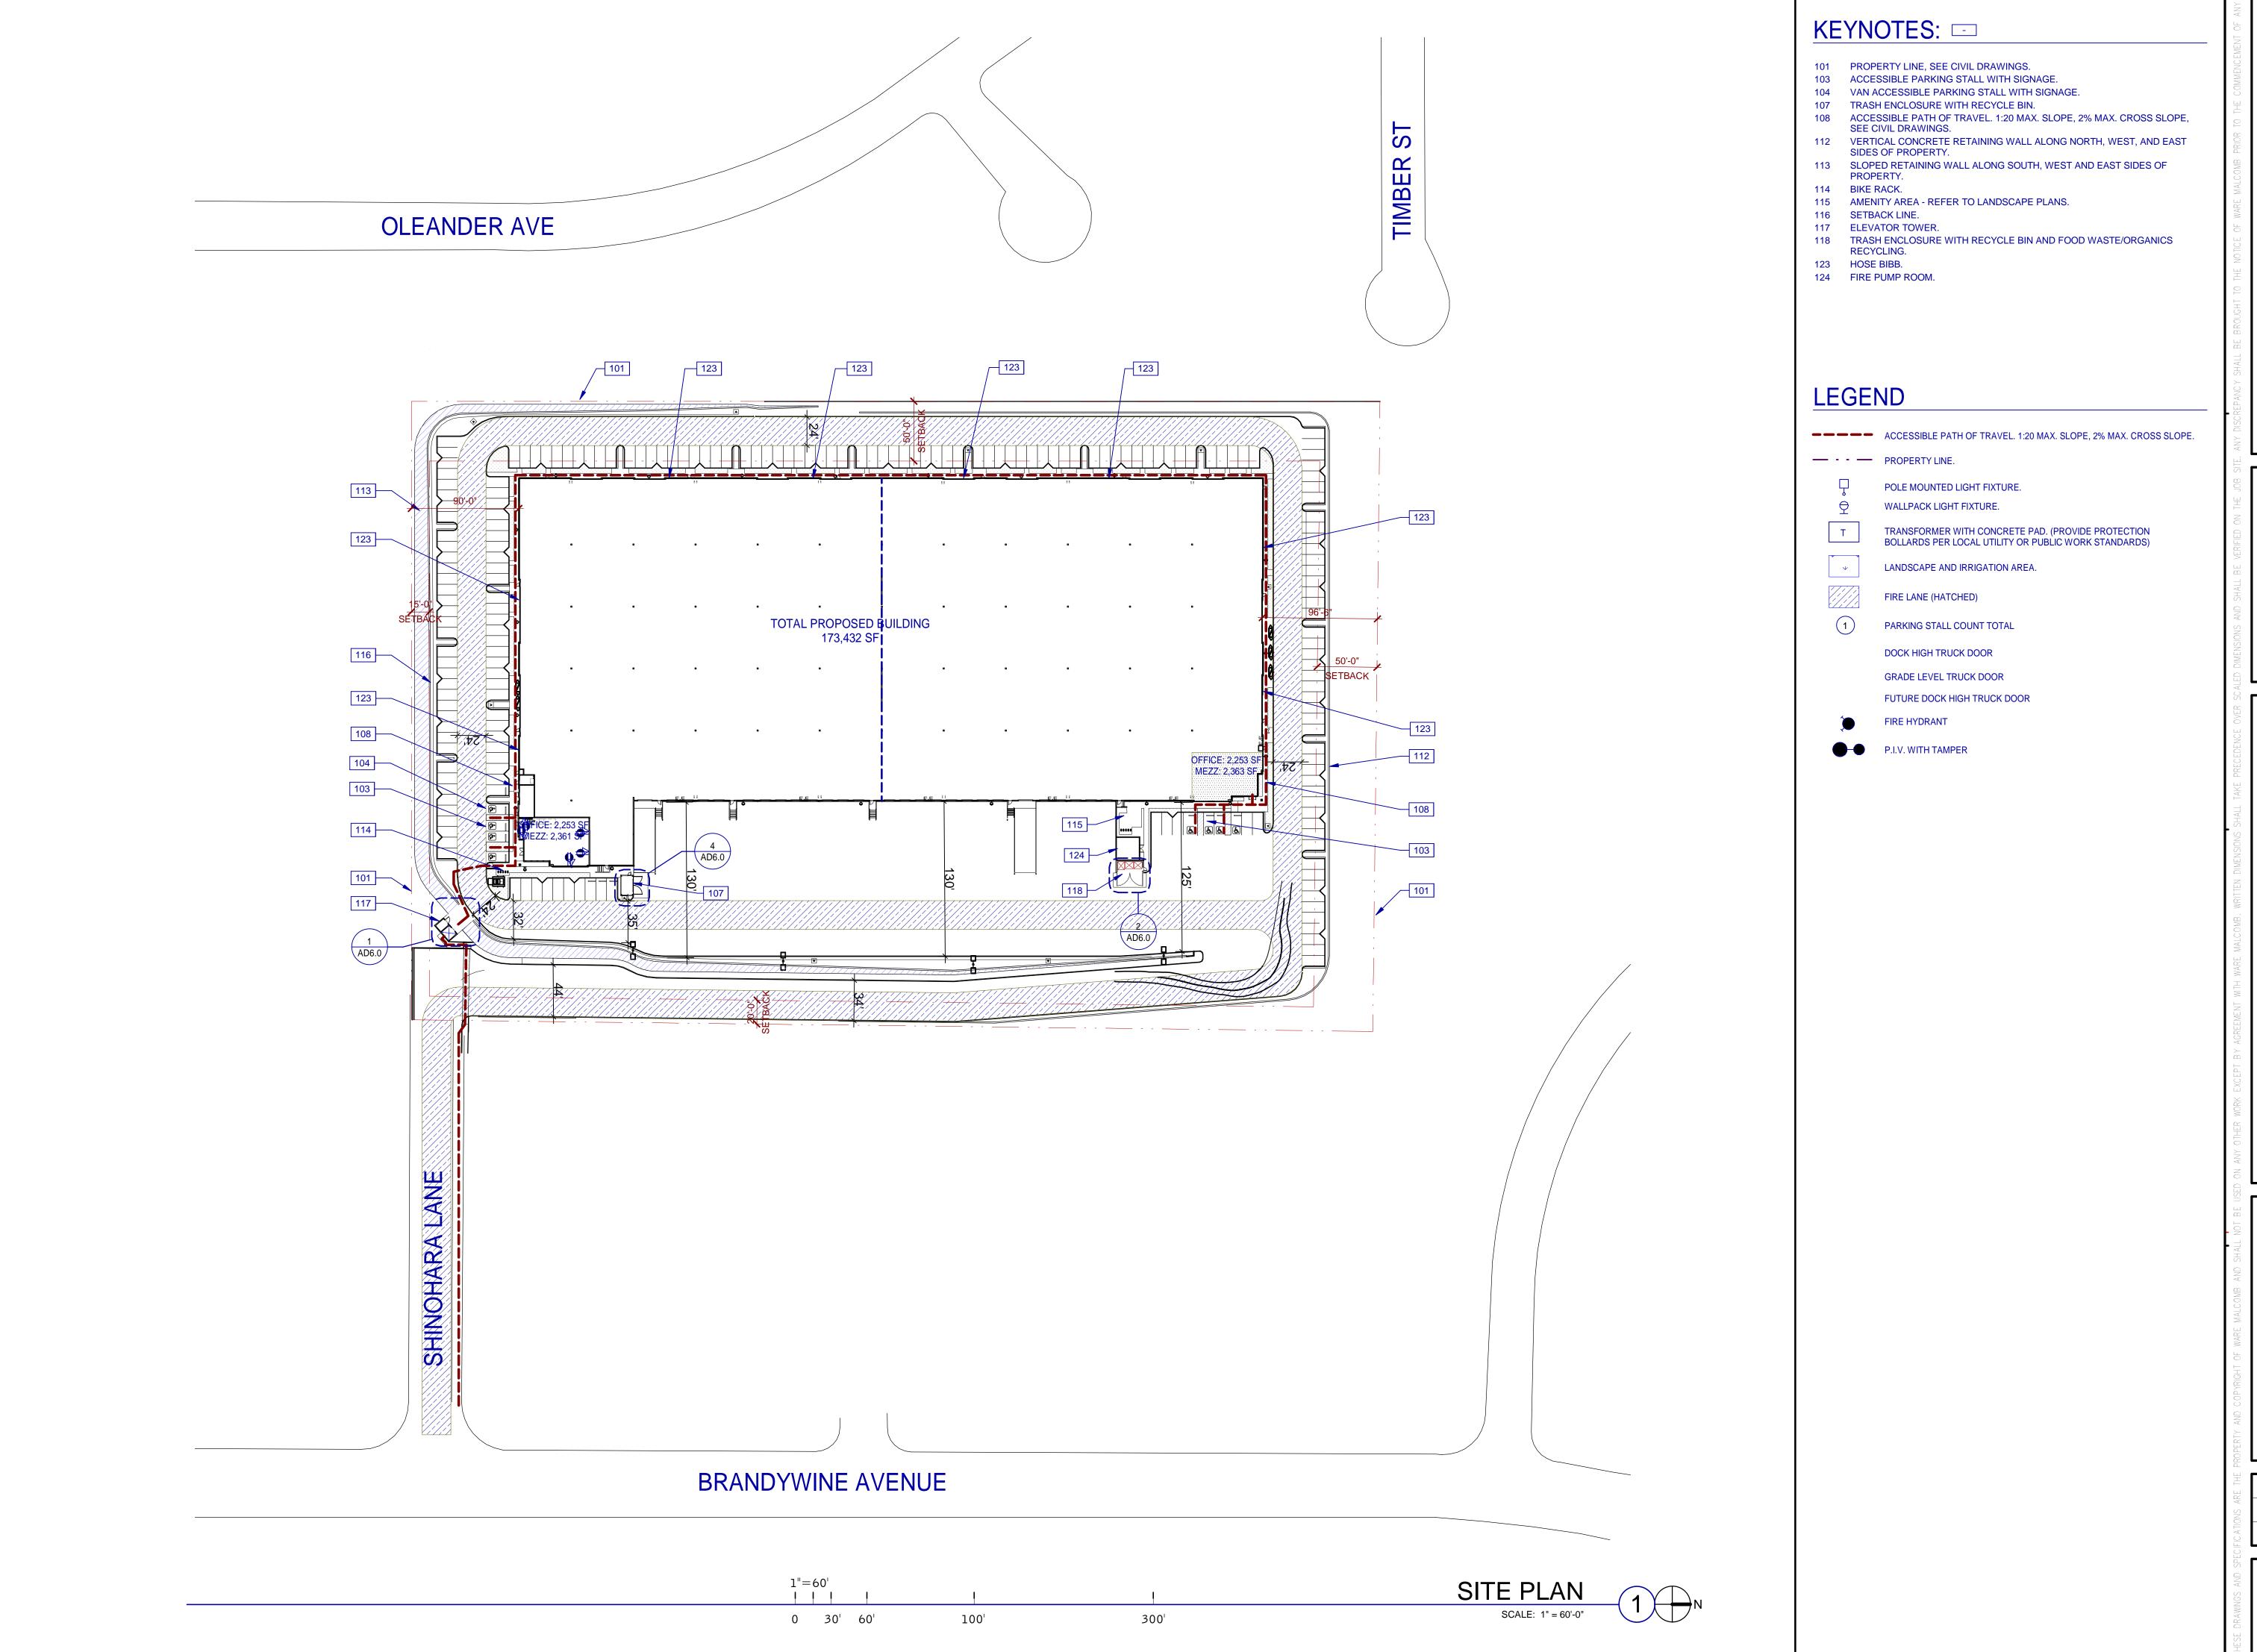

CAUTION: IF THIS SHEET IS NOT 24"x36" IT IS A REDUCED PRINT 52'-0" 52'-0" 52'-0" 52'-0" 52'-0" 59'-0" OFFICE AREA 52'-0" 52'-0" 52'-0" 59'-0" 44'-0" 52'-0" 52'-0" 52'-0" 52'-0" 52'-0" 52'-0" 52'-0" (10) (2) 4 (5)  $\left(6\right)$ (8) 9 (13) FLOOR PLAN 150' 0 15' 30' 60' WALL LEGEND LEGEND KEYNOTES: 🖃 SEE SHEET A0.2 FOR GENERAL NOTES SDG21-0056-00

CAUTION: IF THIS SHEET IS NOT 24"x36" IT IS A REDUCED PRINT KEYNOTES: = SEE SHEET A0.2 FOR GENERAL NOTES 201 STRUCTURAL COLUMN, TYP. 205 LINE OF BUILDING OVERHANG ABOVE. 206 ROOF DRAIN PIPE. 209 ALUMINUM STOREFRONT SYSTEM WITH 1" THICK INSULATED GLAZING UNITS. 44'-0" 52'-0" 52'-0" 52'-0" 52'-0" 52'-0" 211 9' x 10' SECTIONAL DOOR, PAINTED. 212 14' x 12' SECTIONAL DOOR. 18'-0" 26'-0" 26'-0" 26'-0" 26'-0" 26'-0" 26'-0" 26'-0" 26'-0" 26'-0" 26'-0" WALL LEGEND CONCRETE WALL INTERIOR NON-RATED PARTITION **LEGEND** PROPOSED FUTURE OFFICE AREA 59'-0" OFFICE AREA 52'-0" (2)(3)(4)(5) PARTIAL FLOOR PLAN - SOUTH 100' 0 10' 20'

SDG21-0056-00

52'-0" 52'-0" 52'-0" 52'-0" 52'-0" 59'-0" 26'-0" 26'-0" 26'-0" 26'-0" 26'-0" 26'-0" 26'-0" 26'-0" 26'-0" FUTURE OFFICE AREA

(11)

1"=20'

0 10' 20'

2'-6" 2'-6" 2'-6" 1'-3 1/2" 4'-0"

(13)

(12)

2'-6" | 9'-0" 3'-0" 9'-0" | 9'-0" 3'-0" 9'-0" | 9'-0" 9'-0" | 9'-0" 9'-0" | 9'-0" 9'-0" | 9'-0" 9'-0" | 9'-0" 9'-0" | 9'-0" 9'-0" | 9'-0" 9'-0" | 9'-0" 9'-0" | 9'-0" 9'-0" | 9'-0" 9'-0" | 9'-0" 9'-0" 9'-0" | 9'-0" 9'-0" | 9'-0" 9'-0" | 9'-0" 9'-0" | 9'-0" 9'-0" | 9'-0" 9'-0" | 9'-0" 9'-0" | 9'-0" 9'-0" | 9'-0" 9'-0" | 9'-0" 9'-0" | 9'-0" 9'-0" | 9'-0" 9'-0" | 9'-0" 9'-0" | 9'-0" 9'-0" | 9'-0" 9'-0" | 9'-0" 9'-0" | 9'-0" 9'-0" | 9'-0" 9'-0" | 9'-0" 9'-0" 9'-0" | 9'-0" 9'-0" 9'-0" | 9'-0" 9'-0" 9'-0" | 9'-0" 9'-0" 9'-0" | 9'-0" 9'-0" 9'-0" | 9'-0" 9'-0" 9'-0" | 9'-0" 9'-0" 9'-0" | 9'-0" 9'-0" 9'-0" | 9'-0" 9'-0" | 9'-0" 9'-0" | 9'-0" 9'-0" 9'-0" | 9'-0" 9'-0" | 9'-0" 9'-0" | 9'-0" 9'-0" | 9'-0" 9'-0" | 9'-0" 9'-0" | 9'-0" 9'-0" | 9'-0" 9'-0" | 9'-0" 9'-0" | 9'-0" 9'-0" | 9'-0" 9'-0" | 9'-0" 9'-0" | 9'-0" 9'-0" | 9'-0" 9'-0" | 9'-0" 9'-0" | 9'-0" | 9'-0" | 9'-0" | 9'-0" | 9'-0" | 9'-0" | 9'-0" | 9'-0" | 9'-0" | 9'-0" | 9'-0" | 9'-0" | 9'-0" | 9'-0" | 9'-0

52'-0"

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HTECTURE CIVIL ENGINEE INING BRANDING RIORS BUILDING MEA

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CENTER
517 SHINOHARA LANE
CHULA VISTA, CA 91911

PARTIAL ROOF PLAN

DATE


11/22/2021
DESIGN REVIEW SUBMITTAL

PA/PM: Approver

DRAWN BY.: Author

JOB NO.: SDG21-0056-00

SHEET AD3.1

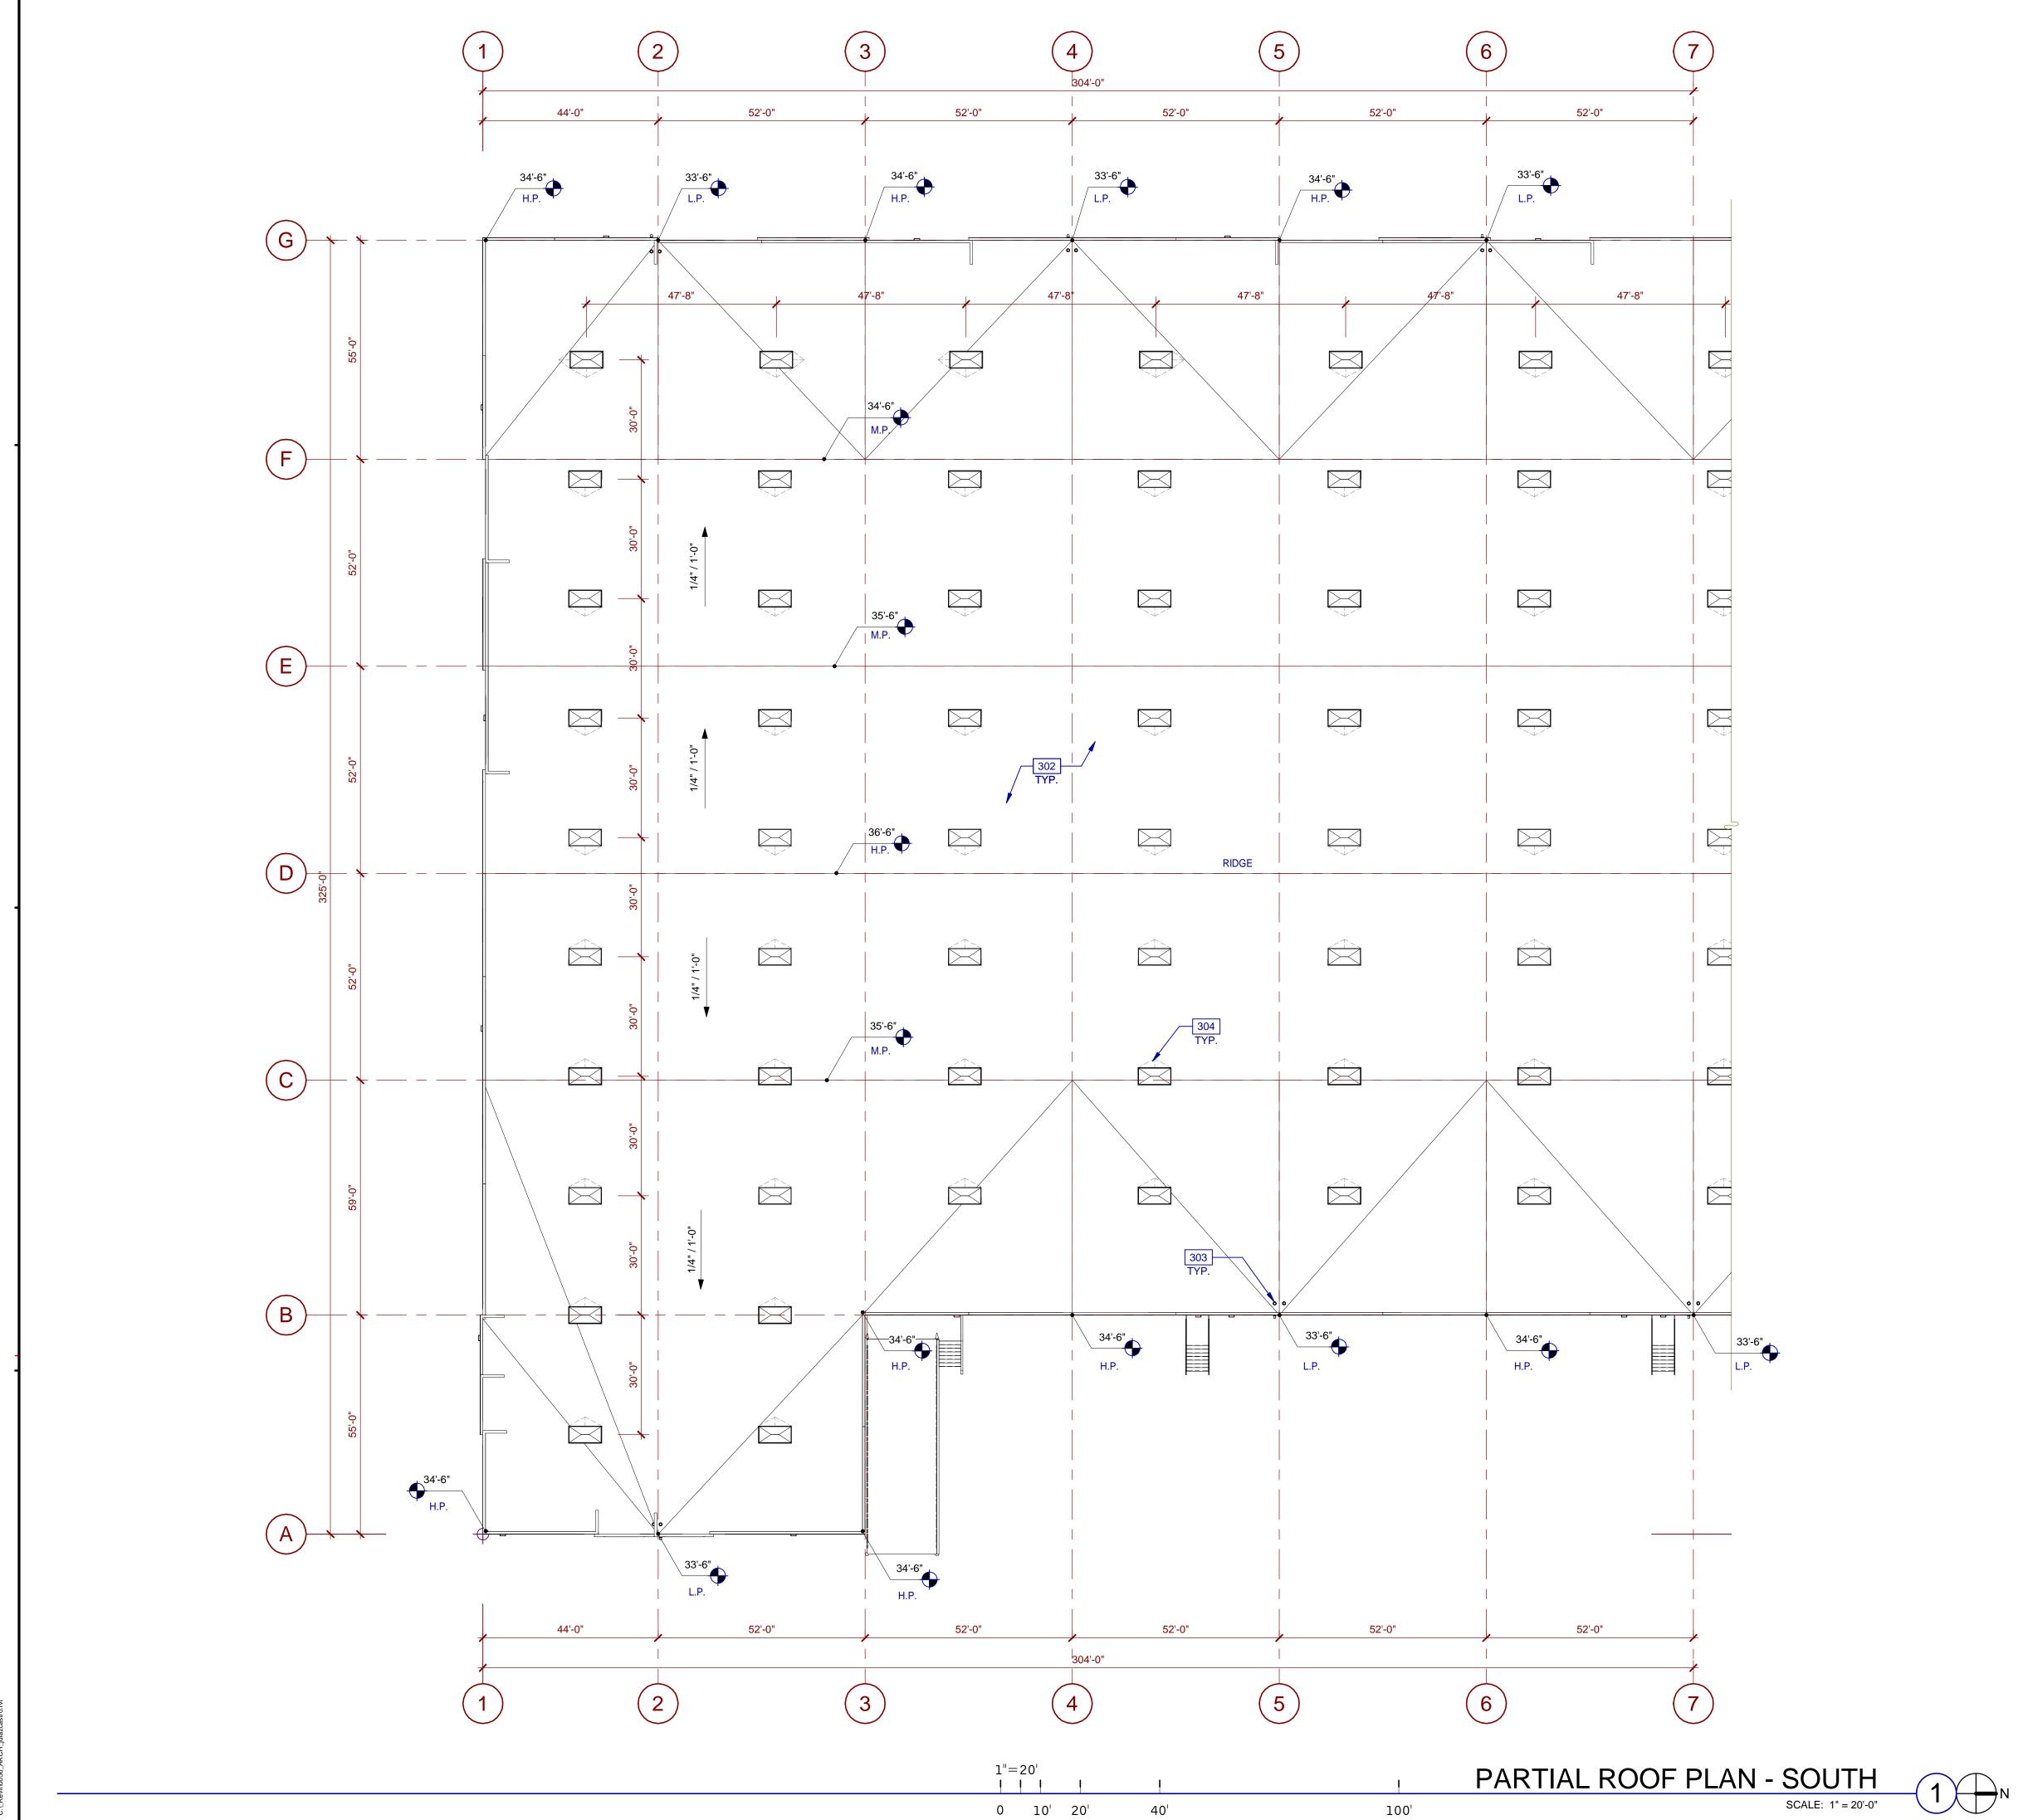

# **ABBREVIATIONS**

KEYNOTES: =

SEE SHEET A0.2 FOR GENERAL NOTES

303 ROOF DRAIN AND OVERFLOW DRAIN LOCATION.

302 BUILT-UP ROOFING.

304 CRICKET.

T.O.P. = TOP OF PARAPET
H.P. = TOP OF ROOFING - HIGH POINT
M.P. = TOP OF ROOFING - MID POINT
L.P.= TOP OF ROOFING - LOW POINT

# CALCULATIONS

### SKYLIGHTS:

SKYLIGHT SIZE: 48"x96"=32 S.F.

 $\frac{\text{(WAREHOUSE AREA S.F.)} \times 2.0\%}{\text{(SKYLIGHT SIZE)}} = \frac{170,918 \times .02}{32}$ 

DESIRED: 107 SKYLIGHTS PROVIDED: 108 SKYLIGHTS


### FUTURE SOLAR:

F	ROOF AREA:	173,461	S.F.
5	SKYLIGHT AREA:	3,456	S.F.
F	ROOF AREA LESS SKYLIGHT:	170,005	S.F.
1	5% OF ROOF AREA (LESS SKYLIGHTS):	25,501	S.F.
7	TOTAL AREA FOR FUTURE SOLAR REQUIRED:	25,501	S.F.*
7	TOTAL AREA FOR FUTURE SOLAR PROVIDED:	XXX,XXX	S.F.
	CEC SECTION 110.10(B)4 DOES NOT REQUIRE THE INCLUSION OF AFOR FUTURE SOLAR ENERGY SYSTEMS.	NY COLLAT	ERAL LOADS

# **LEGEND**

$\prec$

SKYLIGHT: (2%)
COORDINATE EXACT LOCATION TO PREVENT CONFLICT
WITH FRAMING, FIRE SPRINKLER LINES, ELECTRICAL
CONDUITS AND LIGHTING. SEE STRUCTURAL DRAWINGS.

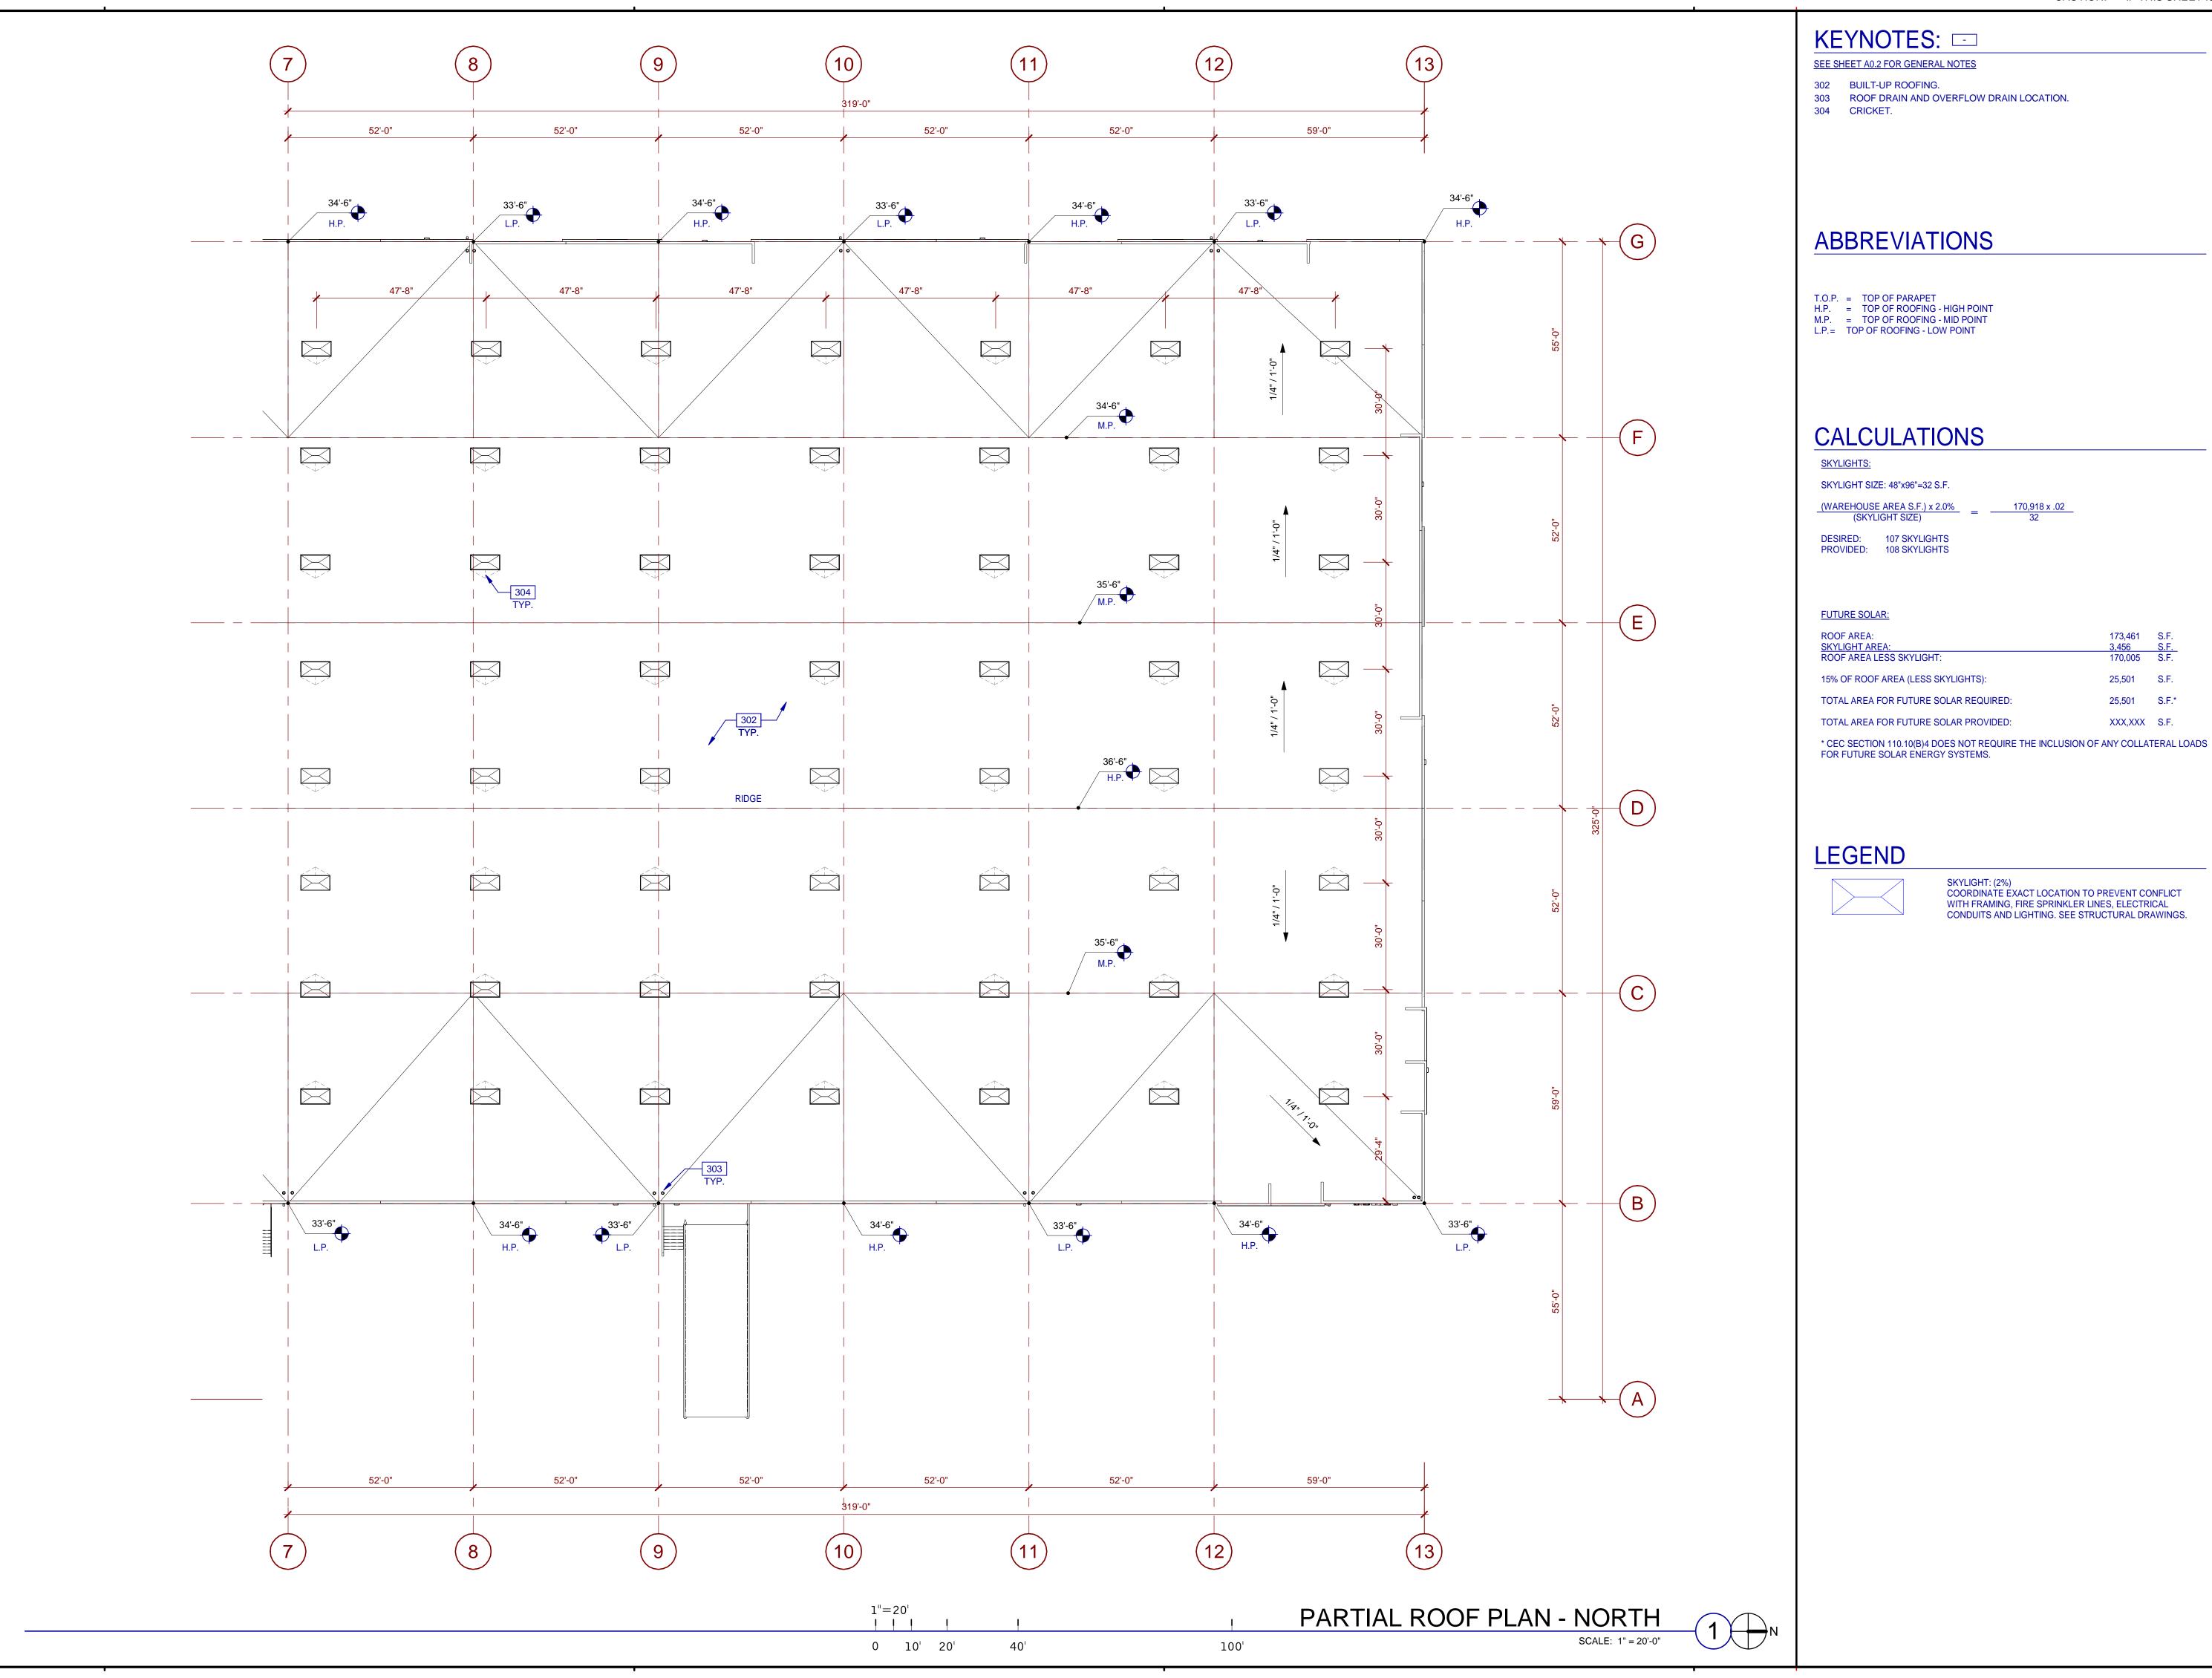

AD3.2


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CAUTION: IF THIS SHEET IS NOT 24"x36" IT IS A REDUCED PRINT  $\left(\mathsf{D}\right)$ T.O.P. 43'-0" 02 MEZZANINE 14'-0" 503 F.F.E. 0" 1/16"=1'-0" WEST-EAST BUILDING SECTION

SCALE: 1/16" = 1'-0" 0 8' 16' 32' 64' BUILDING SECTIONS LEGEND LEGEND KEYNOTES: = SEE SHEET A0.2 FOR GENERAL NOTES 503 CONCRETE SLAB. SEE STRUCTURAL DRAWINGS FOR ADDITIONAL INFORMATION.
504 CONCRETE PANEL. SEE STRUCTURAL DRAWINGS FOR ADDITIONAL INFORMATION. 517 ROOF DRAIN. SEE ROOF PLANS AND PLUMBING DRAWINGS FOR ADDITIONAL INFORMATION. DRAWN BY.: Author SDG21-0056-00

PA/PM: DRAWN BY.: Author SDG21-0056-00




AD7.0

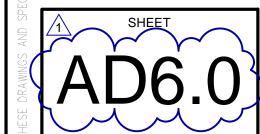NORTH-WEST PERSPECTIVE
SCALE:



SOUTH-EAST PERSPECTIVE
SCALE:

SOUTH-WEST PERSPECTIVE

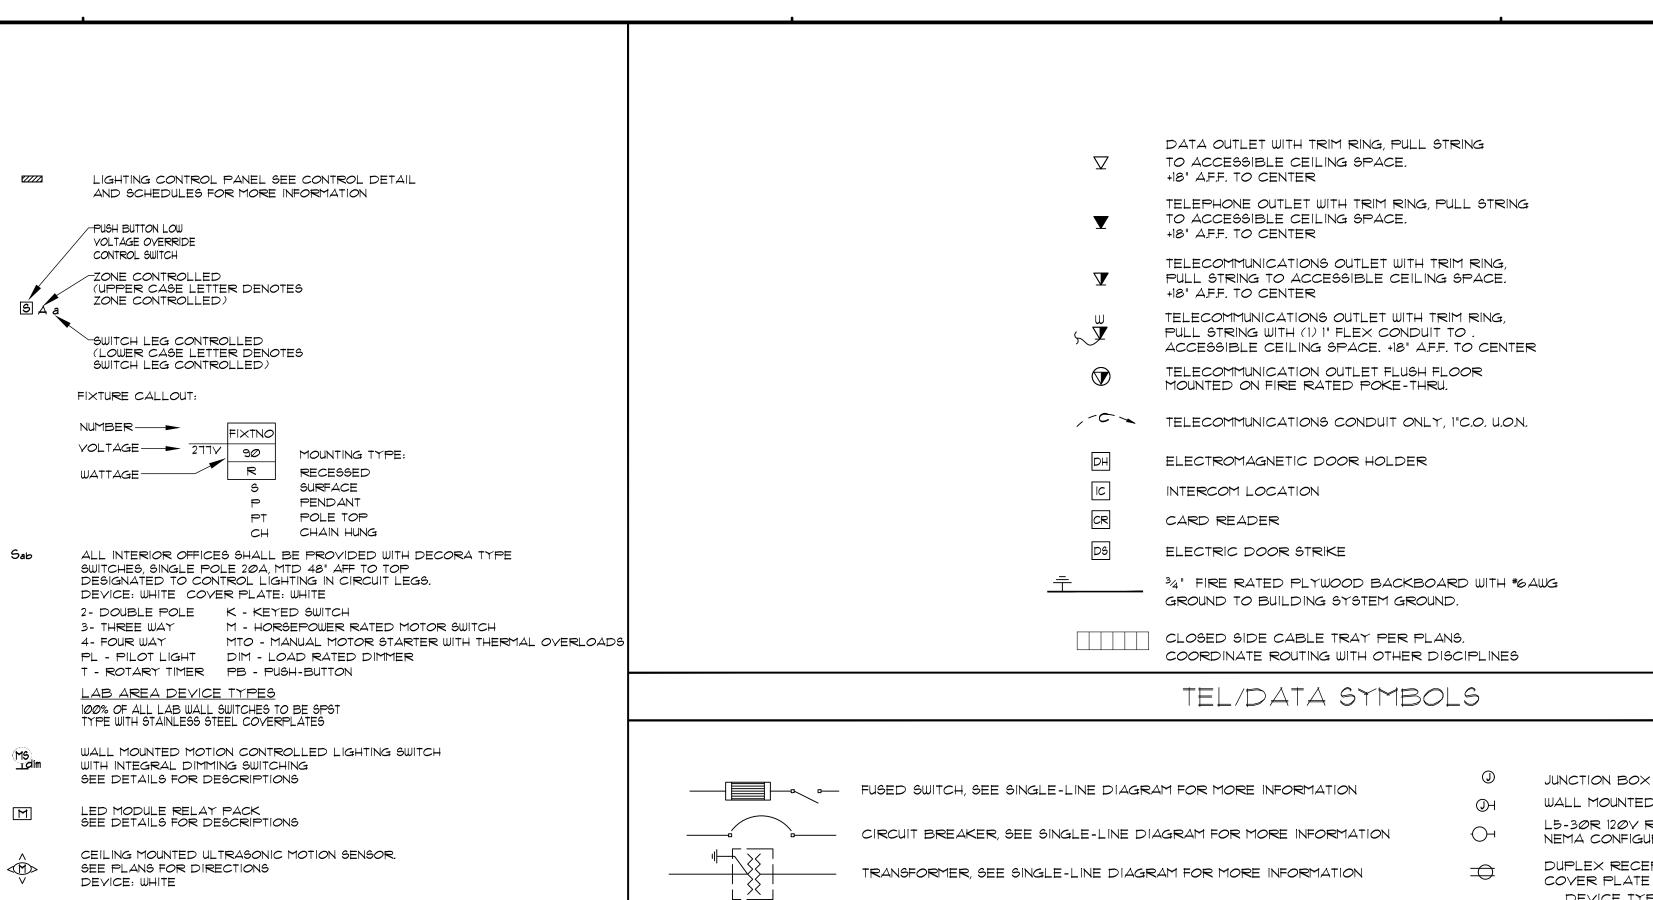

EXIT SIGN WITH 90 MINUTE BATTERY PACK. REFER TO FIXTURE SCHEDULE LOW LEVEL EXIT SIGN WITH 90MIN BATTERY PACK MTD 18" AFF TO CENTER. REFER TO FIXTURE SCHEDULE. EGRESS LIGHTING WITH 90 MINUTE BATTERY PACK. REFER TO FIXTURE SCHEDULE SEE LIGHTING FIXTURE SCHEDULE ON SHEET E1.3 FOR FIXTURE SYMBOL AND SPECIFICATIONS

### LIGHTING SYMBOLS

- ALL CONDUCTORS SHALL BE STRANDED COPPER FOR SIZES ABOVE #10AUG. CONDUCTORS #10AUG AND SMALLER SHALL BE SOLID. AC CABLE IS NOT ALLOWED AND SHALL NOT BE INSTALLED. AN EQUIPMENT GROUND CONDUCTOR SHALL BE INSTALLED IN ALL FLEXIBLE CONDUITS. ALL BRANCH CIRCUITS SHALL BE INSTALLED WITH A GREEN GROUND
- 2. ELECTRICAL CONTRACTOR TO REVIEW OTHER DISCIPLINE DRAWINGS AND INDICATE CONFLICTS OF CONDUIT ROUTING, UNDERGROUND COORDINATION AND CEILING HEIGHT CONFLICTS.
- 3. ELECTRICAL CONTRACTOR 6HALL BE RESPONSIBLE FOR PROTECTION OF EXISTING SPACES ADJACENT TO WORK DURING THE COURSE OF DEMOLITION AND NEW WORK. ALL REPAIRS OF DAMAGED AREAS ARE THE RESPONSIBILITY OF THE
- 4. ALL ELECTRICAL DEVICES, EQUIPMENT, AND LIGHT FIXTURES SHALL BE INSTALLED PER CALIFORNIA A.D.A. REQUIREMENTS
- ALL ELECTRICAL AND TEL/DATA CONDUIT AND RELATED FITTINGS SHALL BE CONCEALED. ANY LOCATIONS IN PUBLIC VIEW SHALL BE BROUGHT TO THE ATTENTION OF THE ELECTRICAL ENGINEER AND APPROVED PRIOR TO INSTALLATION. ALL CONDUIT RUNG SHOWN ARE DIAGRAMMATIC, COORDINATE ALL CONDUIT RUNG WITH OTHER DISCIPLINES.
- 6. ELECTRICAL WORK INSTALLED UNDER THIS PERMIT TO COMPLY WITH 2019 CALIFORNIA ELECTRICAL CODE, LOCAL AND STATE ENERGY STANDARDS AND ALL OTHER APPLICABLE CODES.
- 7. ELECTRICAL CONTRACTOR TO PROVIDE AND INSTALL WEATHERPROOF DEVICES, JUNCTION BOXES, FITTINGS, CONDUIT AND PULLBOXES AT ALL DAMP AND WET LOCATIONS.
- 8. ELECTRICAL CONTRACTOR SHALL COORDINATE REQUIRED ELECTRICAL SHUTDOWNS WITH OWNER 1 DAYS PRIOR TO SHUTDOWN. ALL SCHEDULED UTILITY SHUTDOWNS SHOULD BE SCHEDULED FOR AFTER HOURS WORK FOR OCCUPIED BUILDINGS, THE CONTINUITY OF POWER FOR AREAS OUTSIDE THE PERMITTED WORK SHALL BE MAINTAINED UNLESS A SHUTDOWN IS SCHEDULED.
- 9. ELECTRICAL CONTRACTOR SHALL VERIFY EXISTING SITE CONDITIONS PRIOR TO BID COMPLETION.
- 10. ELECTRICAL CONTRACTOR SHALL COORDINATE REQUIRED UTILITY METER APPLICATIONS AND ASSIST OWNER FOR PROPER METER RELEASE SCHEDULE.
- 11. ELECTRICAL CONTRACTOR TO PROVIDE AND INSTALL REQUIRED MATERIALS FOR JOB COMPLETION. ELECTRICAL CONTRACTOR SHALL COORDINATE PROCUREMENT OF LONG LEAD ITEMS, AND COORDINATE STORAGE OF MATERIALS TO AVOID DAMAGE PRIOR TO INSTALLATION.
- 12. ALL EMPTY CONDUITS ARE TO BE PROVIDED WITH PULL ROPES. LABEL EACH END OF CONDUIT TO INDICATE EXACT DESTINATION.
- 13. ELECTRICAL PANELS SHALL NOT BE LOCATED WITHIN FIRE-RATED CORRIDORS.
- 14. ALL MATERIALS USED UNDER THIS PERMIT SHALL BE NEW AND BEAR THE APPROPRIATE UL LABEL. USED OR RE-CONDITIONED MATERIALS ARE PROHIBITED.
- 15. ALL PERMANENTLY INSTALLED EQUIPMENT SHALL BEAR A UL LABEL OR NATIONALLY RECOGNIZED TESTING AGENCY CERTIFICATION.
- 16. PROVIDE AND INSTALL CLEAR ADHESIVE LABELS INDICATING PANEL AND CIRCUIT NUMBER ON ALL OUTLETS AND SWITCHES, LETTER HEIGHT TO BE 1/4"
- 17. ALL SYSTEMS FURNITURE CIRCUITS AND HOMERUNS TO BE PROVIDED WITH DEDICATED NEUTRAL CONDUCTORS PER CIRCUITS.
- 18. ALL MULTIWIRE BRANCH CIRCUITS SHALL BE INSTALLED WITH AN IDENTIFIED HANDLE TIE OR A 2-POLE/3-POLE CIRCUIT

BREAKER PROVIDES THE REQUIRED SIMULTANEOUS OPENING OF THE UNGROUNDED CONDUCTORS PER NEC 240.10 (B)

19. ALL OUTLET DEVICES TO HAVE CLEAR ADHESIVE LABEL INDICATING PANEL AND CIRCUIT NUMBER ON INSIDE OF BOX AND OUTSIDE OF COVERPLATE.

GENERAL NOTES

-	- FUSED SWITCH, SEE SINGLE-LINE DIAGRAM FOR MORE INFORMATION		
		$\mathbb{O}_{H}$	WALL MOUNTED JUNCTION BOX
	CIRCUIT BREAKER, SEE SINGLE-LINE DIAGRAM FOR MORE INFORMATION	$\bigcirc$	L5-30R 120V RECEPTACLE NEMA CONFIGURATION AS NEEDED
1	TRANSFORMER, SEE SINGLE-LINE DIAGRAM FOR MORE INFORMATION	$\Rightarrow$	DUPLEX RECEPTACLE MTD 18" AFF TO CENTER COVER PLATE COLOR: WHITE  DEVICE TYPE  DEVICE COLOR
	SHIELDED TRANSFORMER, SEE SINGLE-LINE DIAGRAM FOR MORE INFORMATION		STANDARD WHITE  IG ISOLATED GROUND ORANGE WITH TRIANGLE IDENTIFICA  D DEDICATED 200A RATED 5-20R GRAY  CEL 200A CEL DATED
	CURRENT TRANSFORMER		GFI 20A GFI RATED WHITE UPS 15A OR 20A UPS GRAY EG EMERGENCY RED
•36	POTENTIAL TRANSFORMER		TVSS 80-150 JOULE TVSS BLUE  LAB AREA DEVICE TYPES  100% OF ALL LAB RECEPTACLES TO BE 20A
<b>→&gt;</b>	DRAW OUT DEVICE	1-1	RATED 5-20R WITH STAINLESS STEEL COVERPLATES
●E N	AUTOMATIC TRANSFER SWITCH- OPEN TRANSITION WITH IN-PHASE MONITOR.	<b>#</b>	DOUBLE DUPLEX RECEPTACLE MTD 18" AFF TO CENTER SCHEDULE AS NOTED ABOVE
O PL	PANELBOARD	$\Rightarrow$	SPLIT WIRED 15A $1/2$ HOT, $1/2$ SWITCHED OUTLET COLOR: WHITE
NEW	LOAD NOMENCLATURE: L - LIGHTING H - HOUSE		SURFACE MOUNTED DUPLEX RECEPTACLE PROVIDE CAST BOX AND STAINLESS STEEL COVER PLATE
PANEL L1	OP - OFFICE POWER  M - MECHANICAL  MP - MECHANICAL (2087)		SURFACE MOUNTED DOUBLE DUPLEX RECEPTACLE PROVIDE CAST BOX AND STAINLESS STEEL COVER PLATE
	LP - LAB POWER CP - COMPUTER ROOM	$\Rightarrow$	208V/I+ RECEPTACLE NEMA CONFIGURATION AS NOTED
- 0	K - KITCHEN NUMBER INDICATES FLOOR LEVEL	$\Rightarrow \Diamond$	208V/30 RECEPTACLE NEMA CONFIGURATION AS NOTED
(M)	METER M - UTILITY METER VM - VOLT METER		SURFACE MOUNTED 208V/30 RECEPTACLE NEMA CONFIGURATION AS NOTED
	AM - AMMETER VAR - VARMETER	<b>₽7</b>	FLOOR BOX WITH DOUBLE DUPLEX RECEPTACLE AND SINGLE GANG TEL/DATA RECEPTACLE
	WM - WATTMETER WHM - WATTHOUR METER WDM - WATTHOUR DEMAND METER	$\bigcirc \mathbf{\Lambda}$	FLOOR BOX WITH DUPLEX RECEPTACLE AND SINGLE GANG TEL/DATA RECEPTACLE
GF)	GROUND FAULT CIRCUIT INTERRUPTER	$\mathbb{Q}$	SPECIALTY FLOOR BOX PER PLANS MULTIPLE GANG BOX. SEE SPECS
ÐΔ	DOUBLE LUG		POKE THROUGH BOX WITH DOUBLE DUPLEX RECEPTACLE AND SINGLE GANG TEL/DATA RECEPTACLE
59	SOLID STATE DEVICE	$\bigcirc$	POKE THROUGH BOX WITH DUPLEX RECEPTACLE AND SINGLE GANG TEL/DATA RECEPTACLE
FT R	FEED THROUGH PANELBOARD  HEAVY DUTY SPST OR DPST RELAY (SIEMENS 'PRD' SERIES OR EQUAL) IN NEMA 1 OR NEMA 3R ENCLOSURE	<b>QY</b>	SPECIALTY POKE THROUGH BOX PER PLANS MULTIPLE GANG BOX. SEE SPECS
	WITH 120Y CONTACT COIL.	<b>#</b>	PEDESTAL MOUNTED DOUBLE DUPLEX RECEPTACLE MANUF: HUBBELL #546688 W/STAINLESS STEEL COVER PLATES
ST	SHUNT TRIP DEVICE	<del>O</del> p	PEDESTAL MOUNTED DUPLEX RECEPTACLE MANUF: HUBBELL #546686 W/STAINLESS STEEL COVER PLATES
$\sim$	PROVIDE LIQUID TIGHT FINAL CONNECTION TO EQUIPMENT	$\Rightarrow$	ROOF MOUNTED WEATHERPROOF, GFI WORK OUTLET PROVIDE CAST BOX W/STAINLESS STEEL WP COVER
	RACEWAY OR WIREWAY ASSEMBLY DOWN RACEWAY OR WIREWAY ASSEMBLY UP	ď	EXTERNALLY OPERATED FUSED DISCONNECT SWITCH PROVIDE PER NEMA RATING REQUIRED
_	HOMERUN TO PANEL, CIRCUITS AS INDICATED	Ø	COMBINATION FYNR MAGNETIC MOTOR STARTER AND DISCONNECT RATING AND POLES AS INDICATED. PROVIDE WITH OVERLOAD
/ u	NDERGROUND HOMERUN TO PANEL, CIRCUITS		PER HORSEPOWER REQUIREMENTS, CPT, H.O.A. WITH PILOT LIGHTS PROVIDE WITH (1) EACH N.O., AND N.C. AUX CONTACTS
	46 INDICATED CONCEALED EMT CONDUIT WITH THWN/THHN WIRE #12AWG, ½"C MINIMUM.		FVNR MAGNETIC STARTER WITH OVERLOAD PER HORSEPOWER REQUIREMENTS, CPT, H.O.A. WITH PILOT LIGHTS PROVIDE WITH (1) EACH N.O., AND N.C. AUX CONTACTS
,,,,	CONCEALED EMT CONDUIT WITH THWN/THHN WIRE #12AWG, ½ "C MINIMUM.	O PP	DUÁL CHASE POWER POLE
#\Ø ///	CONCEALED EMT CONDUIT WITH THWN/THHN WIRE	VFD	VARIABLE FREQUENCY DRIVE(PROVIDED BY OTHERS)
	SHOAWG, 34"C MINIMUM.		HIALL MOUNTED HTH ITY METER AND REPURCE DISCONNECT
#IØN ////	CONCEALED EMT CONDUIT WITH THW WIRE		WALL MOUNTED UTILITY METER AND SERVICE DISCONNECT
	3)#12AUG (1)#10AUG NEUTRAL 3/4"C MINIMUM		FLUSH MOUNTED PANELBOARD

SURFACE MOUNTED PANELBOARD

FLUSH MOUNTED LIGHTING DIMMING PANEL, U.O.N.

SEE DETAILS FOR MORE INFORMATION

SEE DETAILS FOR MORE INFORMATION

SURFACE MOUNTED LIGHTING CONTROL PANEL, U.O.N.

FIRE RATED SYSTEMS FURNITURE FEED POKE THROUGH

FIRE RATED DOUBLE DUPLEX POKE THROUGH

AMPERES INCAND INCANDESCENT ALTERNATING CURRENT INVERTER INY. AMPERES INTERRUPTING CAPACITY JUNCTION BOX J-BOX ABOVE FINISHED FLOOR KNEE SPACE **AFG** ABOVE FINISHED GRADE KVAKILO-VOLTAMPERE AMP FRAME/AMP FUSE KILO-WATT  $\ltimes$ W ALUMINUM KILO-WATT-HOUR ARCHITECT OR ARCHITECTURAL ARCH POUNDS AMP SWITCH  $\mathcal{A}\mathcal{S}$ LINEAL FEET AMP TRIP LIGHTING LTG AUTOMATIC TRANSFER SWITCH LOW VOLTAGE AUXILIARY MANUF MANUFACTURER AMERICAN WIRE GAUGE MAXMAXIMUMBKBD BACKBOARD MCB MAIN CIRCUIT BREAKER CONDUIT WITH WIRE MECHANICAL CONTRACTOR CABLE TELEVISION MOTOR CONTROL CENTER CLOSED CIRCUIT TELEVISION MCP MOTOR CIRCUIT PROTECTION CIRCUIT BREAKER MECH MECHANICAL CURRENT LIMITING FUSE MIN MINIMUM CONDUIT ONLY WITH NYLON PULL CORD METAL HALIDE CONTR CONTRACTOR MLOMAIN LUGS ONLY CONTROL POWER TRANSFORMER MTG MOUNTING COPPER MERCURY VAPOR CURRENT TRANSFORMER NEUTRAL CWCOLD WATER NORMALLY CLOSED DEDICATED OUTLET NATIONAL ELECTRIC CODE DIRECT CURRENT NIC NOT IN CONTRACT DIA DIAMETER NIGHT LIGHT DISCONNECT NOT TO SCALE DISTRIBUTION NORMALLY OPEN DWGS DRAWINGS ON CENTER EΑ OWNER FURNISHED CONTRACTOR INSTALLED 90-MINUTE BATTERY CONNECTED TO UNIT OWNER FURNISHED OWNER INSTALLED ELECTRICAL CONTRACTOR PEDESTAL MOUNT ED 'IOTA' LED EMERGENCY DRIVER (IF AC PULL BOX DRIVER IS EXTERNAL) OR 'IOTA' MICRO PC INVERTER (IF DRIVER IS INTERNAL TO FIXTURE) PCTC PHOTOCELL CONTROL PHOTOCELL/TIMECLOCK CONTROL QUANTITY OF MICRO INVERTERS PER INVERTER PE POWER FACTOR DIVIDED BY FIXTURE WATTAGE PHASE PROVIDE ADDITIONAL VOLTAGE SENSING POST INDICATING VALVE CIRCUIT FOR SWITCHED FIXTURES PILOT LIGHT EMERGENCY GENERATOR CONNECTION POLYVINYL CHLORIDE EMERGENCY GENERATOR AND 90-MINUTE POWER BATTERY BACKUP POWER POLE EXHAUST FAN POTENTIAL TRANSFORMER ELECT ELECTRICAL QR FIXTURE WITH QUARTZ RESTRIKE ELEVATION/ELEVATOR QTY QUANTITY ELECTRO-METALIC TUBING RECEPT RECEPTACLE EXISTING REFER REFRIGERATOR EXO EXTERNALLY OPERATED CIRCUIT BREAKER RIGID GALVANIZED STEEL FIRE ALARM SD SMOKE DETECTOR FOOT CANDLE SPECIFICATION FURNITURE FEED ANGLE IDENTIFICATION FF SQ FT SQUARE FEET OR SQUARE FOOT FIXT FIXTURE SWITCH FLUOR FLUORESCENT SWBD SWITCHBOARD FEET OR FOOT SWGR SWITCHGEAR FULL YOLTAGE NON-REVERSING TEMPERATURE OR TEMPORARY TEMP GROUND BUS OR WIRE TELEVISION GALY GALYANIZED TEL, TELETELEPHONE GENERAL CONTRACTOR TIME CLOCK GARBAGE DISPOSAL TWIST LOCK GEN GENERATOR TRANSF TRANSFORMER GFCI GROUND FAULT CURRENT INTERRUPTER TVSS TRANSIENT VOLTAGE SURGE SUPPRESSION GFR GROUND FAULT RELAY TYP TYPICAL GREEN GROUND WIRE UNDERGROUND PULL SECTION GRD GROUND UNDERWRITERS LABORATORIES HORIZONTAL UNLESS NOTED OTHERWISE HIGH INTENSITY DISCHARGE UNINTERRUPTIBLE POWER SUPPLY HAND-OFF-AUTOMATIC HOA VOLTS HORSEPOWER VOLT-AMPERE HIGH PRESSURE SODIUM VFD VARIABLE FREQUENCY DRIVE HR HEIGHT WATER HEATER HOUR WEATHER PROOF DEVICE OR COVER HVHIGH VOLTAGE EXISTING ĦZ HERTZ TRANSFORMER ISOLATED GROUND BUS OR WIRE EXISTING TO BE RELOCATED INTERMEDIATE METAL CONDUIT NEW LOCATION OF RELOCATED FIXTURE OR DEVICE EXISTING TO BE REMOVED

### ABBREVIATIONS

Sheet	t List Table			
Sheet Number	Sheet Title			
E001	NOTE SHEET			
E002	LIGHTING DETAIL SHEET			
E011	SITE LIGHTING PLAN			
E100	PHOTOMETRICS			

SHEET INDEX



11 SHINOHARA CHULA VISTA, C

ANE 9191

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PA/PM: Approver DRAWN BY .: Author JOB NO.: SDG21-0056-00

SHEET

NOTE SHEET

(3)#12AWG, (1)#10AWG NEUTRAL 3/4 "C MINIMUM.

STUBBED CONDUIT WITH PLASTIC BUSHING

SEAL FITTING INSTALLED PER PLANS

PULL BOX SIZED PER NEC CODE

MOTOR (PROVIDED BY OTHERS)

--- - UNDERGROUND CAPPED CONDUIT

POWER SYMBOLS



ANE 9191 17 SHINOHARA HULA VISTA, C

PA/PM: Approver DRAWN BY .:

mpe

consulting

10807 Thornmint Road Ste. 200

San Diego, CA 92127 p: 858.673.4445


www.mpeconsulting.com

E018377

Exp. 6-30-28

JOB NO.: SDG21-0056-00

SHEET

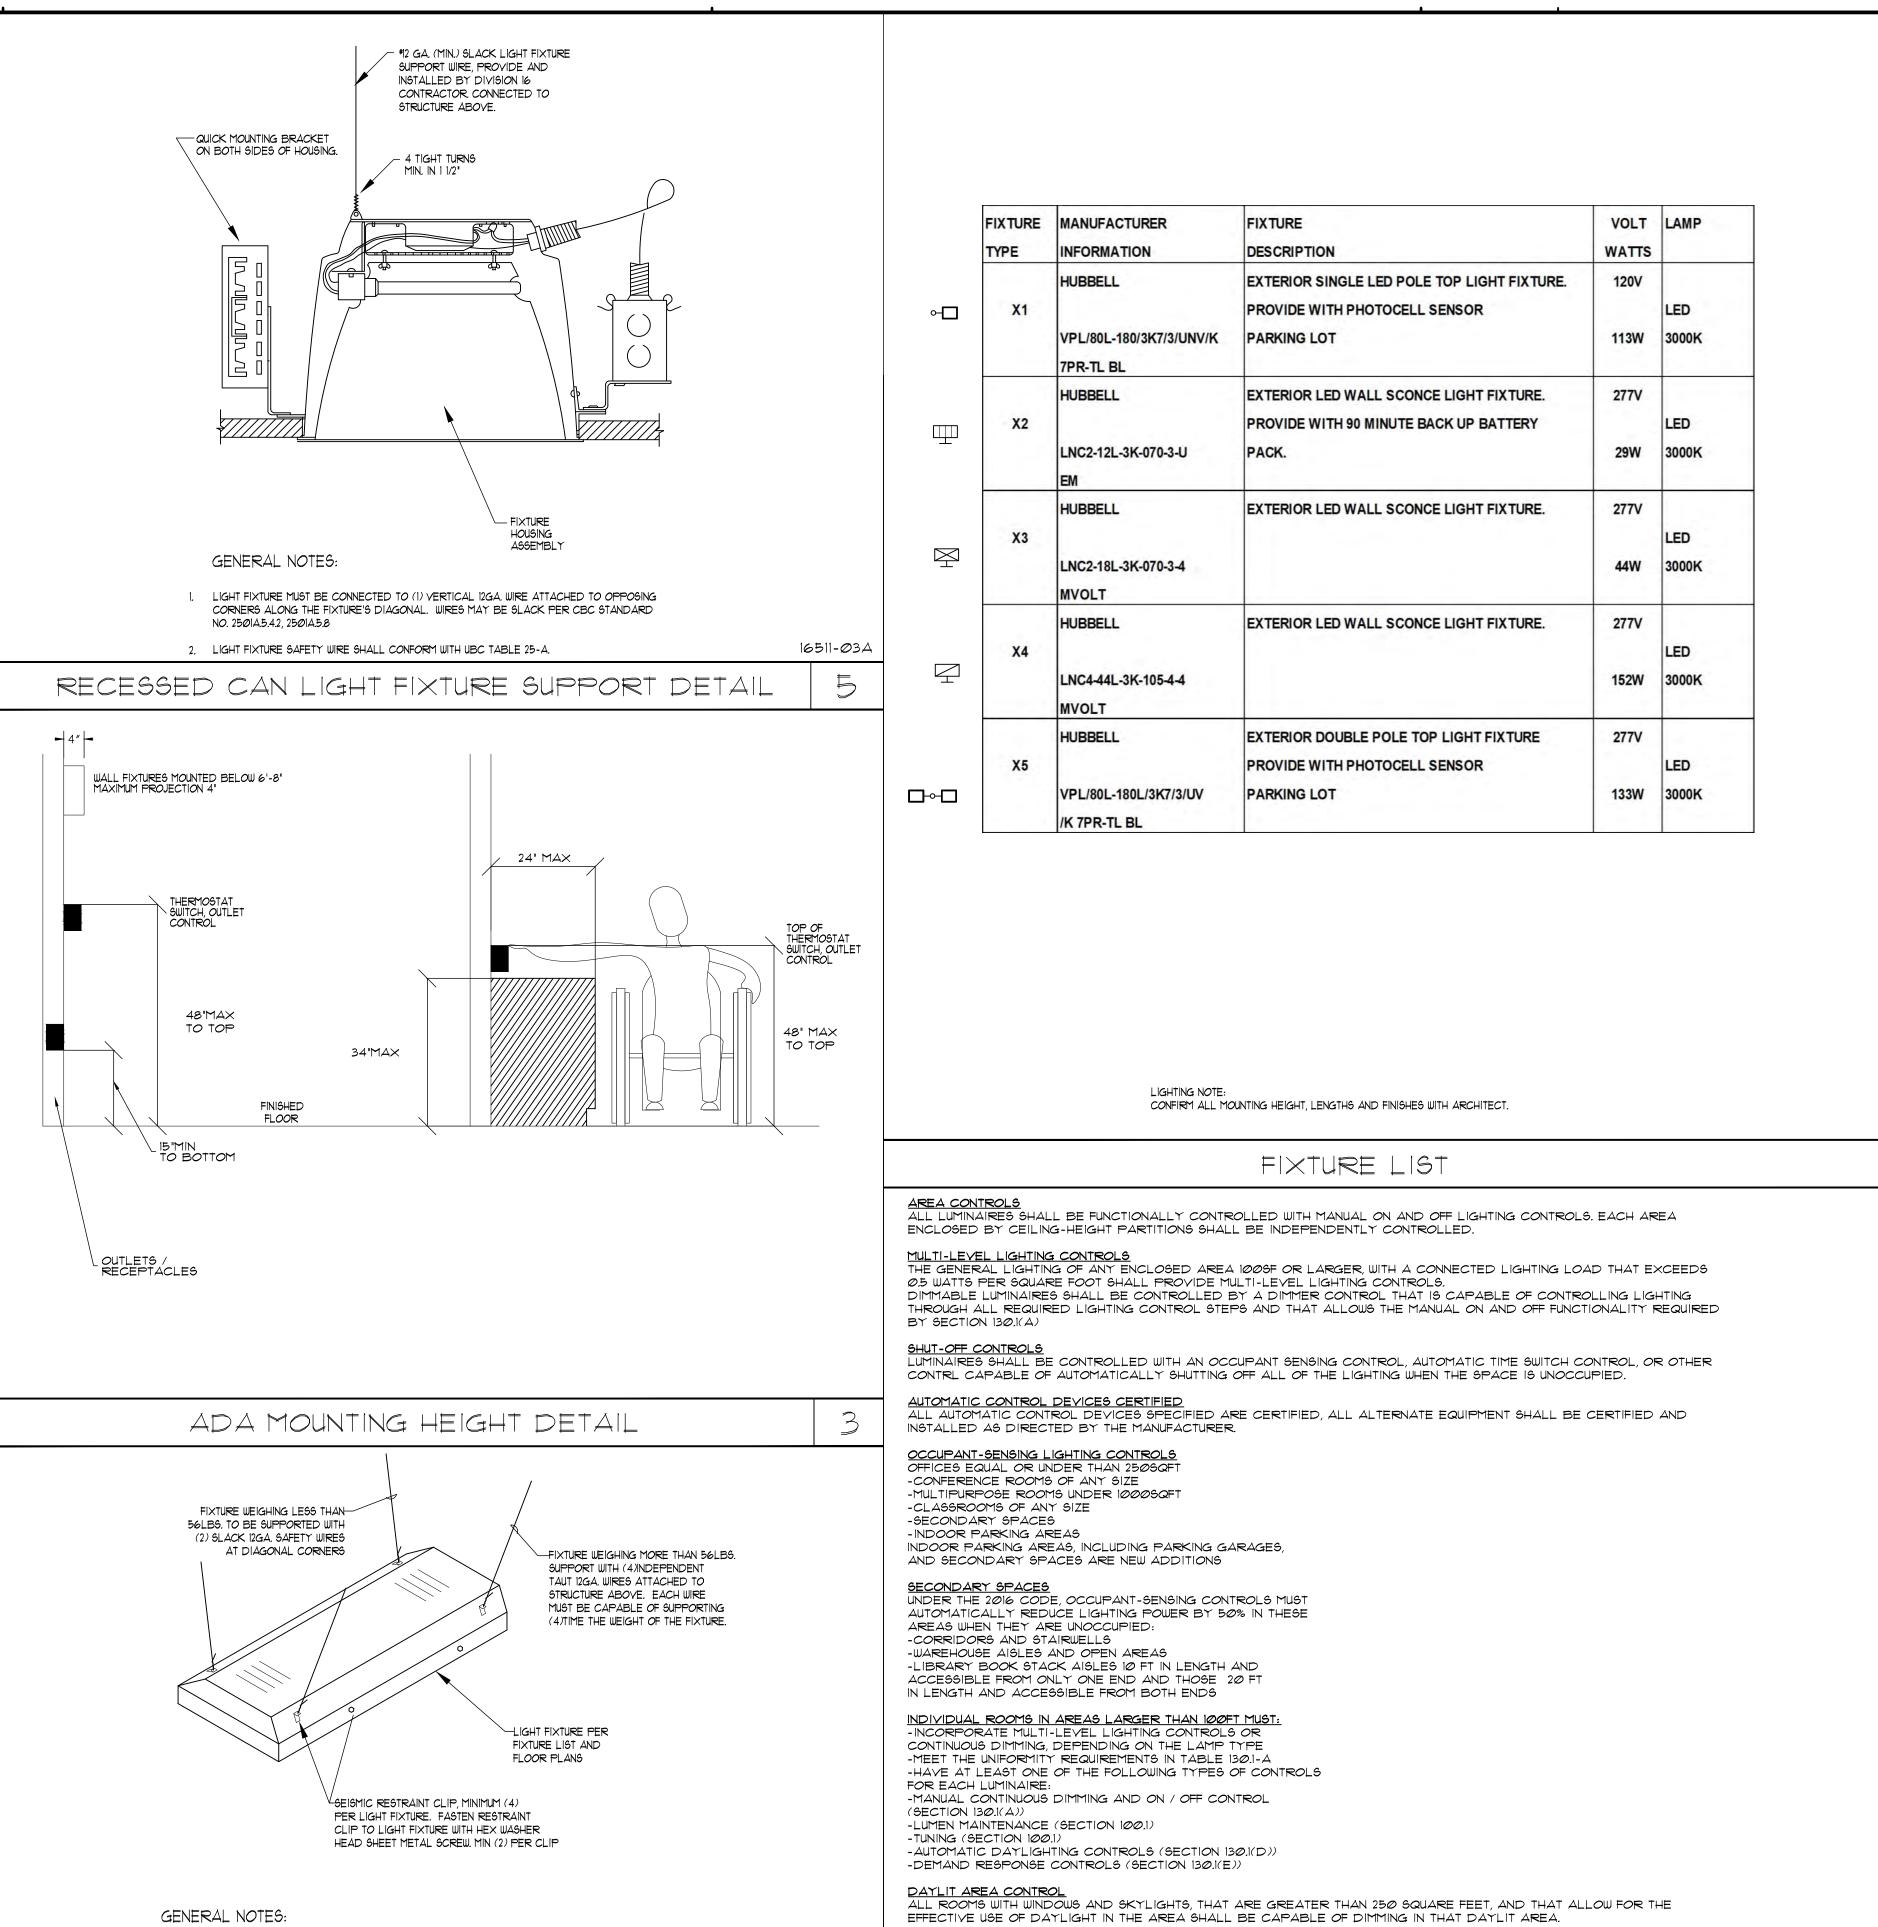

<u>DEMAND RESPONSE</u> ALL NON-RESIDENTIAL BUILDINGS LARGER 10,000 SQFT

AUTOMATICALLY RESPONDING TO A D.R. SIGNAL, SO THAT: TOTAL ENERGY USE FOR LIGHTING CAN AUTOMATICALLY

DROP TO A LEVEL AT LEAST 15% BELOW THE BUILDING'S

REQUIREMENTS FOR UNIFORM ILLUMINATION LEVELS (LISTED

2019 TITLE 24 MANDATORY NOTES

-LIGHTING IS REDUCED IN A MANNER CONSISTENT WITH

BE CAPABLE OF:

IN TABLE 13*0.*1-A)

OUTDOOR LIGHTING NOT IN SCOPE.

16511-03

MAXIMUM TOTAL LIGHTING POWER

Ø-10VDC Dimming

Ballast required.

\_Class 2 Ø-10 Volt

- Cables or CAT5e. Free Topology

Emergency Power Out

Emergency Neutral

Emergency Power In

Cut jumper loop

Normally Closed

-fire alarm panel

-security panei

Lighting Load

CONNECT TO ROOM ZONE LIGHTING

-test switch

(White IDAWG)

LIGHTING PLAN SYMBOL

Digital 5-Button Scene Switch

Dual Relay 0-10V Dimming Wiring Diagram

Emergency

Emergency Line

Emergency Neutral

Lighting

On/Off/Ø-løv Dimming

Neutral Wht

120/277

LIGHTING PLAN SYMBOL

Earth

Ground

Corner mount Sensor shown uith pigtail ≰ supplied coupler. Ceiling mount Sensor has two RJ45 ports.

LIGHTING CONTROL WIRING DIAGRAM

Normal Power Sense

Normal Switched Sense

Neutral Wh

Unswitched

Cables or CAT5e.

Free Topology &

Splitter Acceptable

EMERGENCY LIGHTING DIAGRAM

Hot Blk

(Black 18AWG)

Normal Neutral

(White 18AWG)

(Red 18AWG)

Single Relay On/Off

Koom Controller

- EM

Dual Relay

Room Controller

LIGHTING DETAIL SHEET


FIXTURE SEISMIC SUPPORT DETAIL

1. LIGHT FIXTURE MUST BE CONNECTED TO (1) VERTICAL 12GA, WIRE ATTACHED TO OPPOSING

3. INSTALL (4) METAL SCREWS, (2) ON EACH SIDE THROUGH FIXTURE INTO MAIN 'T' BAR

2. LIGHT FIXTURE SAFETY WIRE SHALL CONFORM WITH UBC TABLE 25-A.

CORNERS ALONG THE FIXTURE'S DIAGONAL. WIRES MAY BE SLACK PER CBC STANDARD

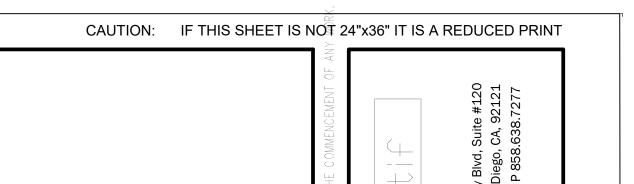


517 SHINOHARA LANE CHULA VISTA, CA 91911 SHINOHARA

PA/PM: DRAWN BY.: Author JOB NO.: SDG21-0056-00

SHEET

mpe consulting E018377 10807 Thornmint Road Ste. 200 San Diego, CA 92127 p: 858.673.4445 √E×p, 6-30-22 www.mpeconsulting.com SCALE:

1/30" = 1'-0"

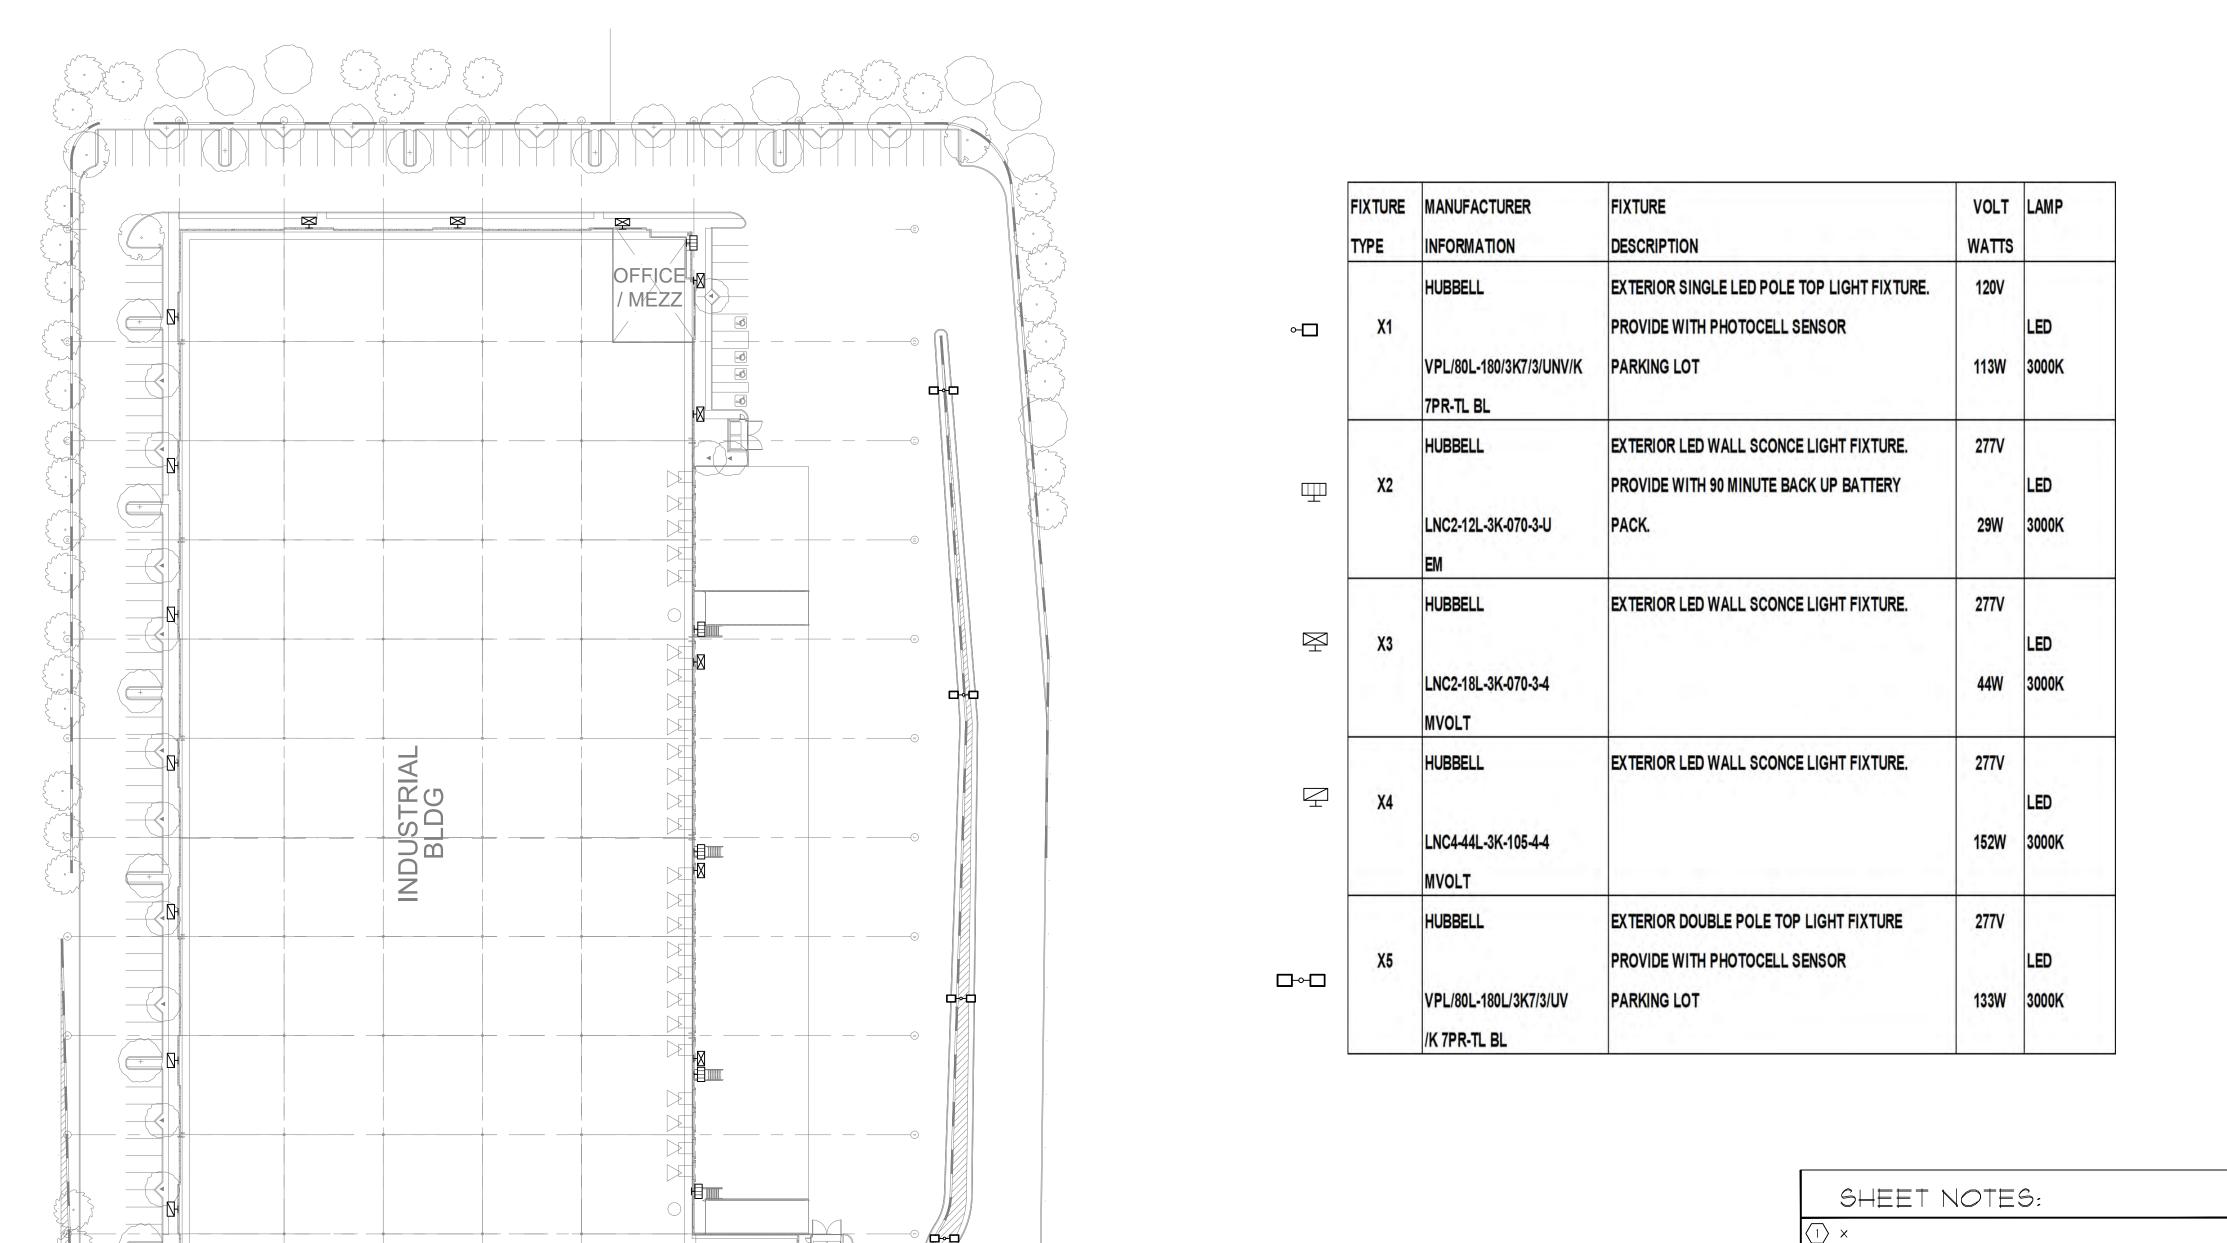


SHINOHARA BNAJ

SITE LIGHTING PLAN

OFFICE / MEZZ


#

TIMBER

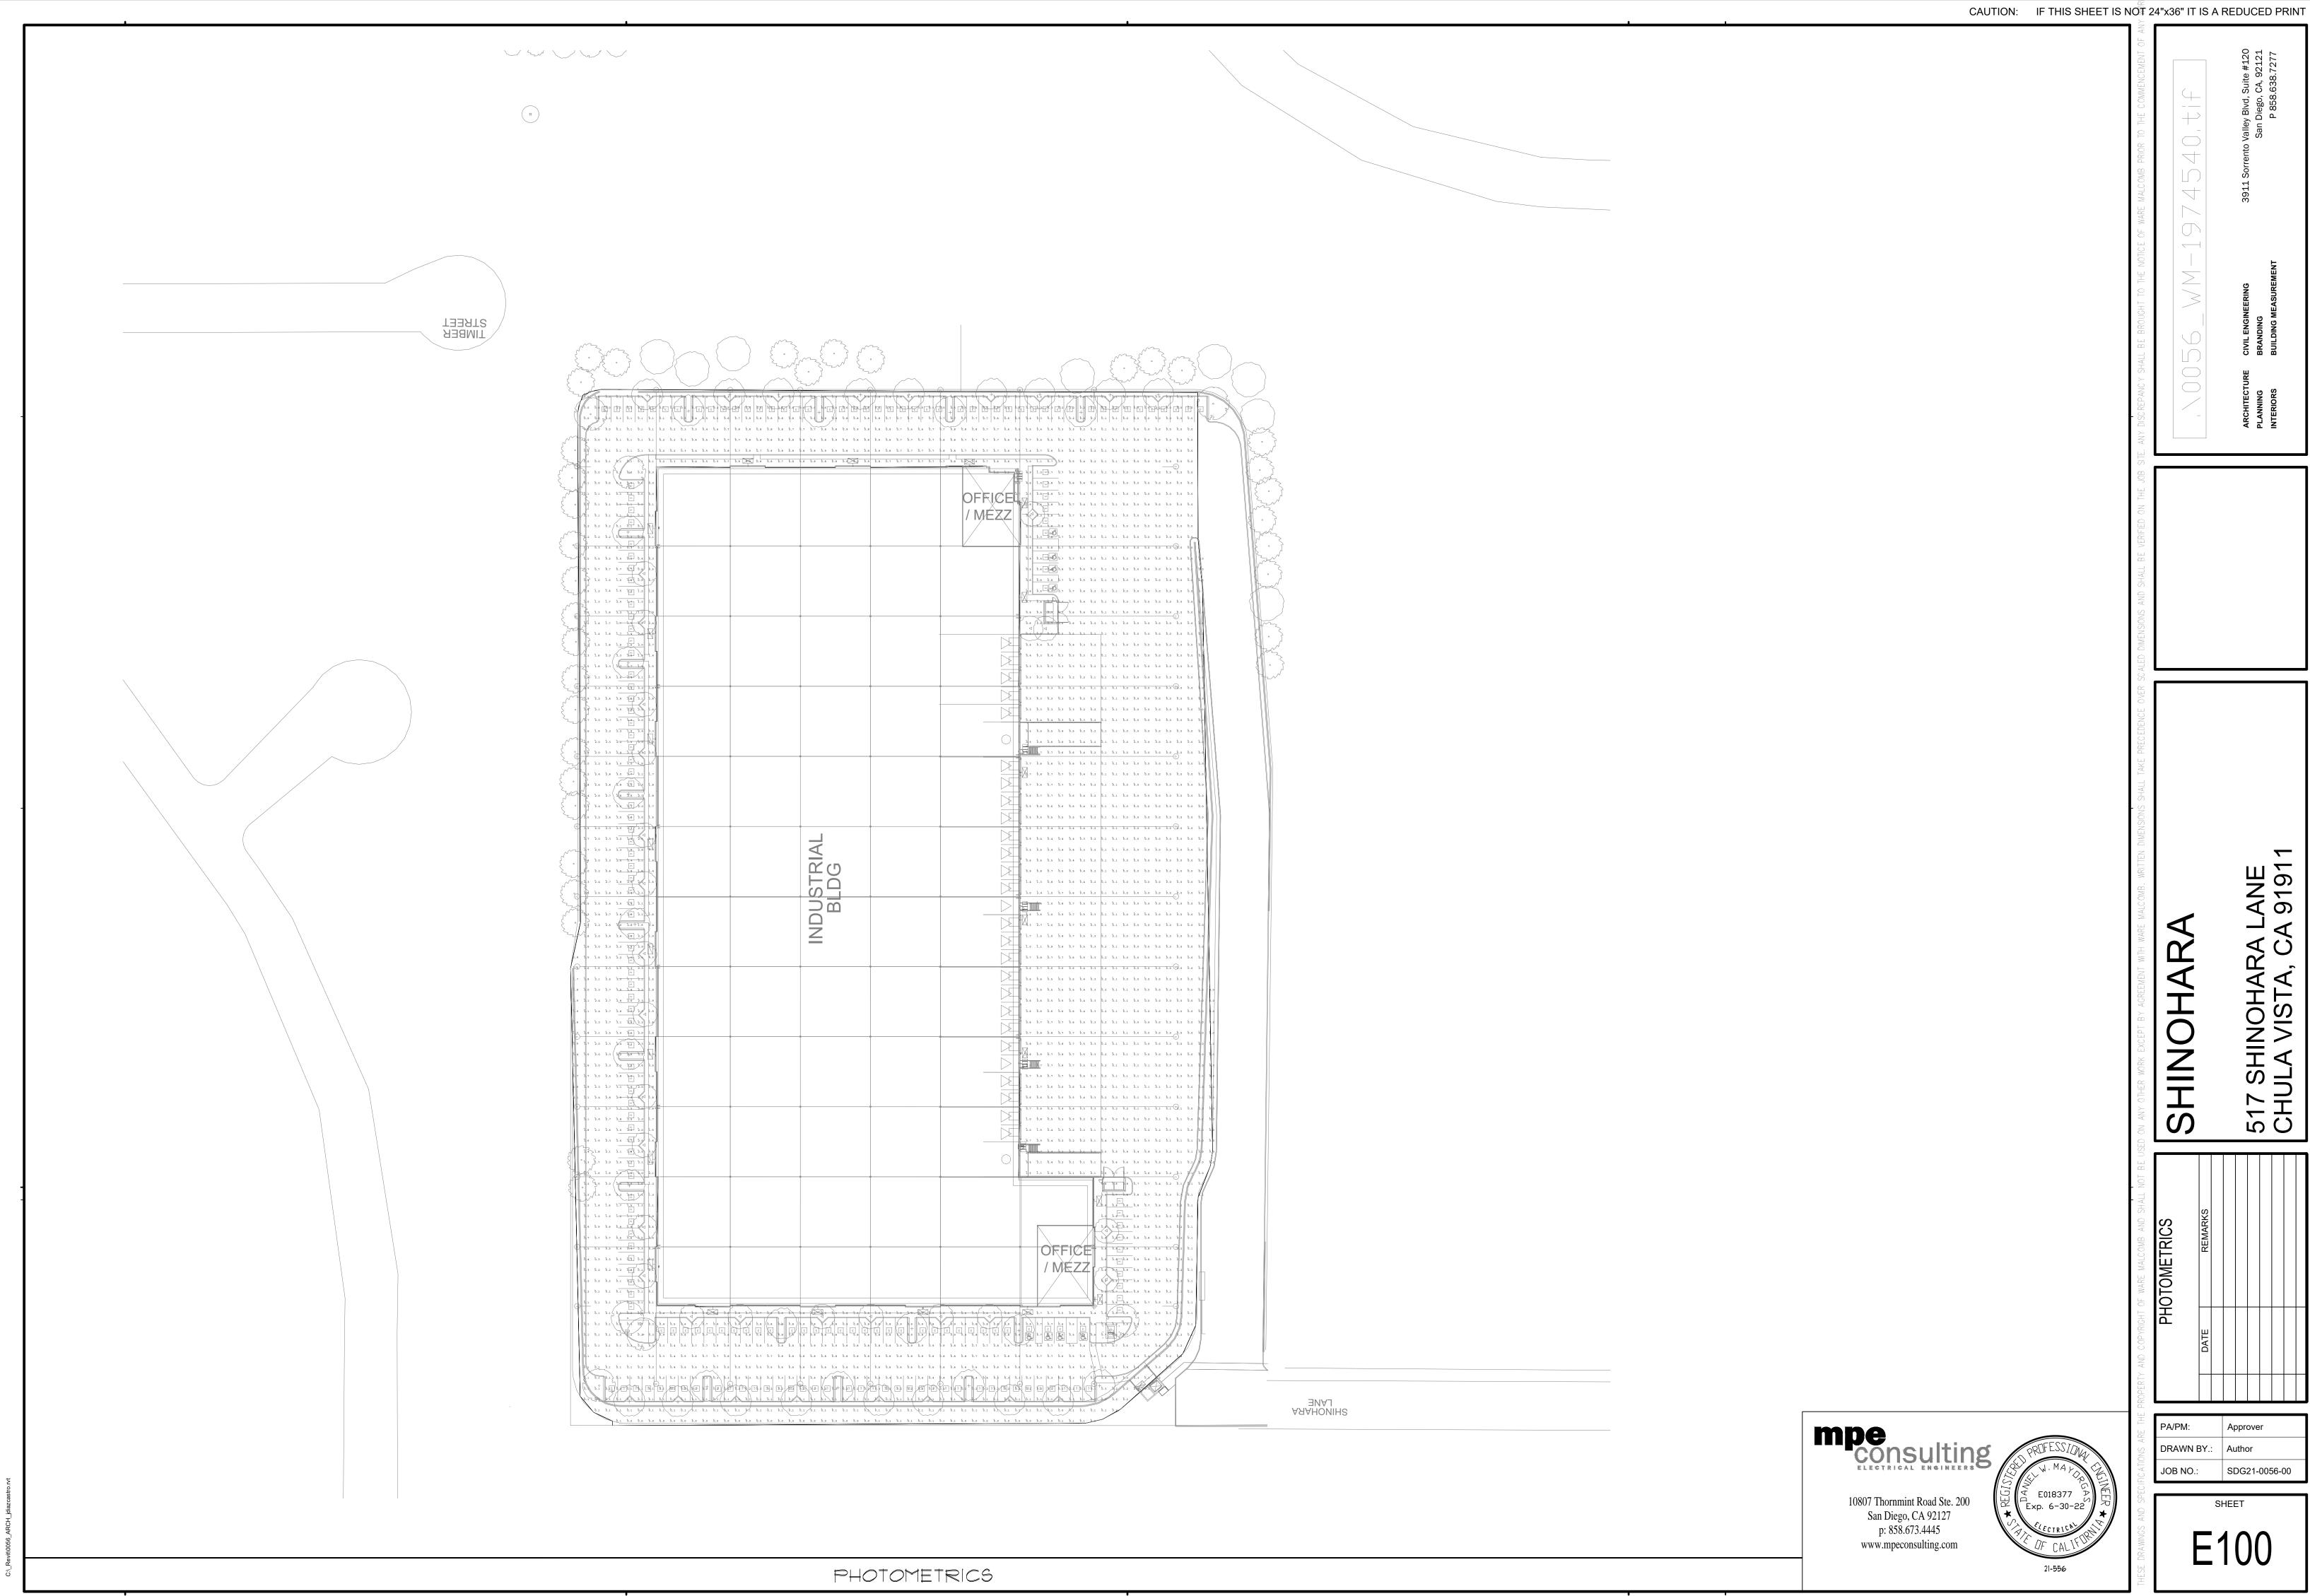

Approver

Author SDG21-0056-00

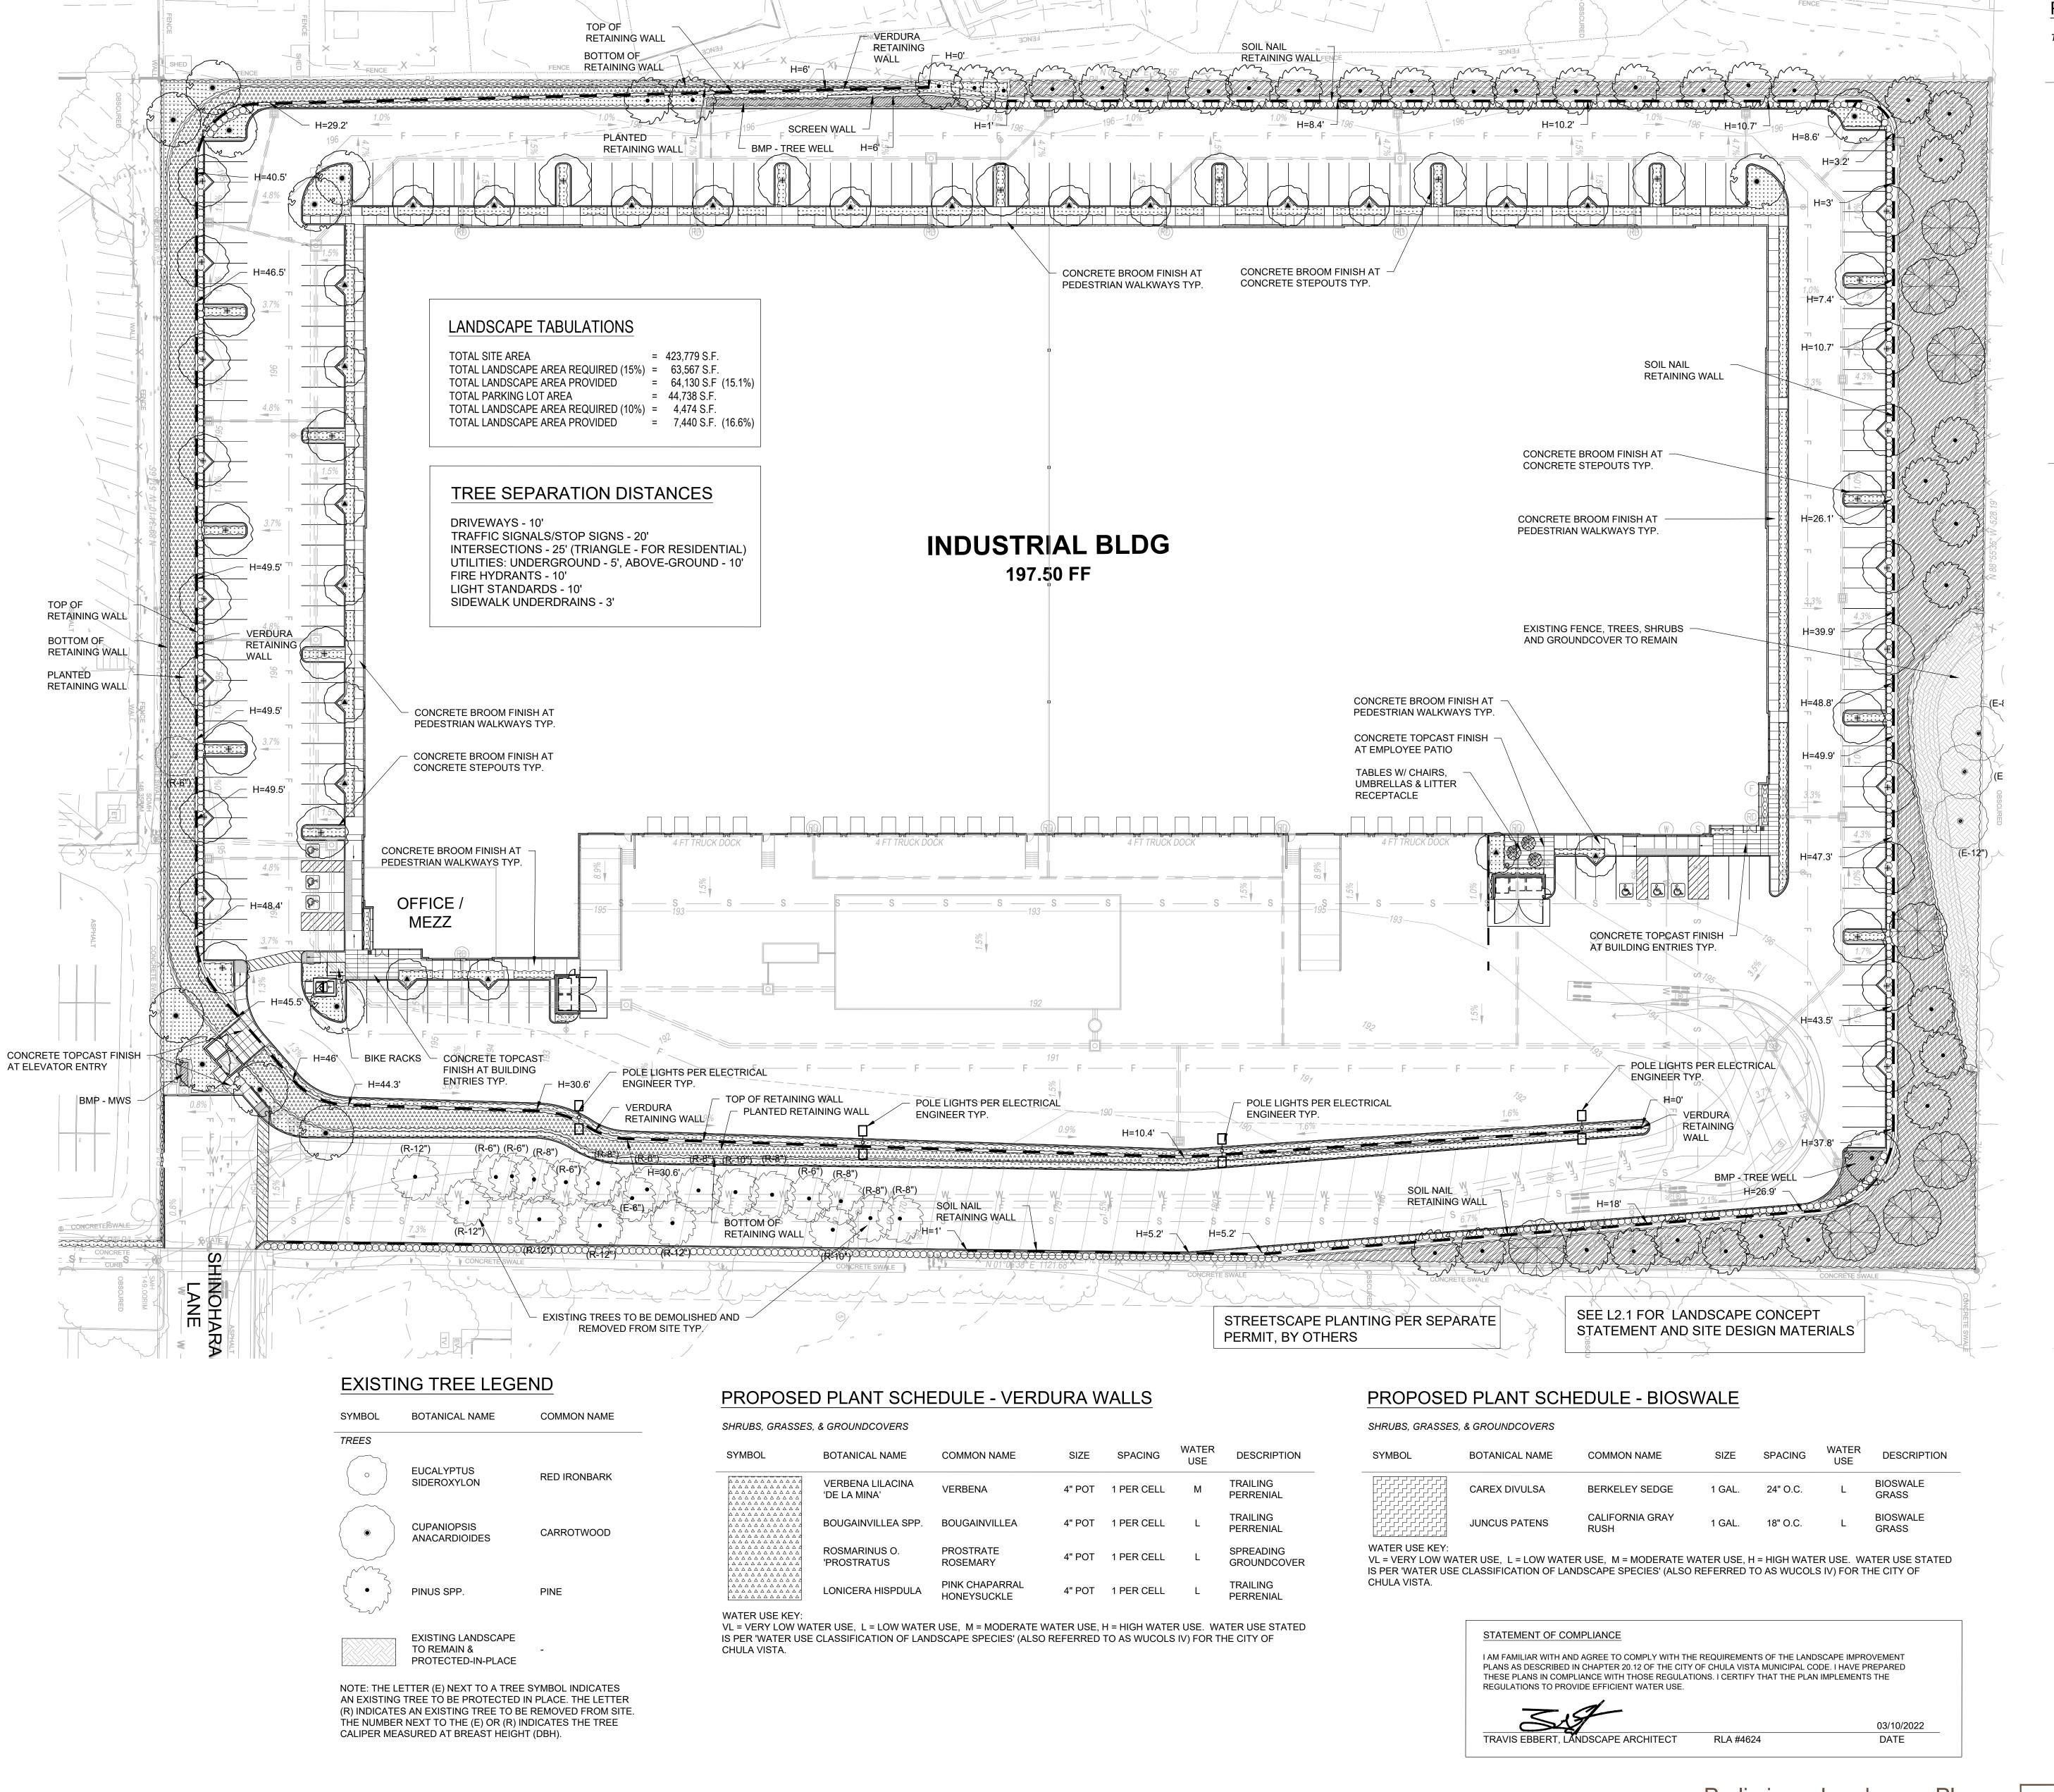

Preliminary Landscape Plan

517 Shinohara Lane Chula Vista, CA, 91911

# PROPOSED PLANT SCHEDULE

TREES						
SYMBOL	BOTANICAL NAME	COMMON NAME	SIZE / FORM	HT. X SPRD. X CAL. (MIN.)	WATER USE	DESCRIPTION
	CERCIS OCCIDENTALIS	WESTERN REDBUD	24" BOX STD.	8'H X 3'W X 1-1/2"CAL.	L	SMALL FLOWERING TREE
	PINUS ELDARICA	AFGHAN PINE	24" BOX STD.	9'H X 3'W X 1-1/4" CAL	L	VERTICAL EVERGREEN
	PLATANUS RACEMOSA	CALIFORNIA SYCAMORE	24" BOX STD.	10'H X 4'W X 1-1/2" CAL.	М	DECIDUOUS CANOPY
	QUERCUS AGRIFOLIA	COAST LIVE OAK	24" BOX STD.	9'H X 3'W X 1-1/4" CAL.	L	EVERGREEN CANOPY
+	RHUS LANCEA	AFRICAN SUMAC	24" BOX STD.	9'H X 3'W X 1-1/4" CAL.	L	EVERGREEN CANOPY
SHRUBS, GRASSES	S, & GROUNDCOVERS					
SYMBOL	BOTANICAL NAME	COMMON NAME	SIZE	SPACING	WATER USE	DESCRIPTION
× × × × × × × × × × × × × × × × × × ×	AGAVE ATTENUATA	FOXTAIL AGAVE	5 GAL.	36" O.C.	L	SUCCULENT ACCENT
x x x x x x x x x x x x x x x x x x x	ALOE VERA	MEDICINAL ALOE	1 GAL.	24" O.C.	L	SMALL SUCCULENT
	BACCHARIS P. 'TWIN PEAKS'	DWARF COYOTE BRUSH	1 GAL.	36" O.C.	L	EVERGREEN LOW SHRUB
* * * * * * * * * * * * * * * * * * *	CARISSA M. 'GREEN CARPET'	DWARF NATAL PLUM	1 GAL.	30" O.C.	L	EVERGREEN LOW SHRUB
	CAREX PANSA	CALIFORNIA MEADOW SEDGE	1 GAL.	24" O.C.	M	ORNAMENTAL GRASS
* * * * * * * * * * * * * * * * * * *	CEANOTHUS G. 'POINT REYES'	POINT REYES CREEPER	1 GAL.	36" O.C.	L	FLOWERING LOW SHRUB
	CHONDROPETALUM	CAPE REED	1 GAL.	36" O.C.	L	UPRIGHT ACCENT
	TECTORUM  DIANELLA 'CASSA	CASSA BLUE FLAX	1 GAL.	24" O.C.	L	UPRIGHT ACCENT
	BLUE' DIANELLA T.	VARIEGATED FLAX	5 GAL.	36" O.C.	L	UPRIGHT ACCENT
* * * * * * * * * * * * * * * * * * *	'VARIEGATA' HESPERALOE	LILY BRAKELIGHTS YUCCA	5 GAL.	36" O.C.	L	UPRIGHT
	'BRAKELIGHTS' HETEROMELES	TOYON	5 GAL.	60" O.C.	L	ACCENT  LARGE SHRUB
* * * * * * * * * * * * * * * * * * *	ARBUTIFOLIA LANTANA		5 GAL.	36" O.C.	L	FLOWERING
X X X X X X X X X X X X X X X X X X X	MONTEVIDENSIS	PURPLE LANTANA			L	SHRUB FLOWERING
X X X X X X X X X X X X X X X X X X X	LANTANA NEW GOLD	NEW GOLD LANTANA	5 GAL.	36" O.C.	L	LOW SHRUB ORNAMENTAL
X X X X X X X X X X X X X X X X X X X	MUHLENBERGIA C. 'REGAL MIST'	PINK MUHLY	1 GAL.	36" O.C.	M	GRASS
	MUHLENBERGIA RIGENS	DEER GRASS	1 GAL.	36" O.C.	L	ORNAMENTAL GRASS
X X X X X X X X X X X X X X X X X X X	OLEA 'MONTRA'	LITTLE OLLIE	5 GAL.	48" O.C.	L	LARGE SHRUB
X X X X X X X X X X X X X X X X X X X	RHAPHIOLEPIS INDICA 'CLARA'	INDIAN HAWTHORN	5 GAL.	36" O.C.	L	EVERGREEN SHRUB
X X X X X X X X X X X X X X X X X X X	SALVIA GREGGII	AUTUMN SAGE	5 GAL.	36" O.C.	L	FLOWERING SHRUB
	SENECIO SERPENS	BLUE CHALKSTICKS	FLATS	12" O.C.	L	SUCCULENT GROUNDCOVE
$\bigcirc$	WESTRINGIA	COAST ROSEMARY	5 GAL.	36" O.C.	L	EVERGREEN HEDGE


WATER USE KEY: VL = VERY LOW WATER USE, L = LOW WATER USE, M = MODERATE WATER USE, H = HIGH WATER USE. WATER USE STATED IS PER 'WATER USE CLASSIFICATION OF LANDSCAPE SPECIES' (ALSO REFERRED TO AS WUCOLS IV) FOR THE CITY OF

# PROPOSED PLANT SCHEDULE - SLOPES

'WYNYABBIE GEM'

SHRUBS, GRASSES, & GROUNDCOVERS DESCRIPTION SYMBOL COMMON NAME SIZE SPACING BOTANICAL NAME BACCHARIS P. DWARF COYOTE **EVERGREEN** 1 GAL. 8' O.C. 'PIGEON POINT' BRUSH LOW SHRUB RED SHRUB BOUGAINVILLEA 'LA **FLOWERING** 1 GAL, 48" O.C. BOUGAINVILLEA JOLLA' SHRUB ROSMARINUS O. PROSTRATE **EVERGREEN** 'PROSTRATUS ROSEMARY LOW SHRUB SALVIA CLEVELANDII POZO BLUE SAGE 5 GAL. 48" O.C. UPRIGHT SHRUB 'POZO BLUE' **HETEROMELES** TOYON 5 GAL. 60" O.C. LARGE SHRUB ARBUTIFOLIA **RHUS OVATA** SUGAR BUSH LARGE SHRUB


WATER USE KEY: VL = VERY LOW WATER USE, L = LOW WATER USE, M = MODERATE WATER USE, H = HIGH WATER USE. WATER USE STATED IS PER 'WATER USE CLASSIFICATION OF LANDSCAPE SPECIES' (ALSO REFERRED TO AS WUCOLS IV) FOR THE CITY OF CHULA VISTA.

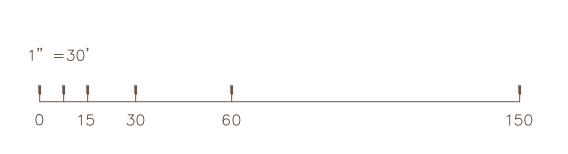








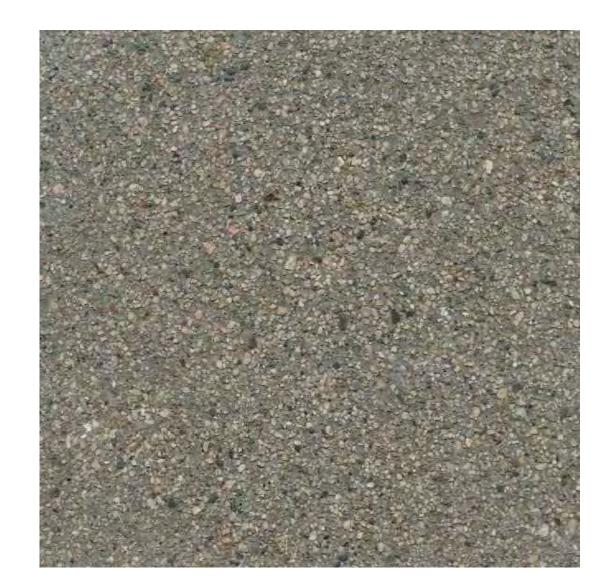

NATURAL COLOR CONCRETE W/ ACID ETCH OR TOPCAST FINISH AT BUILDING **ENTRIES & EMPLOYEE PATIOS** 

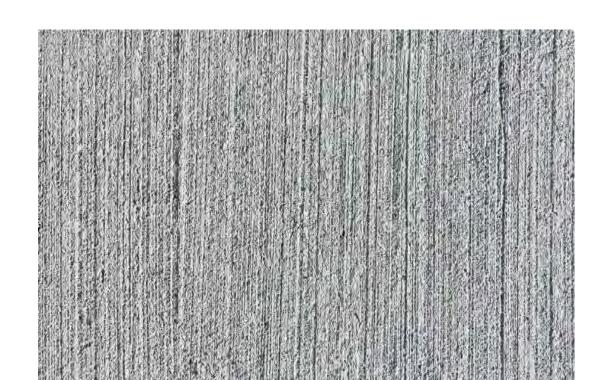


NATURAL COLOR CONCRETE W/ MEDIUM **BROOM FINISH AT PEDESTRIAN** WALKWAYS

# HARDSCAPE MATERIAL AND FINISHES



LANDSCAPE FORMS TABLES AND CHAIRS AT EMPLOYEE PATIO

SITE FURNISHINGS

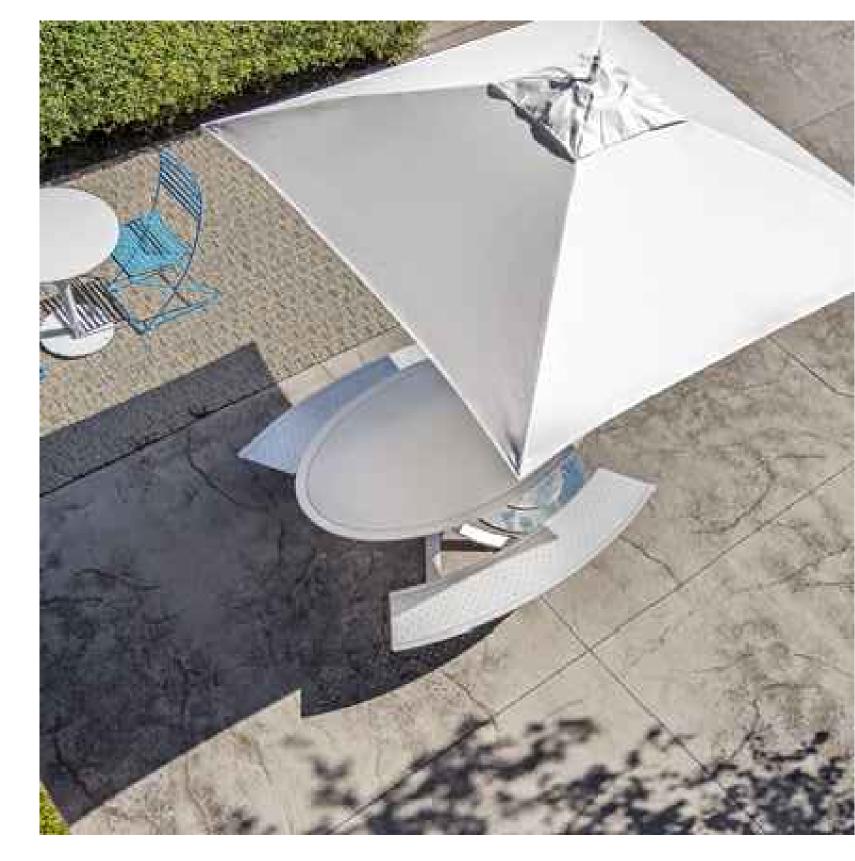

TUUCI COMMERCIAL UMBRELLAS AT EMPLOYEE PATIO

BEACON-HUBBLE VIPER LARGE STRIKE OPTIC PARKING POLE LIGHT BLACK TEXTURED SEE E1.1 FOR COMPLETE SPECIFICATIONS

SITE LIGHTING



VERDURA WALL RETAINING WALL BY SOIL RENTENTION **COLOR TBD** 

RETAINING WALL SPECIFICATIONS



SOIL NAIL WALL SMOOTH TROWEL FINISH COLOR TBD

# LANDSCAPE CONCEPT STATEMENT OF COMPLIANCE

THIS LANDSCAPE DESIGN AND THE FINAL LANDSCAPE PLANS WILL REFLECT CONFORMANCE WITH THE CITY OF CHULA VISTA'S LANDSCAPE WATER CONSERVATION ORDINANCE (CVMC20.12), PROMOTING WATER CONSERVATION THROUGH THE USE OF MODERATE NAD LOW-WATER REQUIRING PLANT SPECIES, GROUPING OF PLANT MATERIALS WITH SIMILAR WATER REQUIREMENTS AND IMPLEMENTING A LOW-VOLUME AND EFFICIENT AUTOMATIC IRRIGATION SYSTEM.

# LANDSCAPE DESIGN CONCEPT STATEMENT

THE LANDSCAPE DESIGN WILL BE SUSTAINABLE WITH AN EMPHASIS ON DROUGHT TOLERANT, NATIVE OR ADAPTIVE SPECIES THAT ARE LONG LIVED AND EASILY MAINTAINED IN THEIR NATURAL FORM. APPROXIMATELY 90% OF THE PLANTS USED WILL HAVE LOW WATER REQUIREMENTS BASED UPON THE "2017 WATER USE CLASSIFICATION OF LANDSCAPE SPECIES" (WUCOLS) AND WILL CONFORM TO CURRENT WATER CONSERVATION STANDARDS INCLUDING THE CITY OF CHULA VISTA LANDSCAPE WATER CONSERVATION ORDINANCE. PLANT MATERIAL WILL BE GROUPED BY HYDROZONES THAT HAVE SIMILAR WATER NEEDS.


EVERGREEN TREES WILL BE USED TO PROVIDE SHADE OVER PARKING AREAS AND TO SOFTEN THE BUILDING FACADE, WHILE FLOWERING DECIDUOUS TREES WILL BE USED TO ACCENTUATE THE BUILDING ENTRY AND OUTDOOR PATIO SPACES. HEDGES WILL BE USED TO SCREEN PARKING AREAS FROM THE PUBLIC RIGHT-OF-WAY AND ADJACENT PARCELS, AND EVERGREEN VINES WILL BE USED TO HELP SCREEN THE TRASH ENCLOSURE. SHRUBS AND GROUND COVERS WITH VARYING FORMS, COLORS AND TEXTURES WILL BE USED THROUGHOUT THE PROJECT TO PROVIDE INTEREST. THE PLANT PALETTE WILL COMPLEMENT THE ADJACENT PARCELS AND STREETSCAPE TO HELP VISUALLY BLEND THE PROJECT INTO THE SURROUNDING OTAY RIVER BUSINESS PARK.

# IRRIGATION DESIGN CONCEPT STATEMENT

IRRIGATION DESIGN WILL CONFORM TO CURRENT WATER CONSERVATION STANDARDS INCLUDING THE CITY OF CHULA VISTA LANDSCAPE WATER CONSERVATION ORDINANCE AND THE STATE MODEL WATER EFFICIENT LANDSCAPE ORDINANCE (MWELO). IRRIGATION WILL BE DISTRIBUTED BY IN LINE DRIP TUBING AND A SMART IRRIGATION CONTROLLER WITH RAIN SHUT-OFF CAPABILITIES. THE VALVES WILL BE GROUPED BY HYDROZONE, EXPOSURE, SOIL TYPE AND GRADING FEATURES.

# MAINTENANCE RESPONSIBILITY STATEMENT

OWNER IS RESPONSIBLE FOR INSTALLATION AND ONGOING MAINTENANCE OF IRRIGATION AND PLANTING WITHIN BOTH THE PUBLIC RIGHT-OF-WAY AND THE PROPERTY ITSELF.

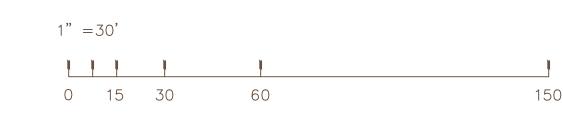





SHEET

L2.1

Preliminary Landscape Plan