CANYON ROAD SOLAR CANYON RD, LOS BANOS, CA 93635, USA

PRELIM LAYOUT 09/29/22


PRELIM LAYOUT 09/23/22

REVISIONS

RENEWABLE PROPERTIES

INDEX OF DRAWINGS

SHEET#	SHEET TITLE
T-001	COVER SHEET
PV-100	SITE PLAN
E-100	SINGLE LINE DIAGRAM

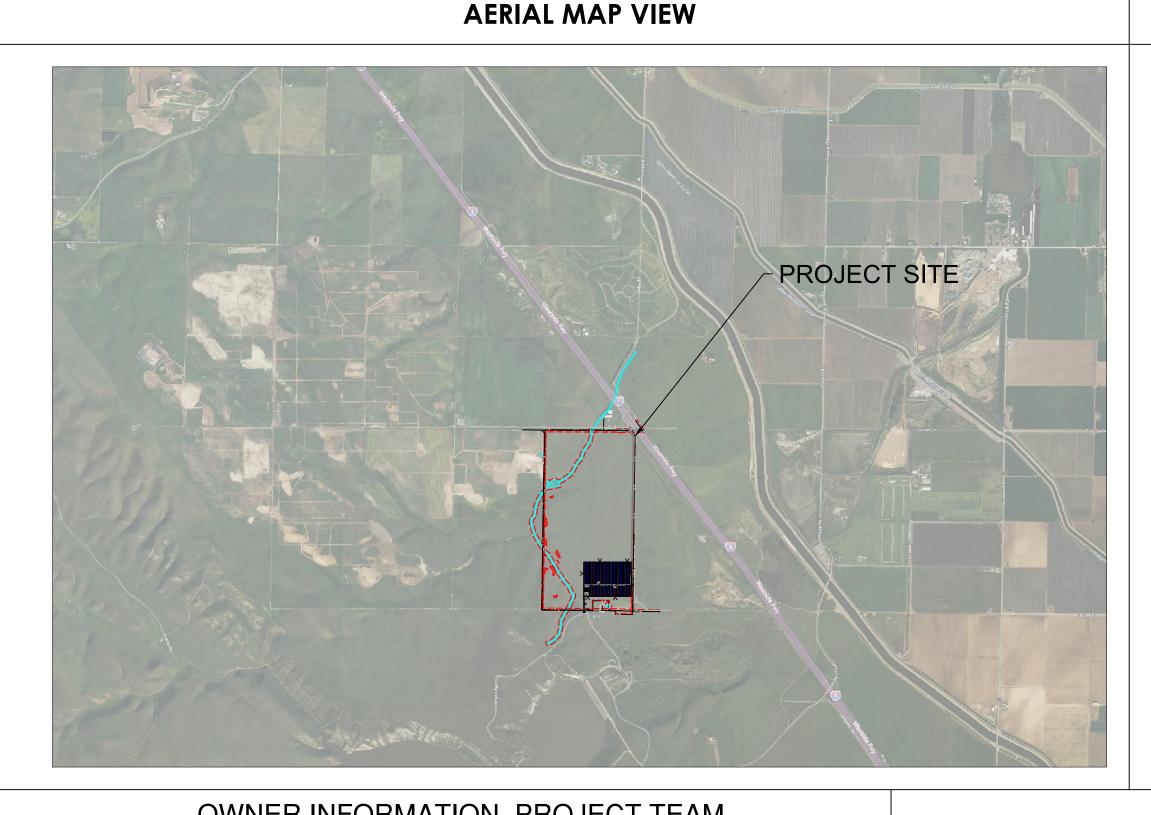

DEVELOP NEW SOLAR PHOTOVOLTAIC ELECTRICAL
GENERATING FACILITIES ON APPROXIMATELY 31.85 ACRES OF
LAND. THE SOLAR POWER PLANT WILL BE A SINGLE AXIS
TRACKER SYSTEM. THE ENTIRE SITE WILL HAVE MINIMAL
EARTHWORK DISTURBANCE AND GRADING OPERATIONS WILL
OCCUR MAINLY FOR INSTALLATION OF ACCESS ROADS AND
EQUIPMENT PADS.

GENERAL PROJECT SCOPE OF WORK

DC NAMEPLATE: 7,494.12 kW AC RATING: 5,000.00 kW

SOLAR MODULE QTY & MODEL: (13,878) ASTRONERGY CHSM72M(DG)/F-BH, 540W


INVERTER QTY & MODEL: (40) SUNGROW SG125HV, 125KW

OWNER INFORMATION, PROJECT TEAM	
OWNER OF RECORD: ALBERT RANCH, LLC	WORK PERFORME APPLICABLE PUBL BELOW:
PROJECT APPLICANT: RPCA SOLAR 6, LLC	NATIONAL • 2018 INTERNA
PROJECT ENGINEER: SEQUOIA ENGINEERING & DESIGN ASSOCIATES	NATIONAL FIRNATIONAL ELE
ZONING DISTRICT: A-2 (EXCLUSIVE AGRICULTURAL)	UNDERWRITEUS DEPARTMENFPA 704
GENERAL PLAN DESIGNATION: FP (FOOTHILL PASTURE)	 STATE 2019 CALIFOR 2019 CALIFOR 2019 CALIFOR

CODES & REGULATIONS

WORK PERFORMED AND MATERIALS FURNISHED SHALL CONFORM TO THE APPLICABLE PUBLICATIONS AND STANDARDS OF THE ORGANIZATIONS LISTED BELOW:

- 2018 INTERNATIONAL BUILDING CODE (IBC)
- NATIONAL FIRE PROTECTION ASSOCIATION (NFPA)
 - NATIONAL ELECTRIC CODE, 2020 EDITION
- UNDERWRITERS LABORATORIES INV. (UL)
- US DEPARTMENT OF LABOR, OCCUPATIONAL SAFETY AND HEATH ACT (OSHA)
- 2019 CALIFORNIA BUILDING CODE
- 2019 CALIFORNIA ELECTRICAL CODE
- 2019 CALIFORNIA ENERGY CODE
- 2019 CALIFORNIA FIRE CODE
- RULE 21 GUIDELINES
- CALIFORNIA OCCUPATIONAL SAFETY AND HEALTH ACT (CAL OSHA)

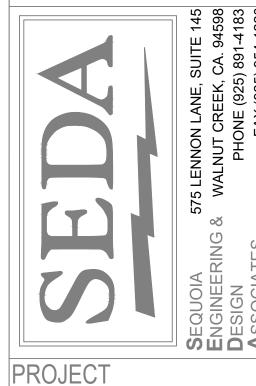

FIXOJECT

CANYON ROAD SOL/ CANYON ROAD, LOS BANOS, CA 93635, LAT: 37.000250°

SHEET TITLE


SITE PLAN

SCALE: AS SHOWN
DRAWN: LR

DATE: 09/29/22

PV-100

NOT FOR CONSTRUCTION.

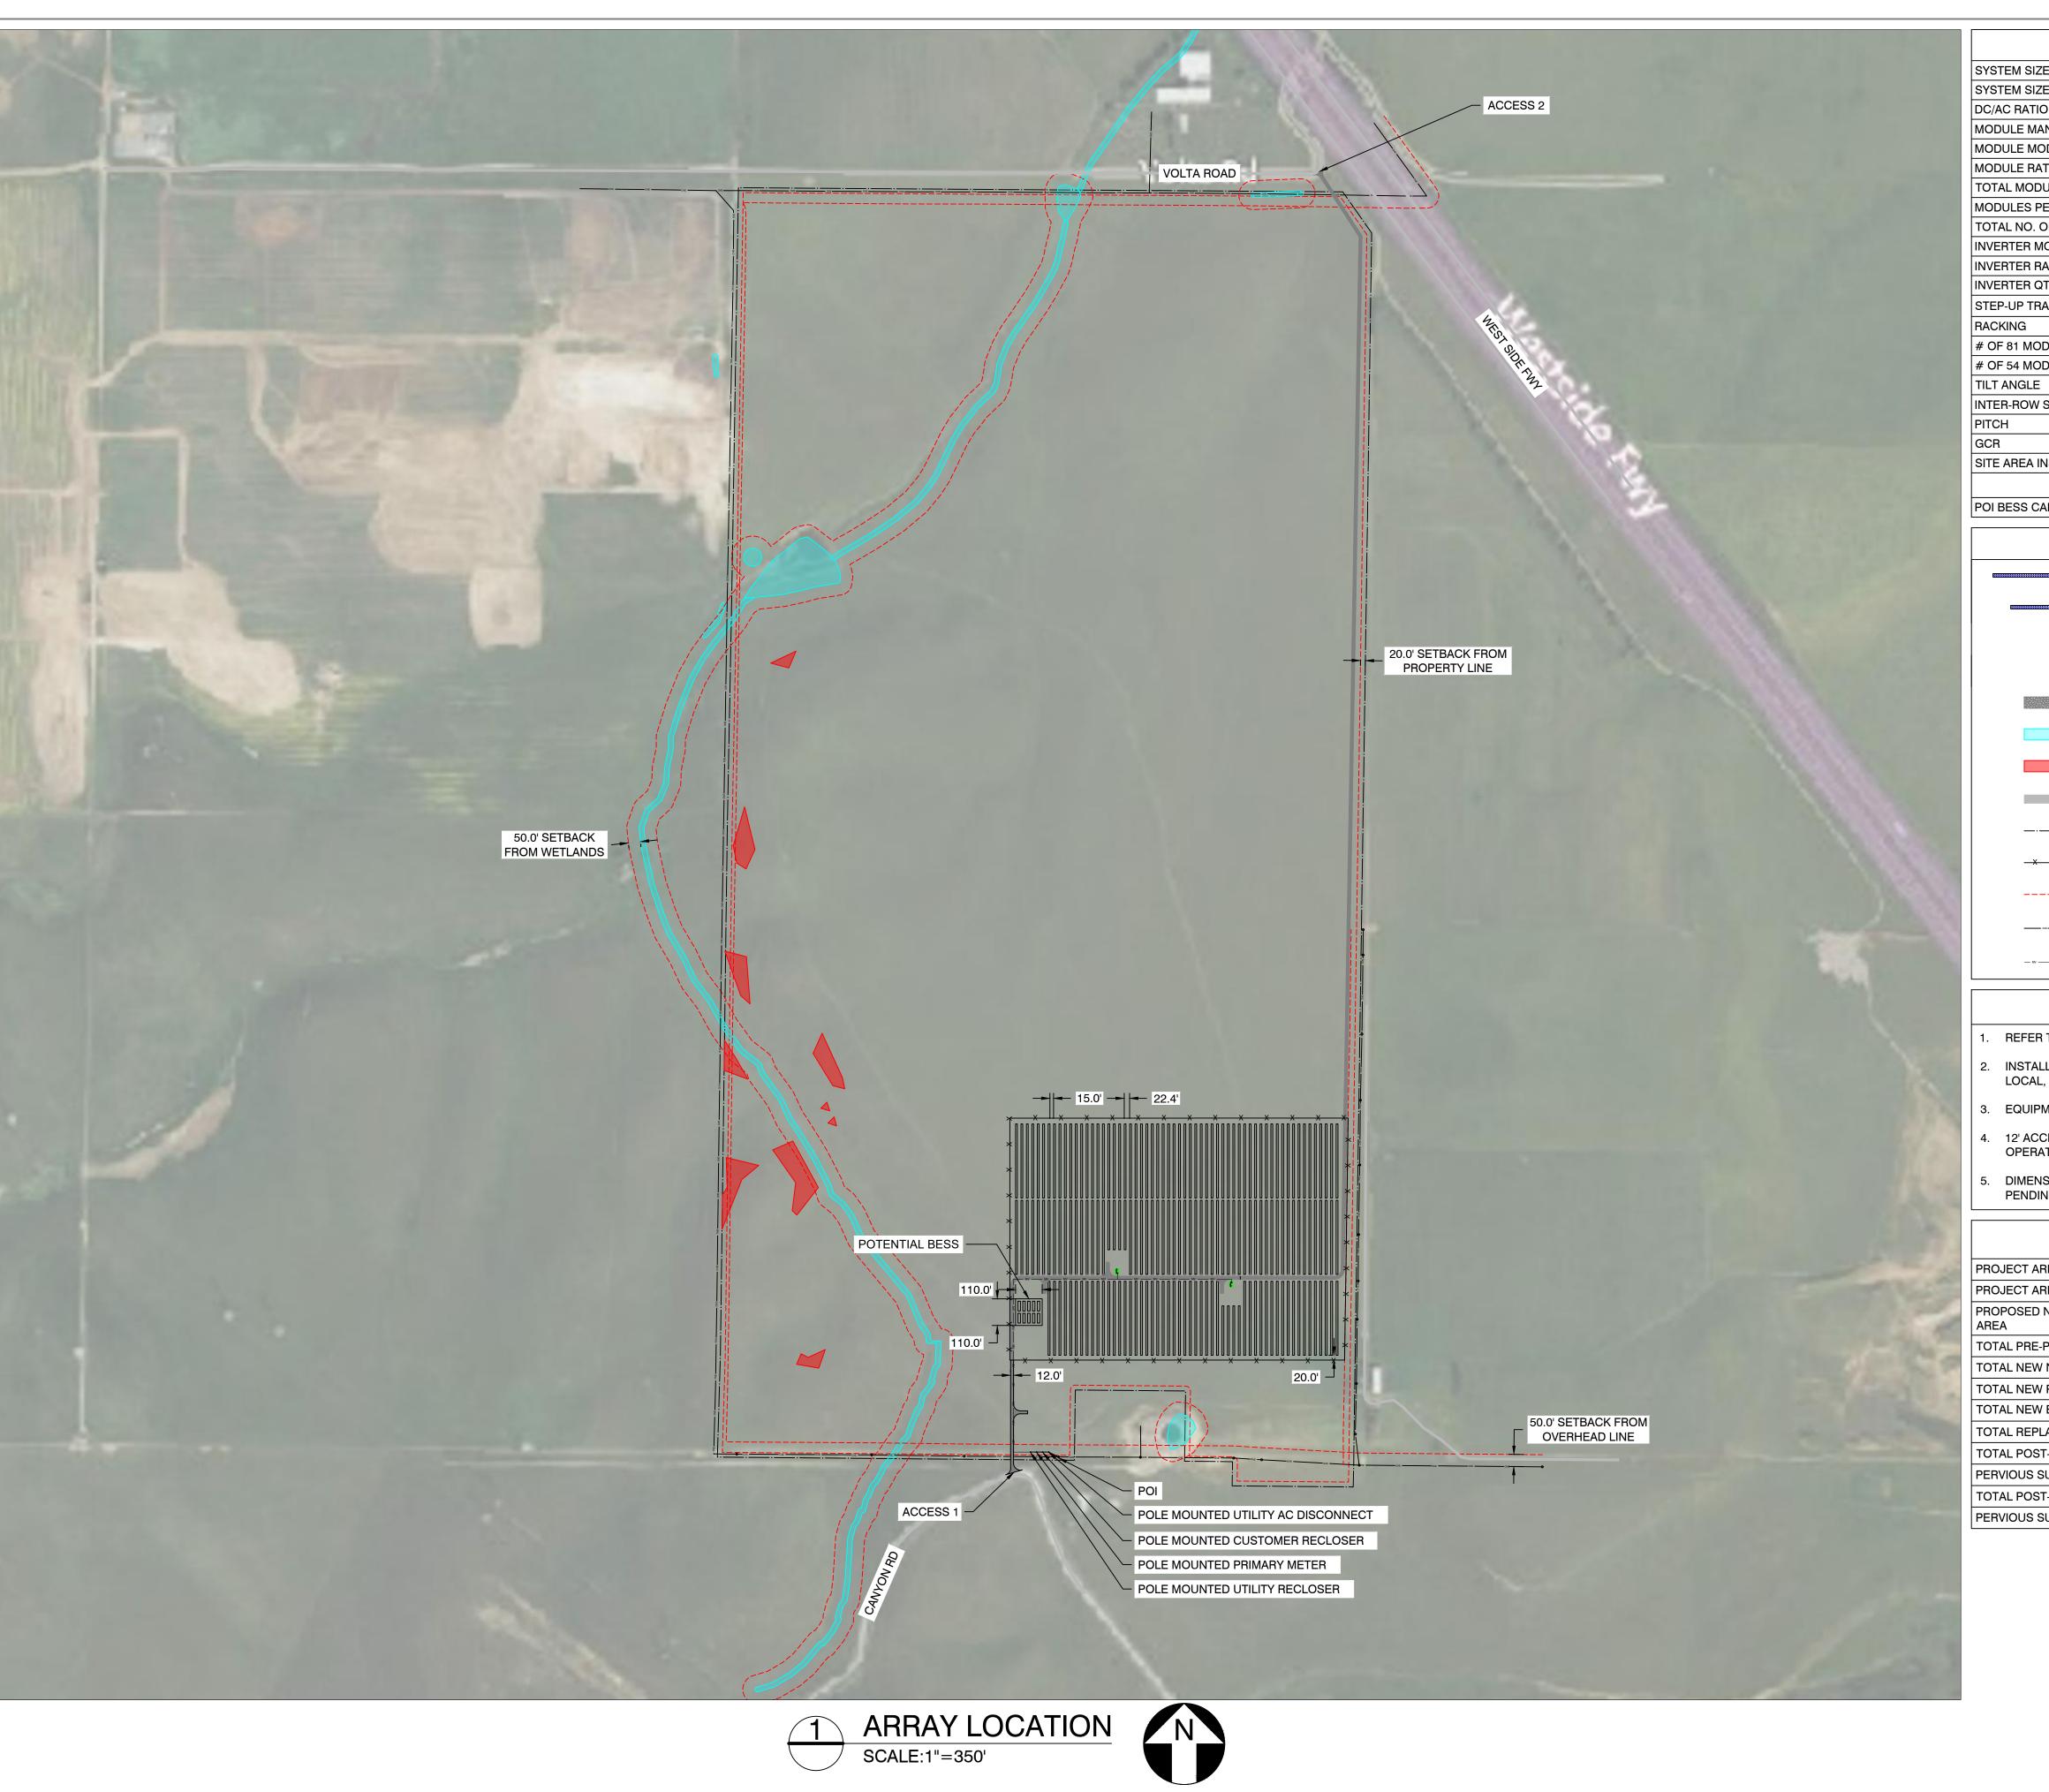

SYSTEM SPECIFICATIONS 7,494.12 kW SYSTEM SIZE DC 5,000.00 kW SYSTEM SIZE AC 1.50 DC/AC RATIO MODULE MANUFACTURER ASTRONERGY CHSM72M(DG)/F-BH MODULE MODEL MODULE RATING 540 W TOTAL MODULE QTY 13,878 MODULES PER STRING TOTAL NO. OF STRINGS SUNGROW SG125HV INVERTER MODEL INVERTER RATING 125 kW INVERTER QTY STEP-UP TRANSFORMER (2)12kV/600V, 2500kVA ATI HSAT # OF 81 MODULE TRACKER ROW # OF 54 MODULE TRACKER ROW INTER-ROW SPACING 22.4' 33% SITE AREA INSIDE FENCE 31.85 Ac BESS DETAILS 20,000 KWH POI BESS CAPACITY

<u>LEGEND</u> ATI 81 MODULE TRACKER ROW ATI 54 MODULE TRACKER ROW POWER STATION - (1) MV TRANSFORMER, (1) DAS, (1) WEATHER STATION SUNGROW 125kW STRING INVERTER 12' WIDE SITE ACCESS NATIVE COMPACTED ROAD WETLANDS HIGH SLOPES (E) PUBLIC ROAD PROPERTY LINE PROJECT SITE SECURITY FENCE _x x x SETBACK _____ (E) OH LINES MV CABLE — MV —— MV —— MV —

GENERAL NOTES

- REFER TO SINGLE LINE DIAGRAM FOR DETAILS.
- 2. INSTALLATION TO COMPLY WITH NEC 2020 ARTICLE 690 AND ALL APPLICABLE LOCAL, STATE AND NATIONAL CODES OR REGULATIONS.
- 3. EQUIPMENT SHALL BE LABELED PER NEC 690 AND UTILITY REGULATIONS.
- 12' ACCESS ROADS SHALL BE DESIGNED TO ACCOMMODATE ALL CONSTRUCTION, OPERATIONS, MAINTENANCE, AND UTILITY TRAFFIC THROUGHOUT THE SITE.
- DIMENSIONS TO PROPERTY LINES AND EXISTING FEATURES ARE APPROXIMATE PENDING SURVEY.

PROPOSED CONDITIONS			
PROJECT AREA, FENCED	1,387,372.09	SQFT.	
PROJECT AREA, FENCED	31.85	AC.	
PROPOSED NATIVE COMPACTED ROAD OUTSIDE OF FENCED AREA	54,793	SQFT.	
TOTAL PRE-PROJECT IMPERVIOUS	0	SQFT.	
TOTAL NEW NATIVE COMPACTED ROAD	85,901	SQFT.	
TOTAL NEW POWER STATIONS	700	SQFT.	
TOTAL NEW ENERGY STORAGE CONTAINERS (BESS)	2,400	SQFT.	
TOTAL REPLACED IMPERVIOUS SURFACE	0	SQFT.	
TOTAL POST-PROJECT IMPERVIOUS SURFACE WITH BESS	3,144	SQFT.	
PERVIOUS SURFACE AREA REDUCTION WITH BESS	0.23	%	
TOTAL POST-PROJECT IMPERVIOUS SURFACE WITHOUT BESS	744	SQFT.	
PERVIOUS SURFACE AREA REDUCTION WITHOUT BESS	0.05	%	

PRELIMINARY NOT FOR CONSTRUCTION

REVISIONS PRELIM LAYOUT 09/29/22 $/_3$ \ PRELIM LAYOUT 09/23/22

RENEWABLE PROPERTIES

N I I I

PROJECT

SITE PLAN

SCALE: AS SHOWN DRAWN: LR

HEET 2 OF 3

DATE: 09/29/22 PV-100