# COTATI VILLAGE COMMUNITY



2421 Fourth Street
Berkeley, California 94710
510.649.1414
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Cotati, CA

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JOB: **2304** 

SHEET:

TITLE SHEET

**A0** 

# | PROJECT DIRECTORY

OWNER/APPLICANT: 116 ASSOCIATED INVESTORS LLC 1101 FIFTH AVENUE, SUITE 300 SAN RAFAEL, CA 94901

N.T.S.

**VICINITY MAP** 

ARCHITECT:
TRACHTENBERG ARCHITECTS
2421 Fourth Street
Berkeley, CA 94710

CIVIL ENGINEER: MFKESSLER ONE VENTURE, SUITE 130 IRVINE, CA 92618

LANDSCAPE ARCHITECT: YAMASAKI LANDSCAPE ARCHITECTURE 1223 HIGH STREET AUBURN, CA 95603

SOILS ENGINEER: MILLER PACIFIC ENGINEERING GROUP 504 REDWOOD BLVD, SUITE 201 NOVATO, CA 95401

BIOLOGICAL CONSULTANT: MONK & ASSOCIATES 1136 SARANAP AVE WALNUT CREEK, CA 94595 Cotati Village is a mixed-use apartment development which features 176 rental units across six buildings with one additional Manager's Unit in Building B. There is also a 5,708 square foot clubhouse at the center with resident amenities and swimming pool. Eighteen of these units are intended to be rented as affordable units for families in the very low-income bracket at 50% of area median income. A portion of the ground floor spaces in Buildings A and C are Non-Residential, providing retail and office space to establish the commercial character of the Gravenstein frontage as planned in the Cotati General Plan.

PROJECT DESCRIPTION

The density of the site is based on CG - Gravenstein Corridor zoning which gives a maximum of 15 dwelling units per acre. The site is 7.82 acres which brings the total to 117.3 dwelling units. By providing 15% of the Very-Low Income households (18 units total), the development triggers a California state density bonus of 50% to reach the 176 total units plus one Manager's Unit. The State Code also states that the development holds up to three concessions to Cotati Municipal

The development respects all the easements and setbacks from the original masterplan, adapting the the City of Cotati's new goals for the Gravenstein Corridor Zone, and the updated density bonuses for affordable housing from the California State Code. The site plan complies with all City of Cotati General Plan requirements.

The site is currently a large field, and the masterplan aims to maintain maximum open space, including a park in the flag parcel for nearby residents, and a large central open space. The non-residential units along Gravenstein Highway feature a storefront style which opens onto a pedestrian plaza, with the rest of the buildings featuring a modern craftsman style to fit in with the character of the surrounding neighborhoods and the City of Cotati at large.

# **DRAWING LIST**

HITECTURAL

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A1 ZONING COMPLIANCE & CALCULATIONS
A2 NEIGHBORHOOD CONTEXT MAP

A3 CONTEXT PHOTOS
A5 MASTER PLAN
A6 RENDER VIEWS

A7 RENDER VIEWS

A8 RENDER VIEWS
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A10 SITE PLAN - NORTH

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A21 BUILDING D PLANS
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A37 USABLE OPEN SPACE EXHIBIT
A38 FENCE DETAILS & WINDOW INFO
MAT MATERIAL BOARD

LANDSCAPE
L1 PRELIMINARY LANDSCAPE PLAN

L2 PRELIMINARY LANDSCAPE PLAN - NORTH
L3 PRELIMINARY LANDSCAPE NOTES

C-0 CIVIL TITLE SHEET AND DETAILS

C-3 EASEMENTS EXHIBITS

C-6 PRELIMINARY UTILITY PLAN

C-1 EXISTING TOPOGRAPHY AND DEMOLITION PLAN


C-4 PRELIMINARY GRADING AND DRAINAGE PLAN

C-2 PRELIMINARY SITE PLAN / FIRE ACCESS & HYDRANT PLAN

C-5 PRELIMINARY WATER QUALITY / EROSION & SETTLEMENT PLAN

L4 CALCULATIONS AND LIGHTING DETAILS

ENOTES
TING DETAILS

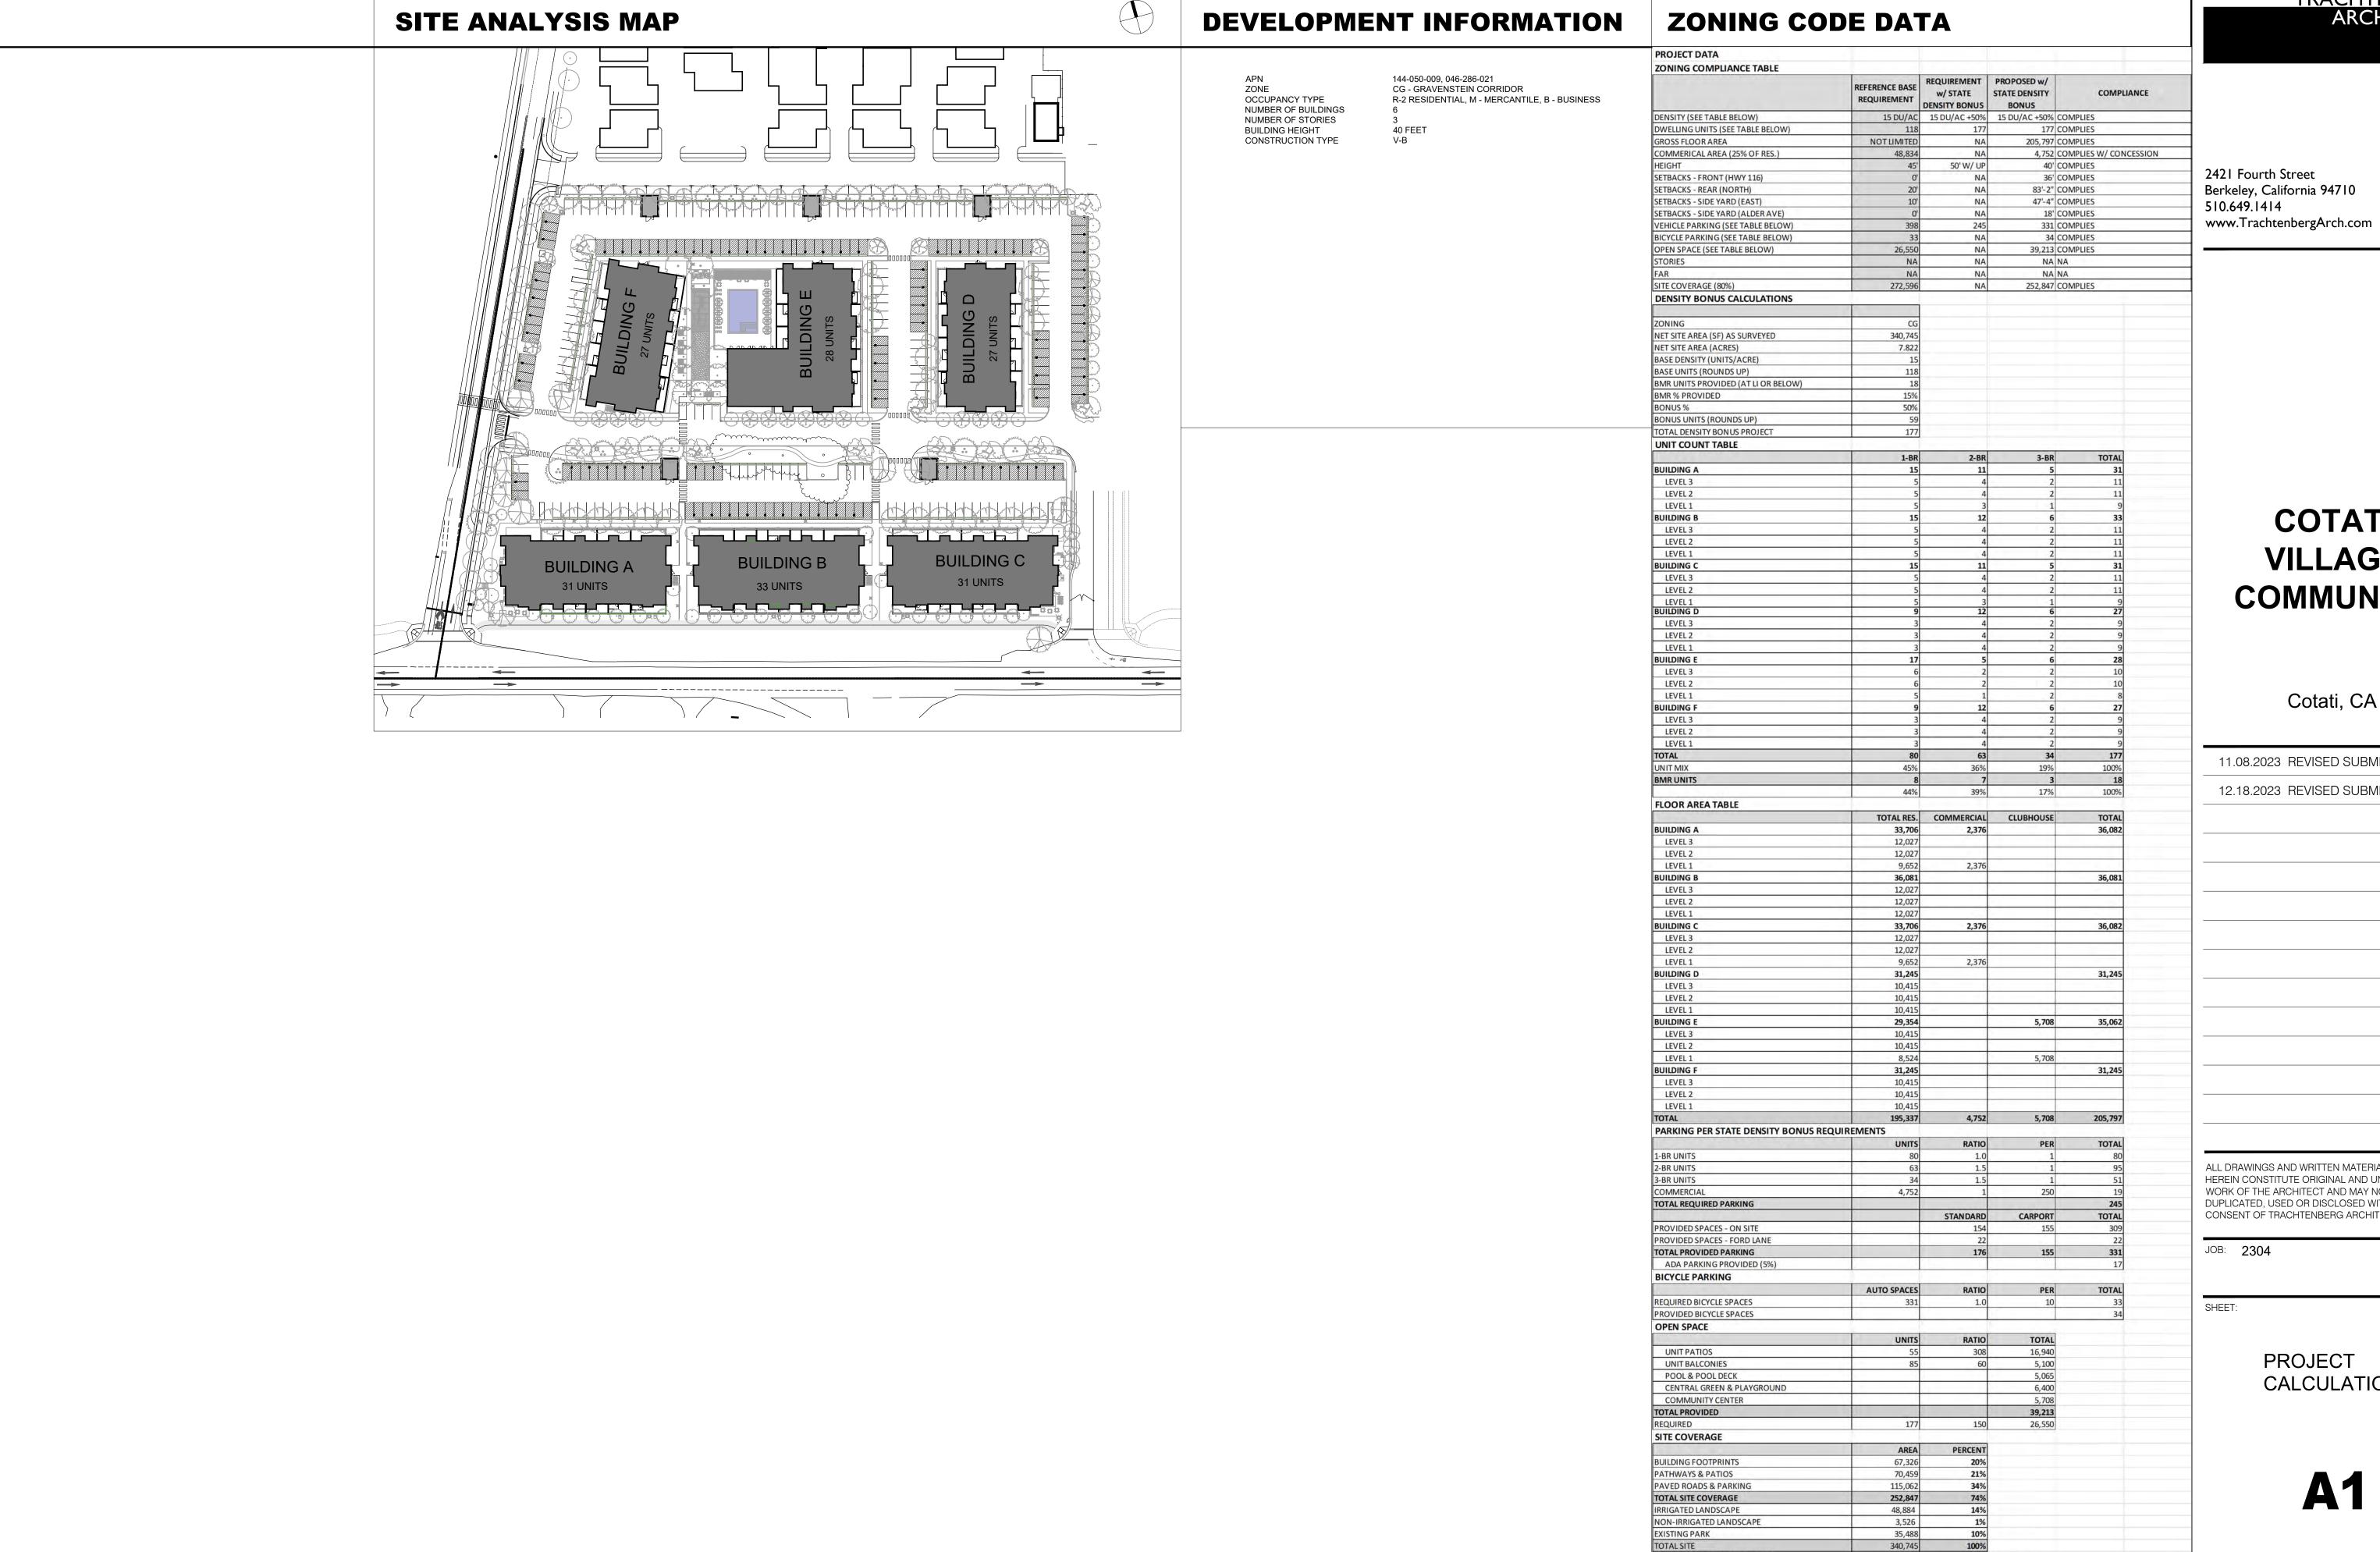

# TRACHTENBERG ARCHITECTS

# COTATI **VILLAGE** COMMUNITY

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**CALCULATIONS** 

MAX ALLOWED SITE COVERAGE

272,596



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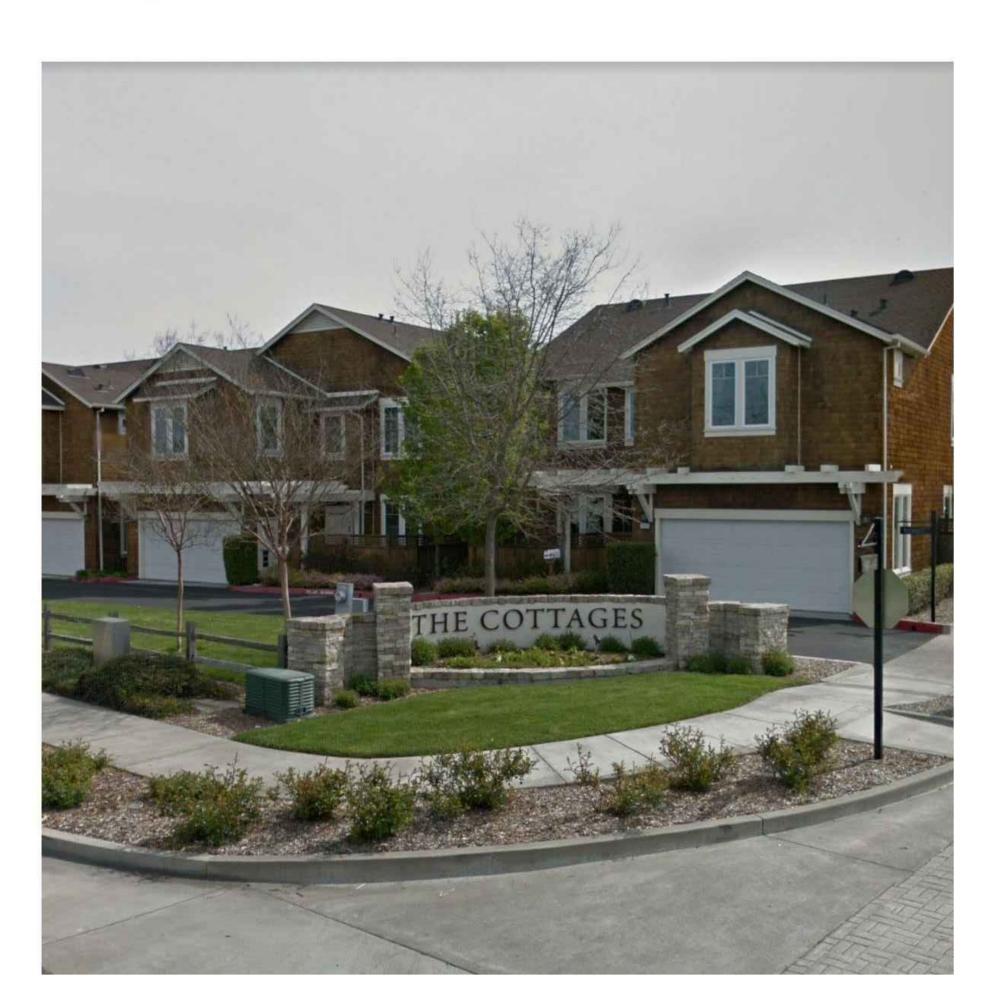
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SHEET

NEIGHBORHOOD CONTEXT MAP



1. PHOTO PLAN



3. COTATI COTTAGES



2. VIEW FROM GRAVENSTEIN HIGHWAY



4. VIEW FROM ALDER AVENUE

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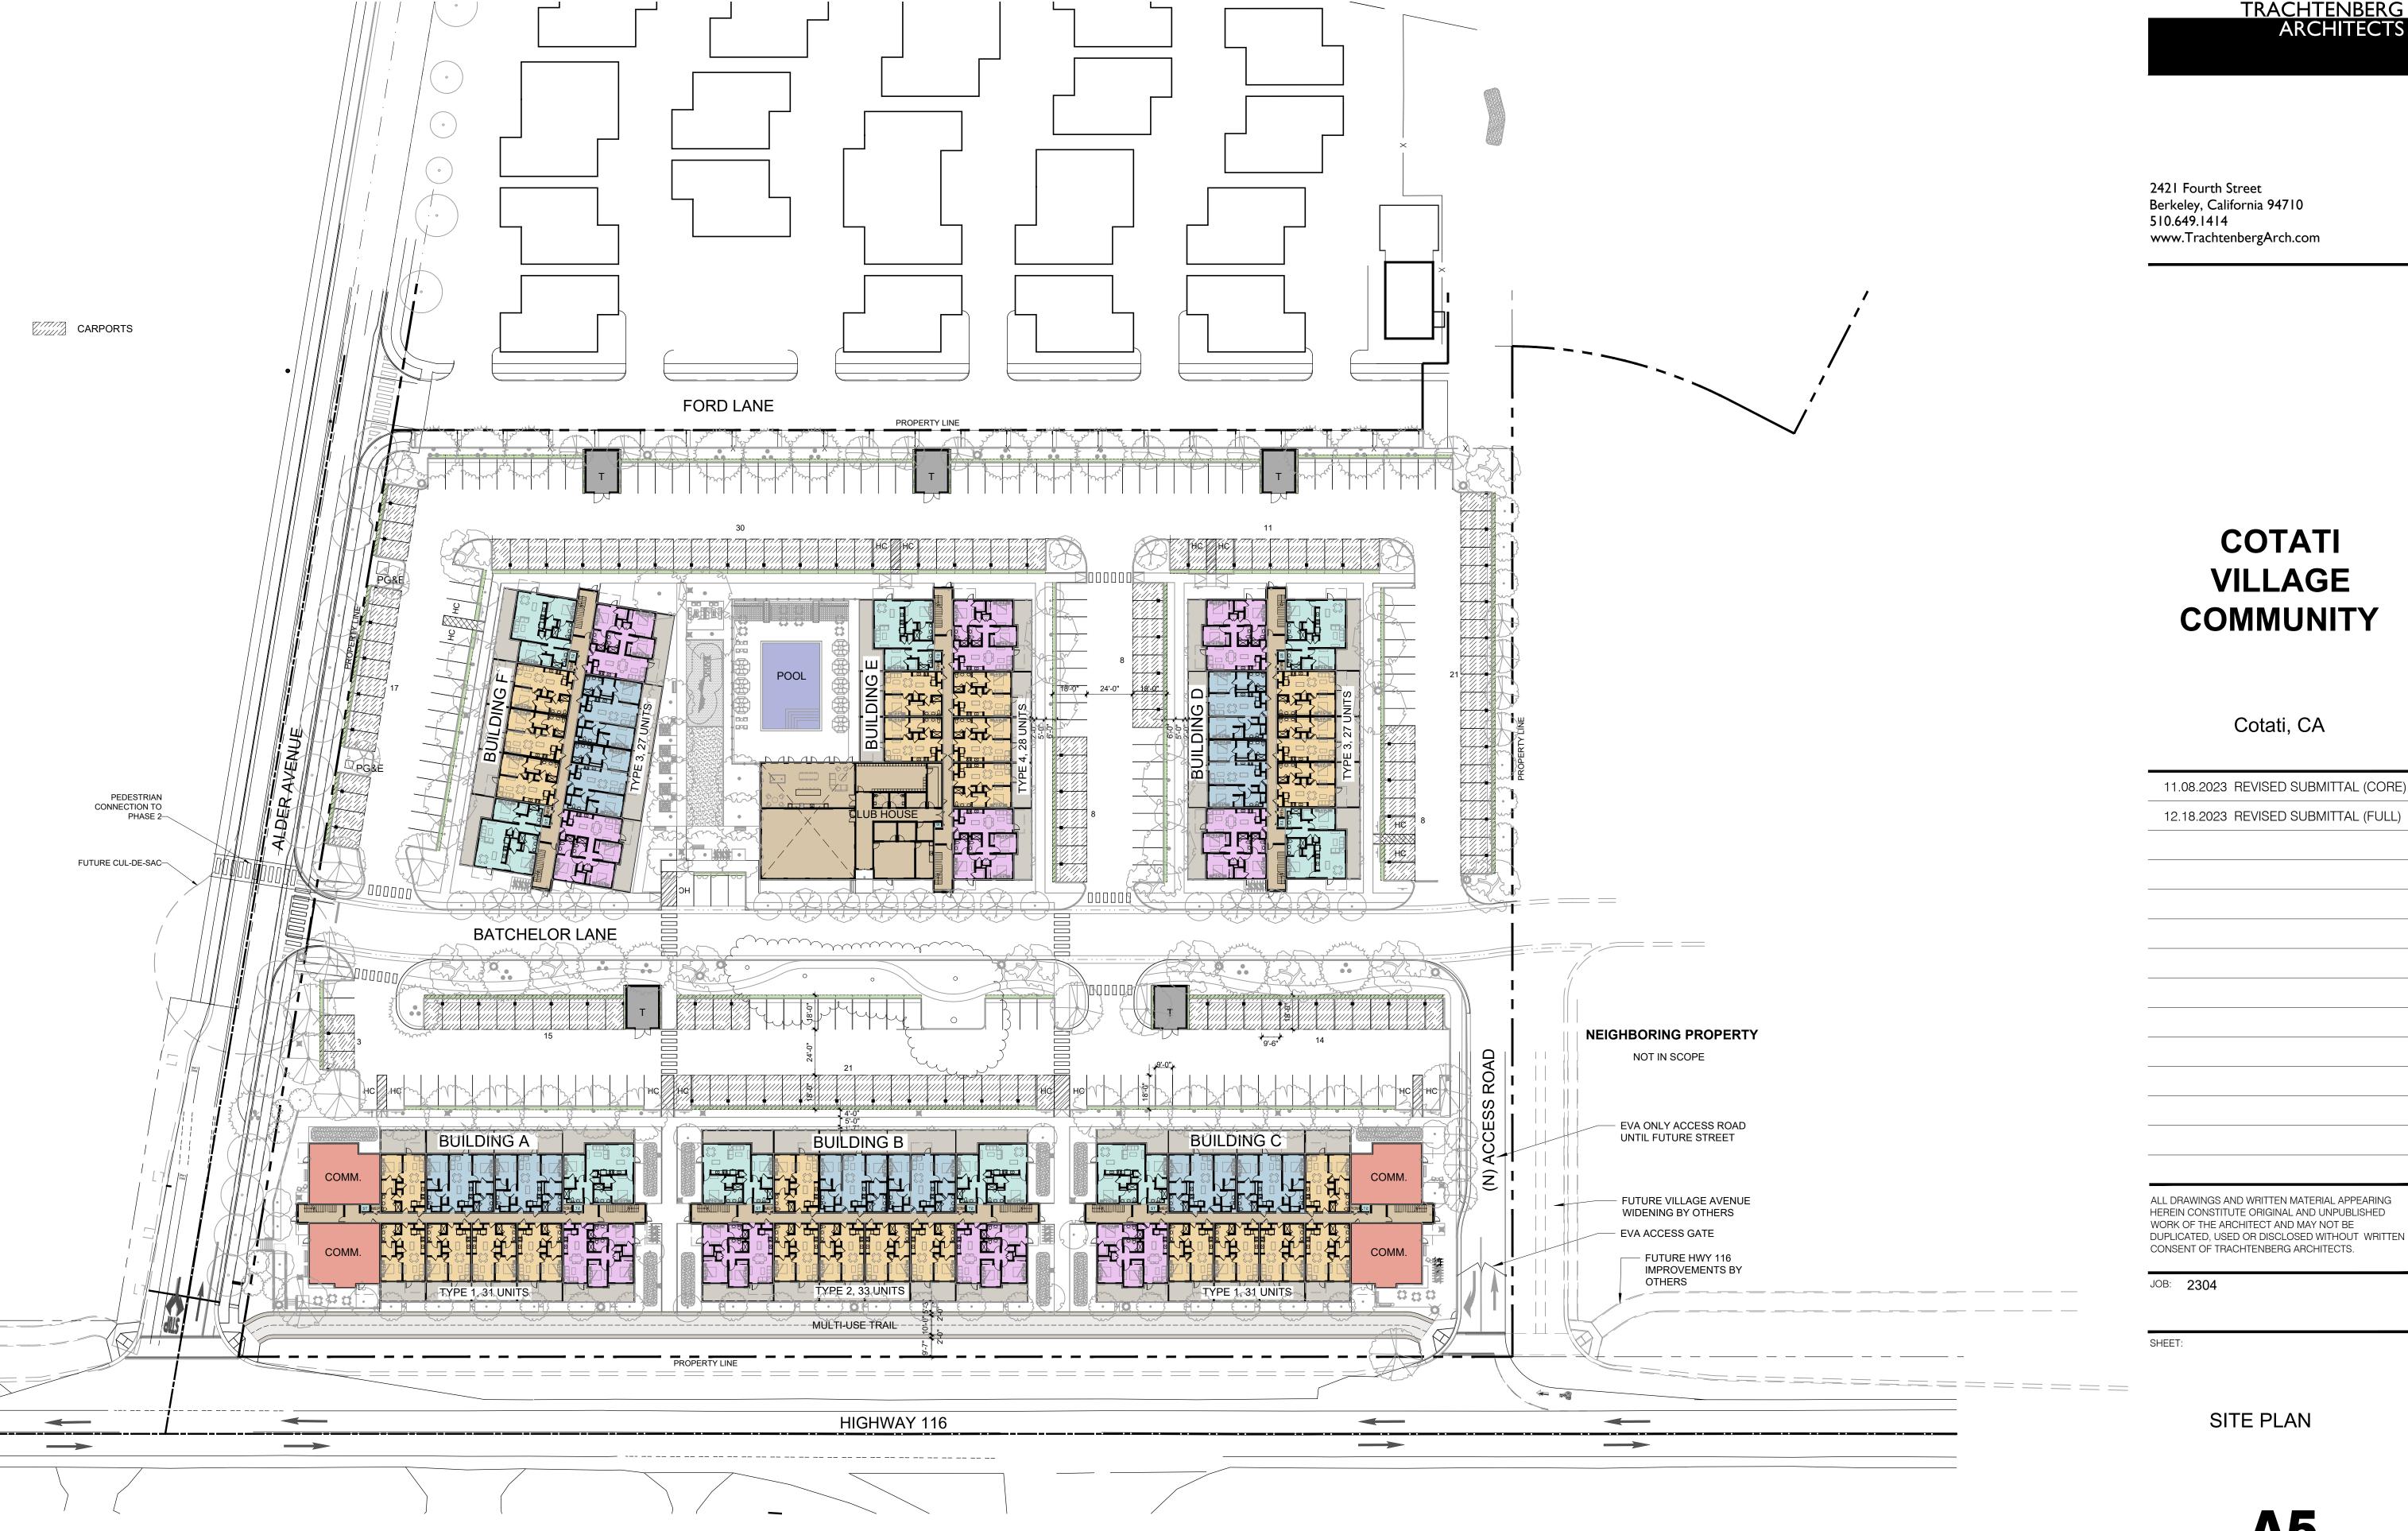
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CONTEXT PHOTOS







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SHEET:

RENDER VIEWS

**A6** 



2 EXTERIOR VIEW OF BUILDING C ALONG GRAVENSTEIN HWY



EXTERIOR VIEW OF BUILDING F AT CENTRAL GREEN SPACE



# EXTERIOR VIEW OF BUILDING A COMMERCIAL CORNER

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SHE

RENDER VIEWS

Δ7



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RENDER VIEWS


**A8** 




1 CLUB HOUSE FROM BACHELOR LANE




2 CUMMUNITY POOL DECK

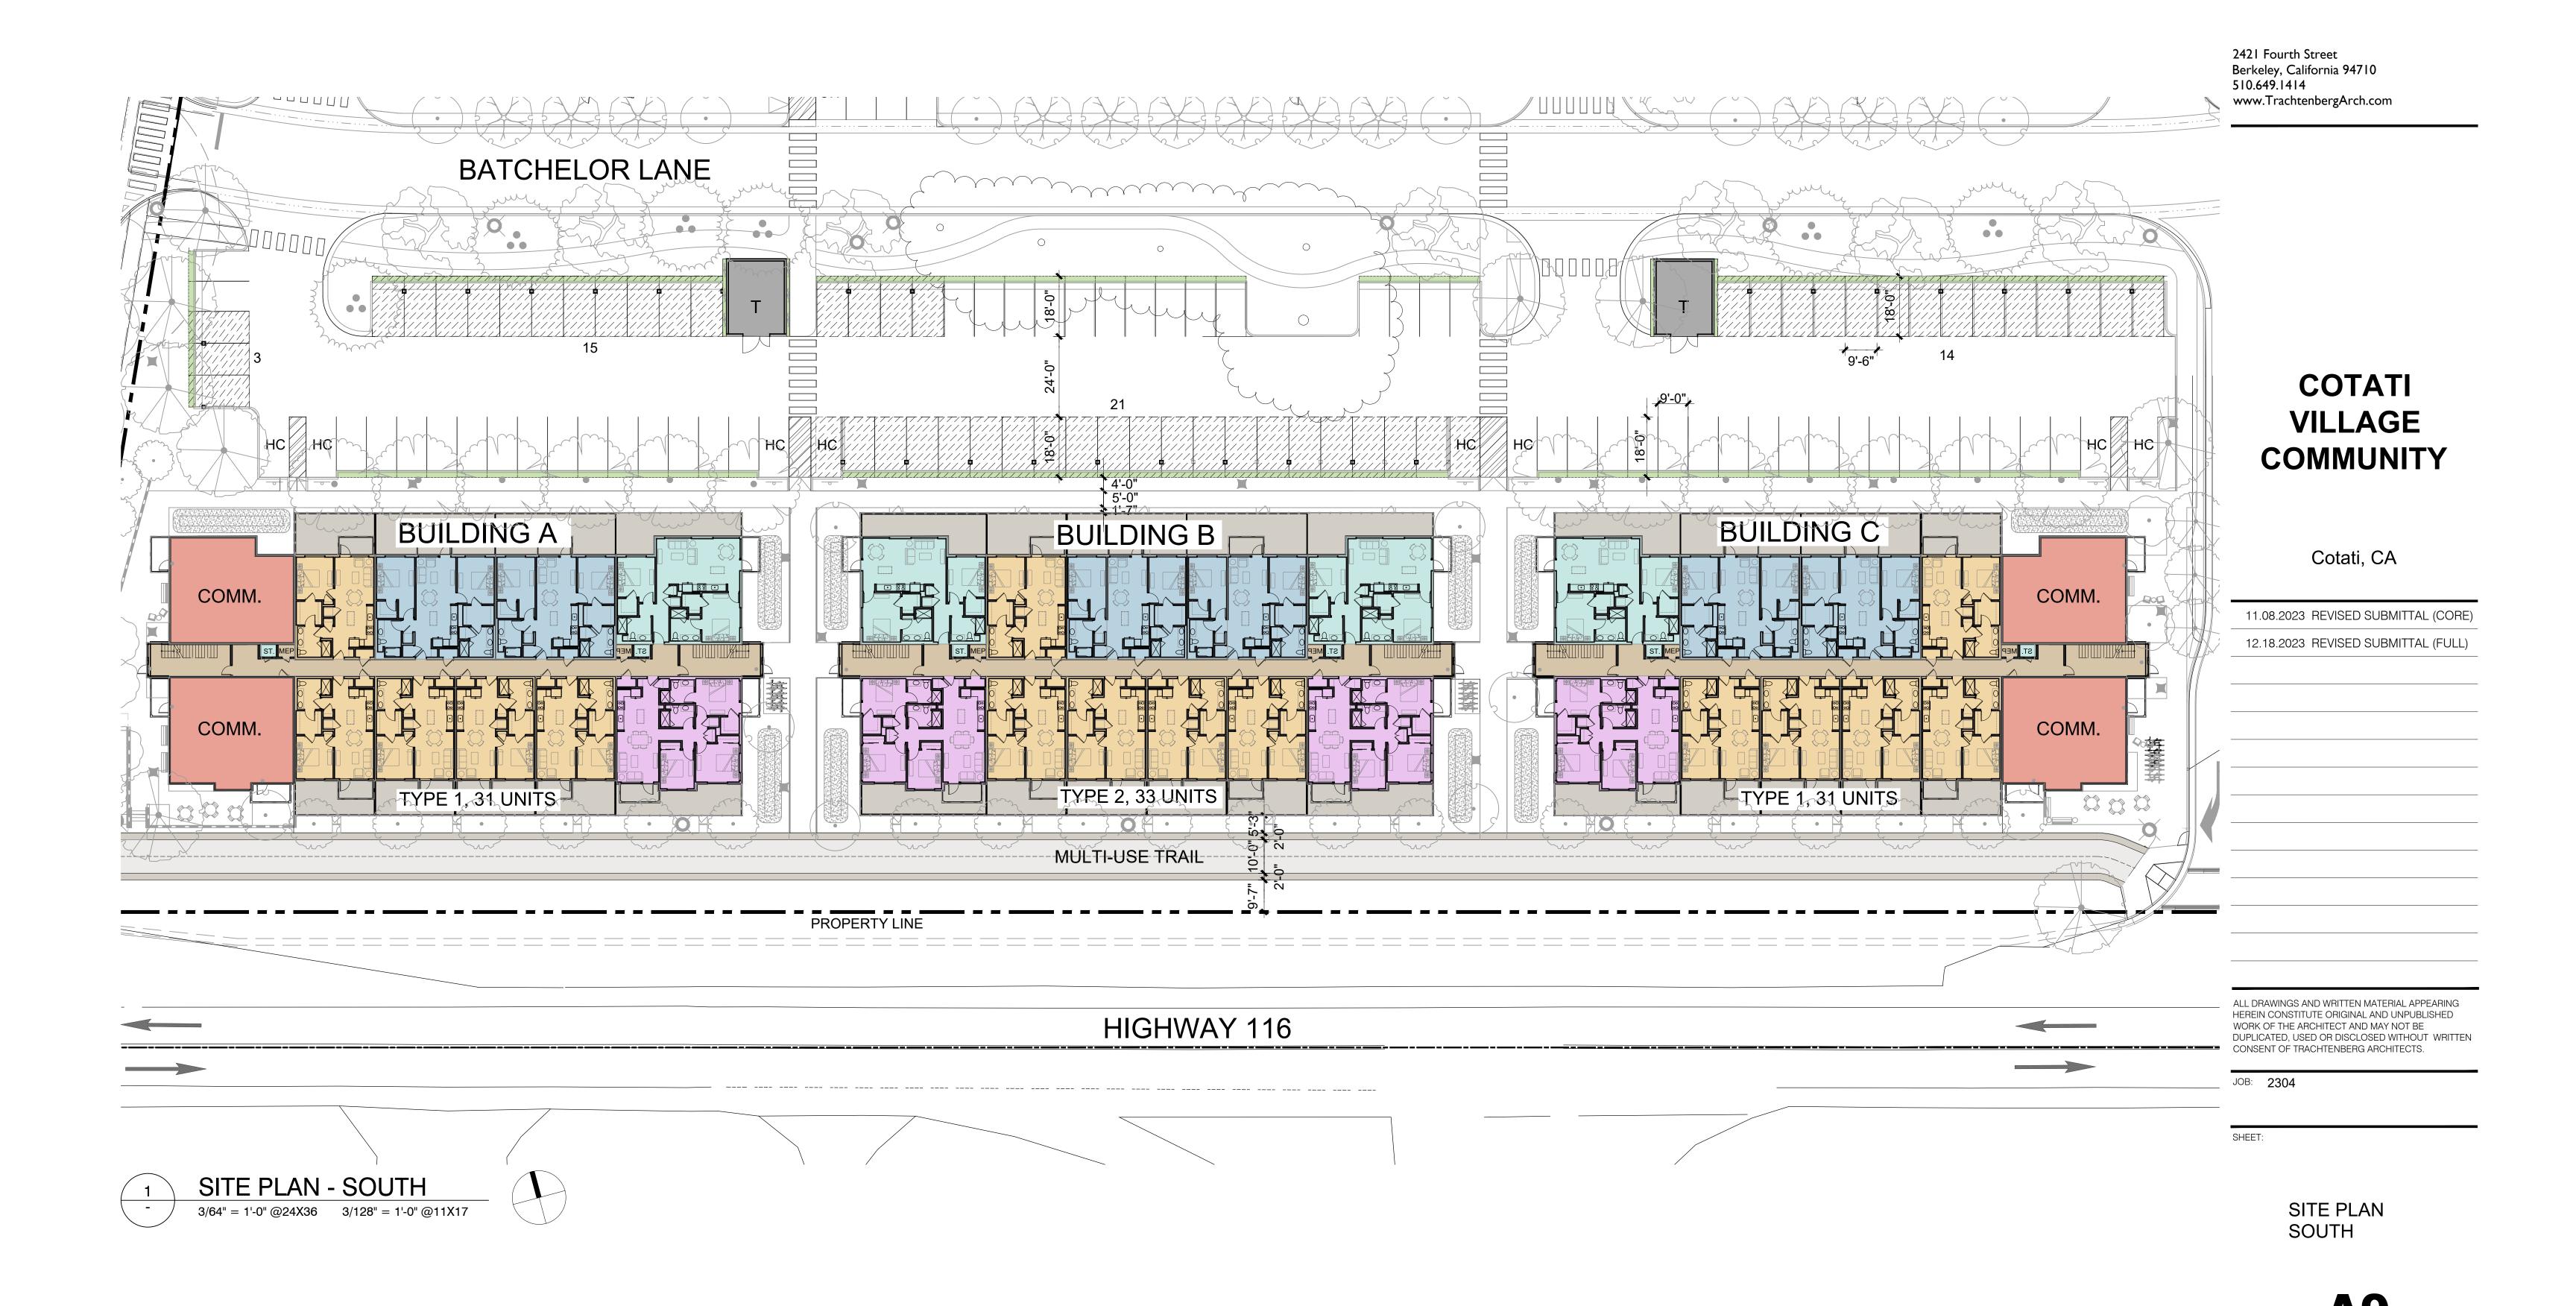

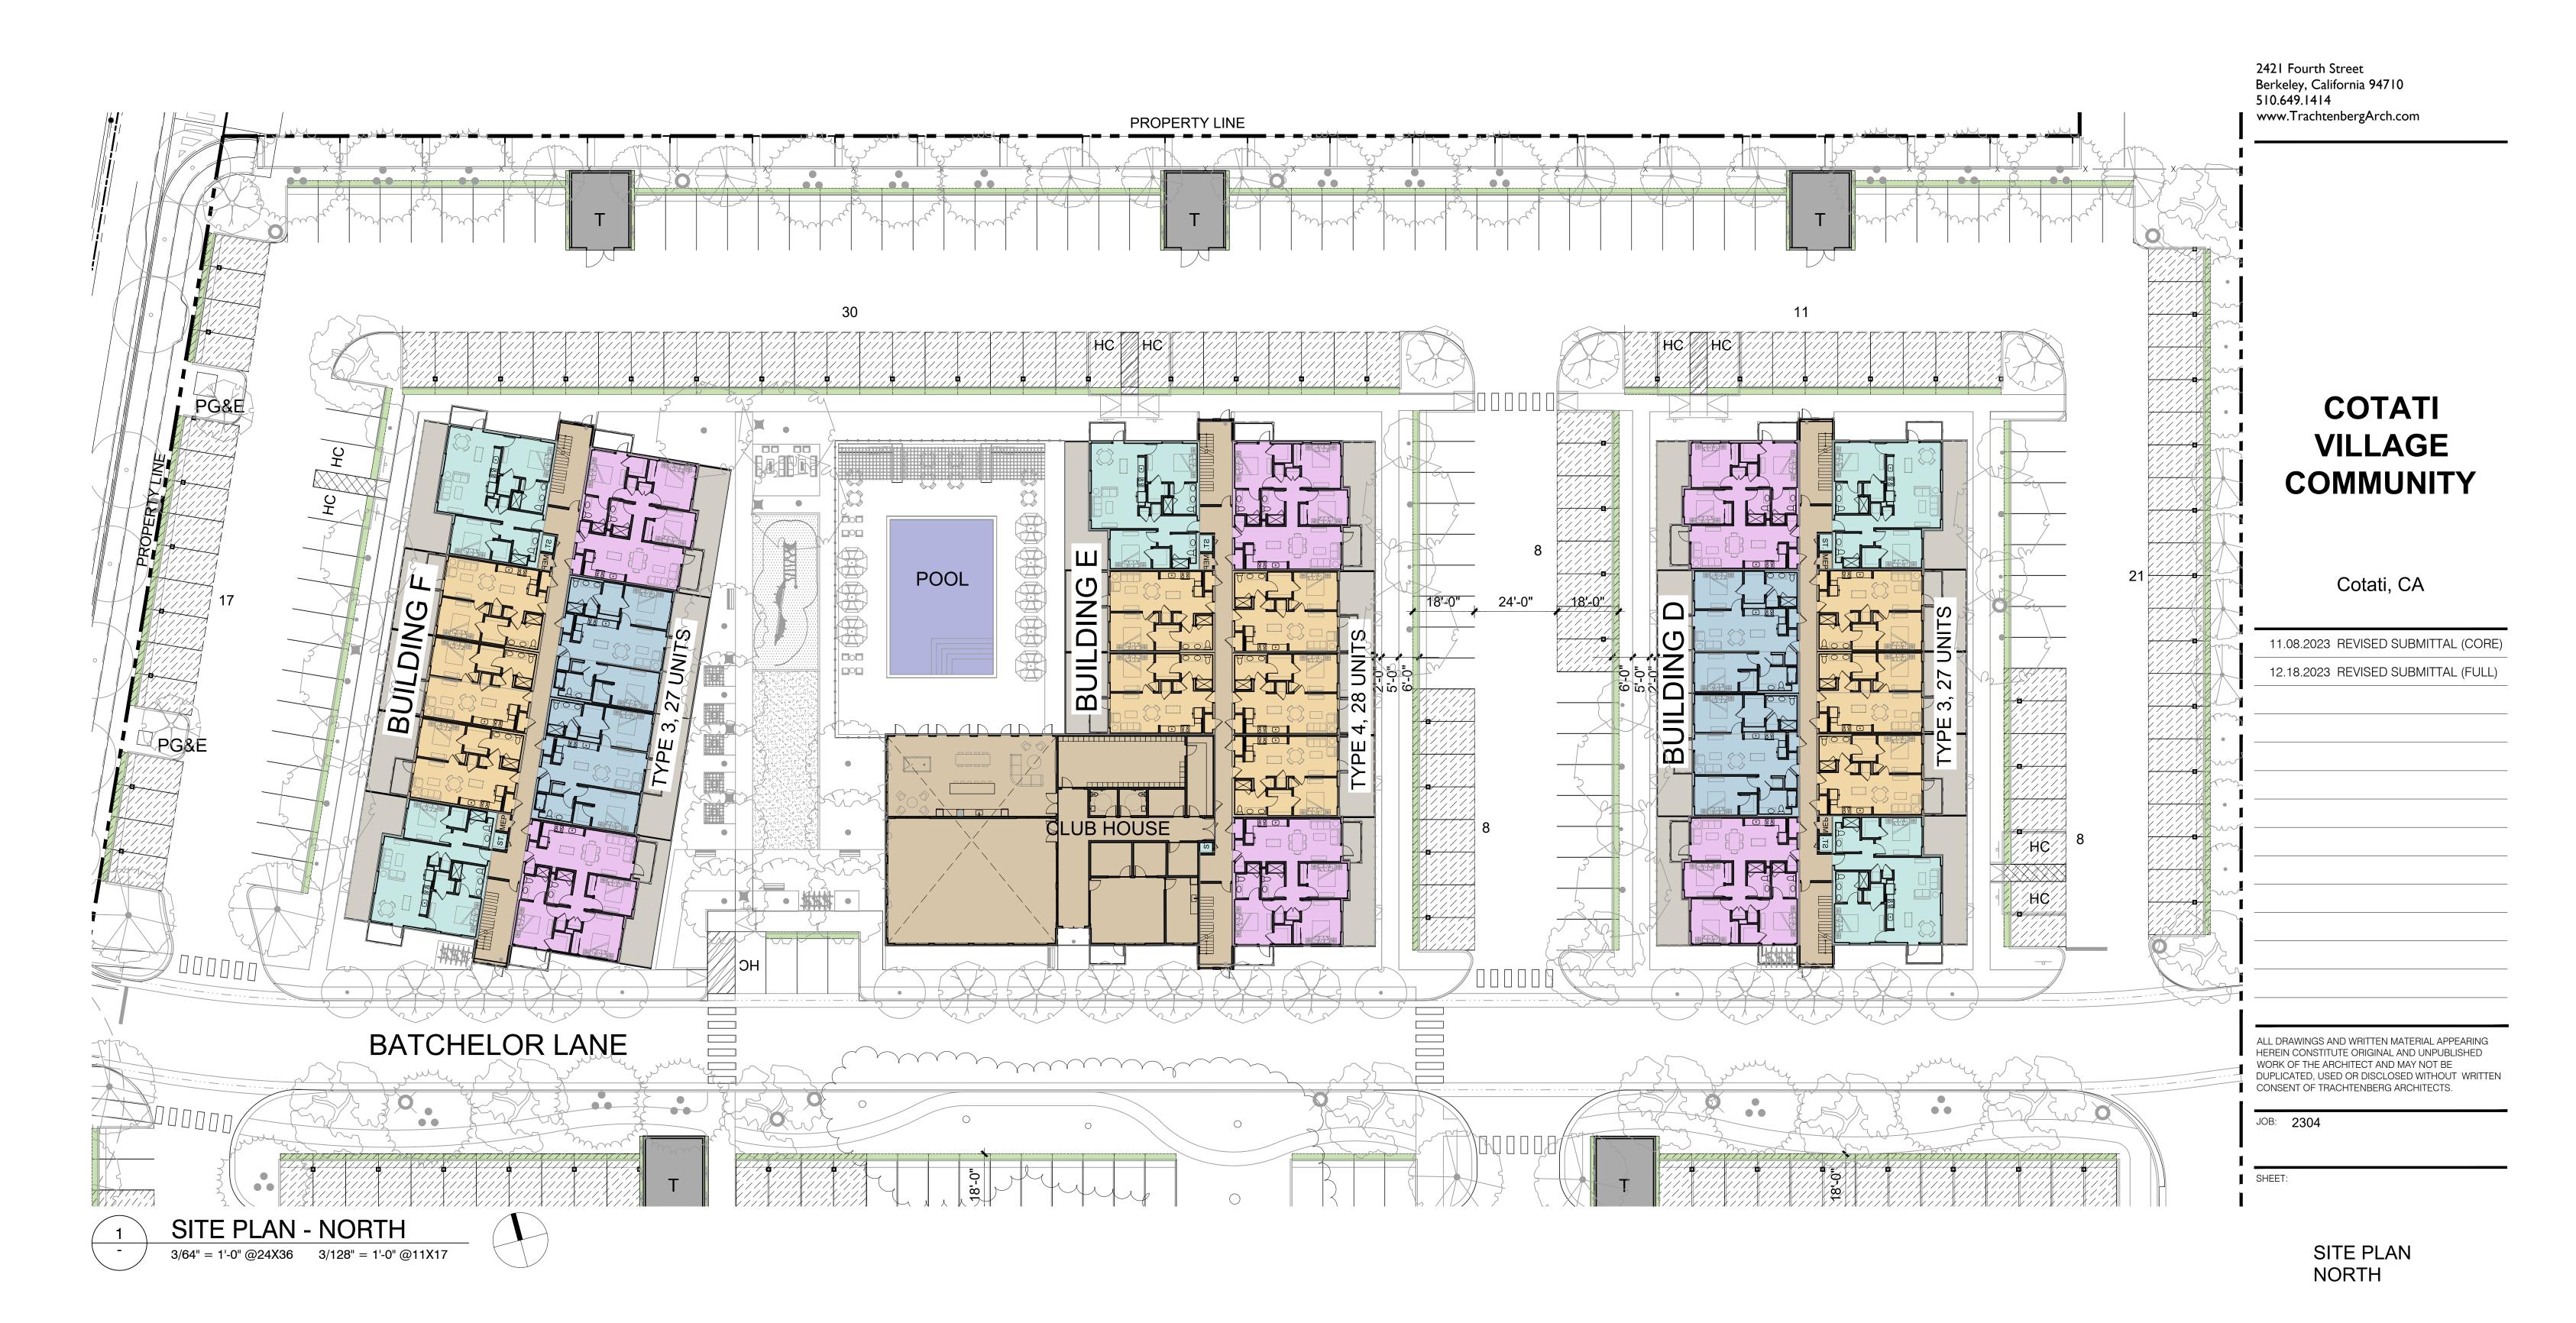



# TRACHTENBERG ARCHITECTS

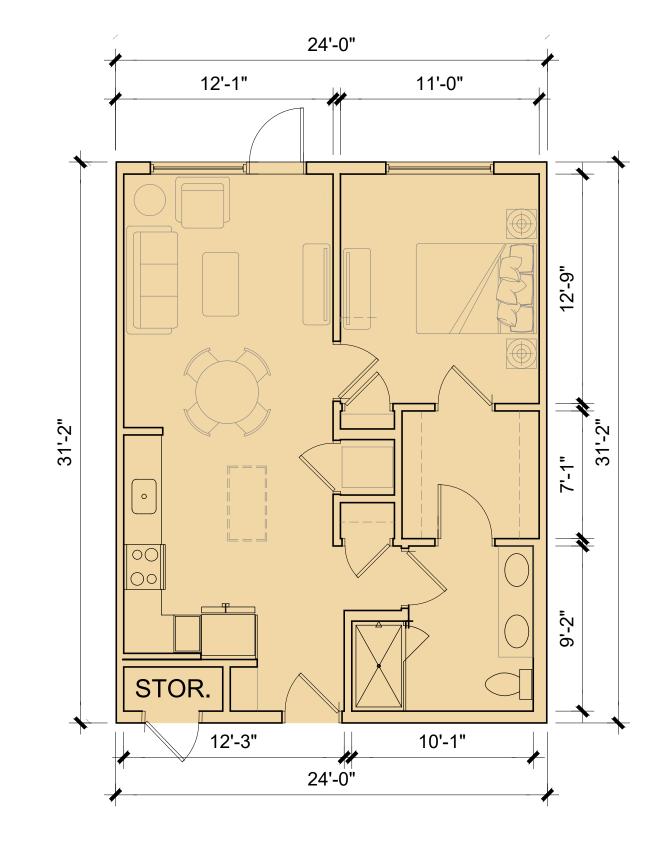

1 UNIT TYPE A1


- 3/16" = 1'-0" @24X36 3/32" = 1'-0" @11X17

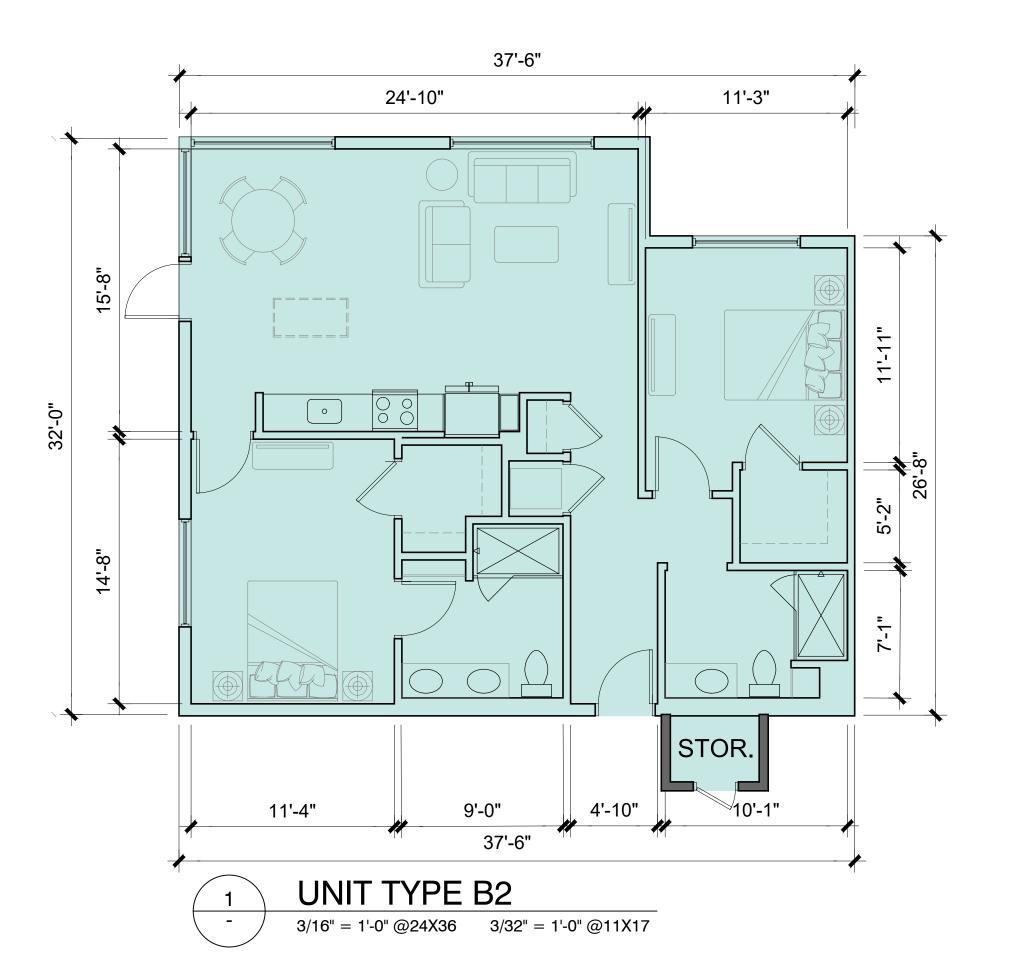

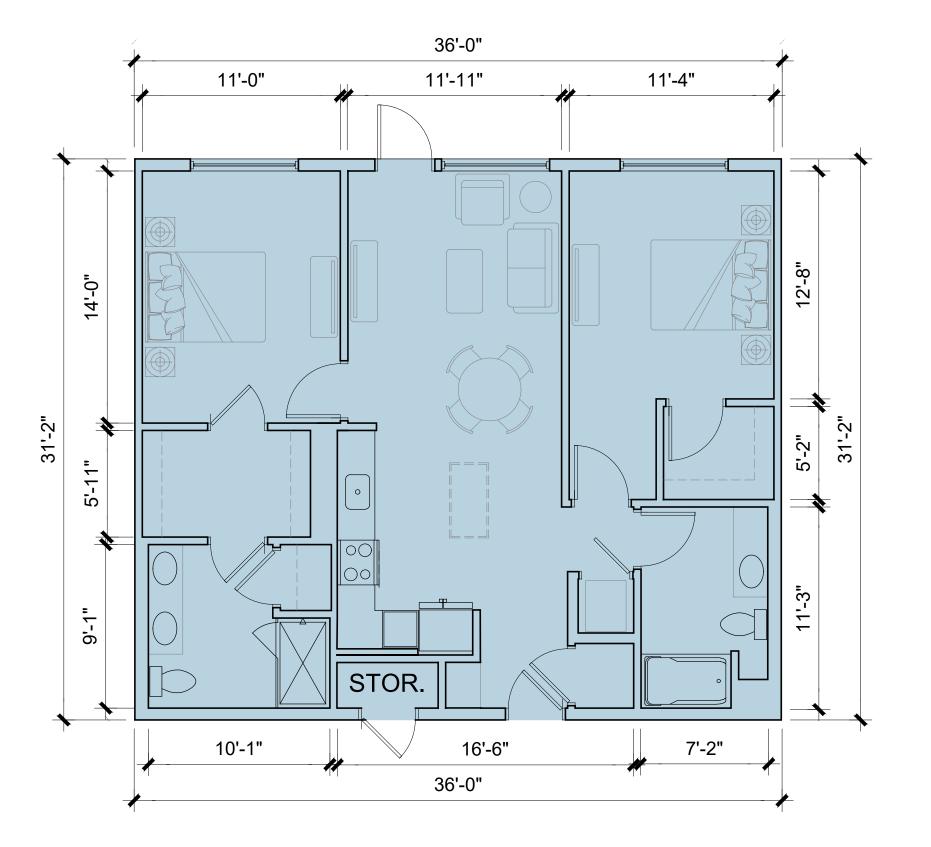

1 UNIT TYPE B1

- 3/16" = 1'-0" @24X36 3/32" = 1'-0" @11X17

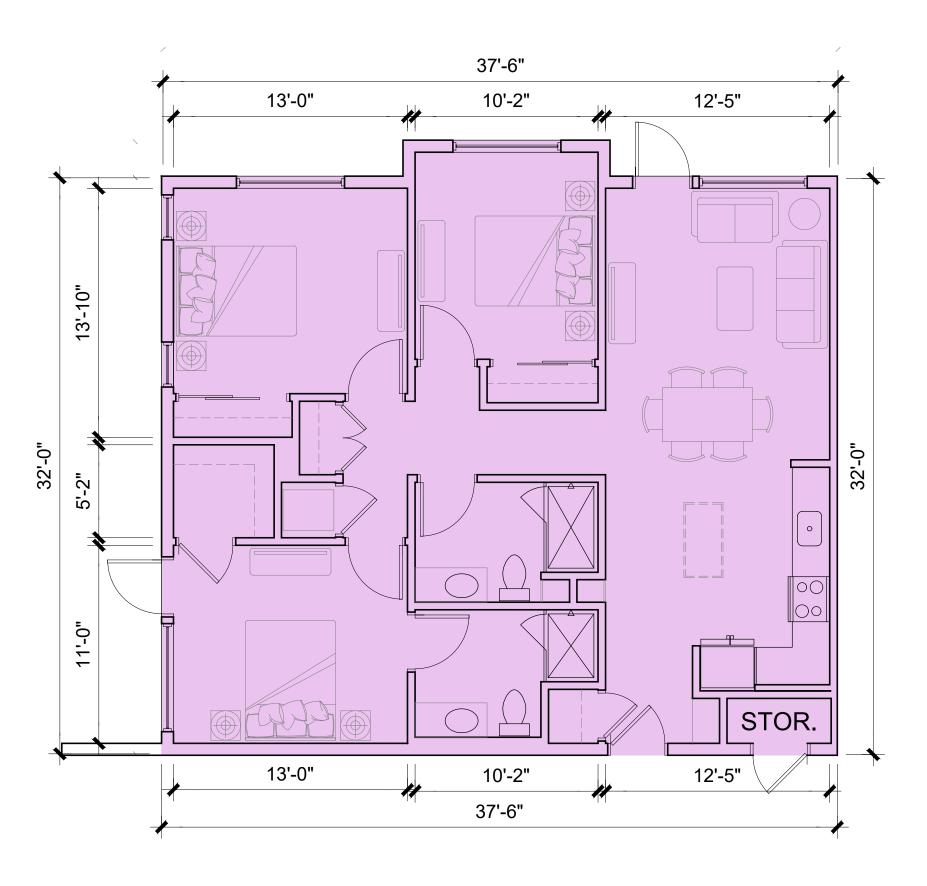

1 UNIT TYPE C1

- 3/16" = 1'-0" @24X36 3/32" = 1'-0" @11X17

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TYPICAL UNIT TYPES



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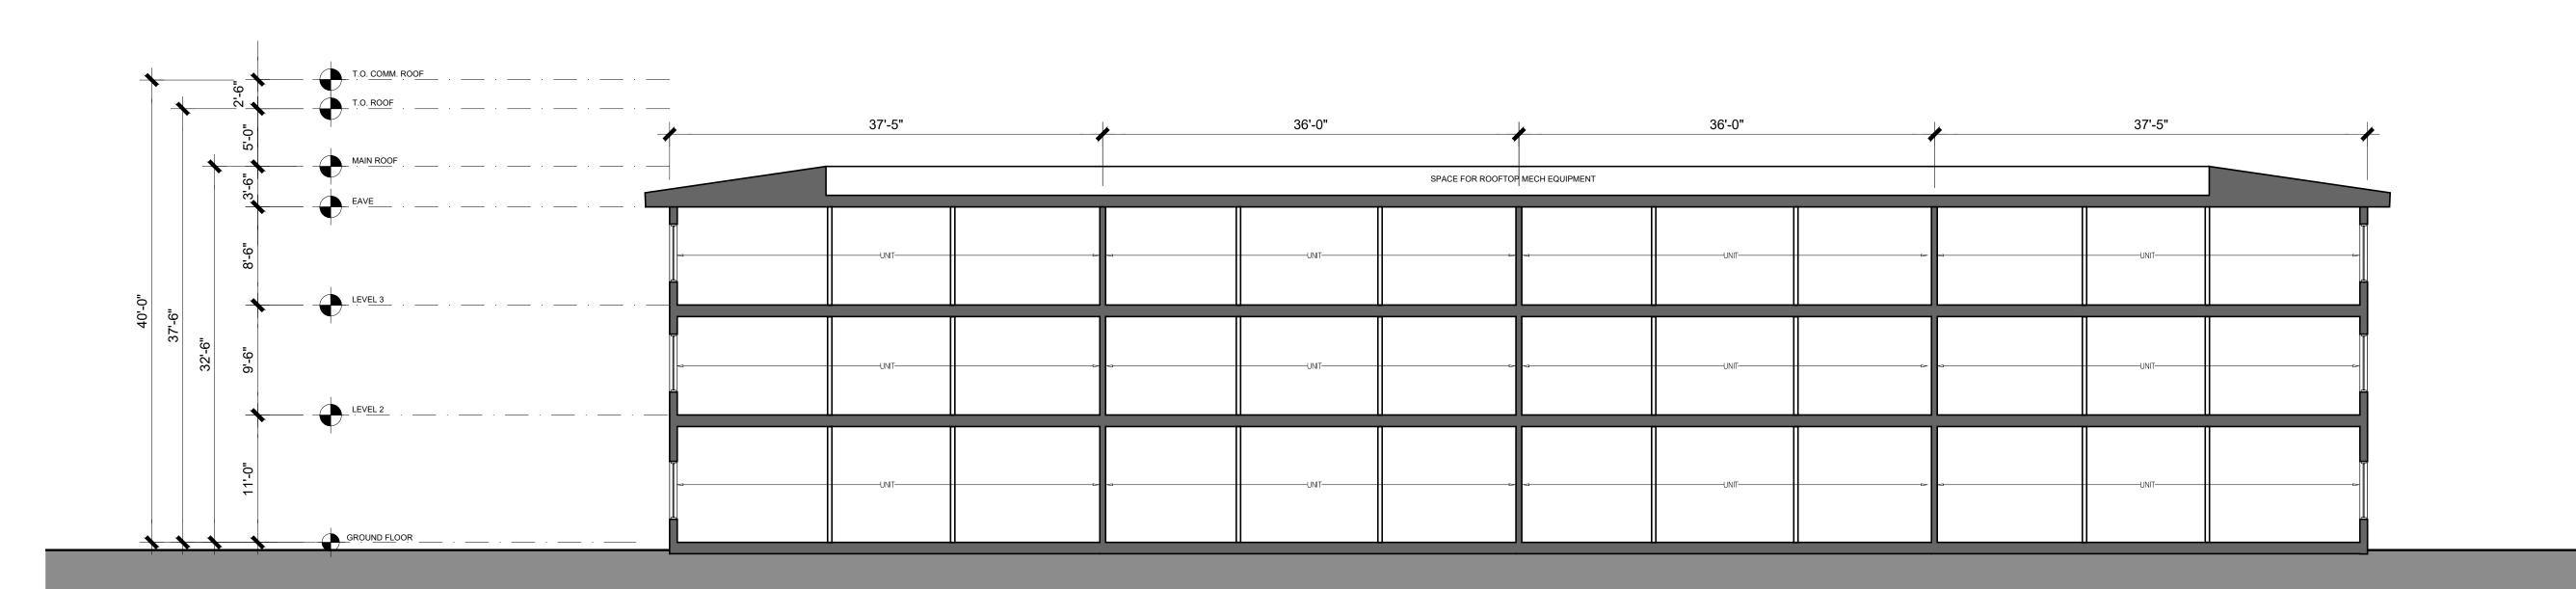
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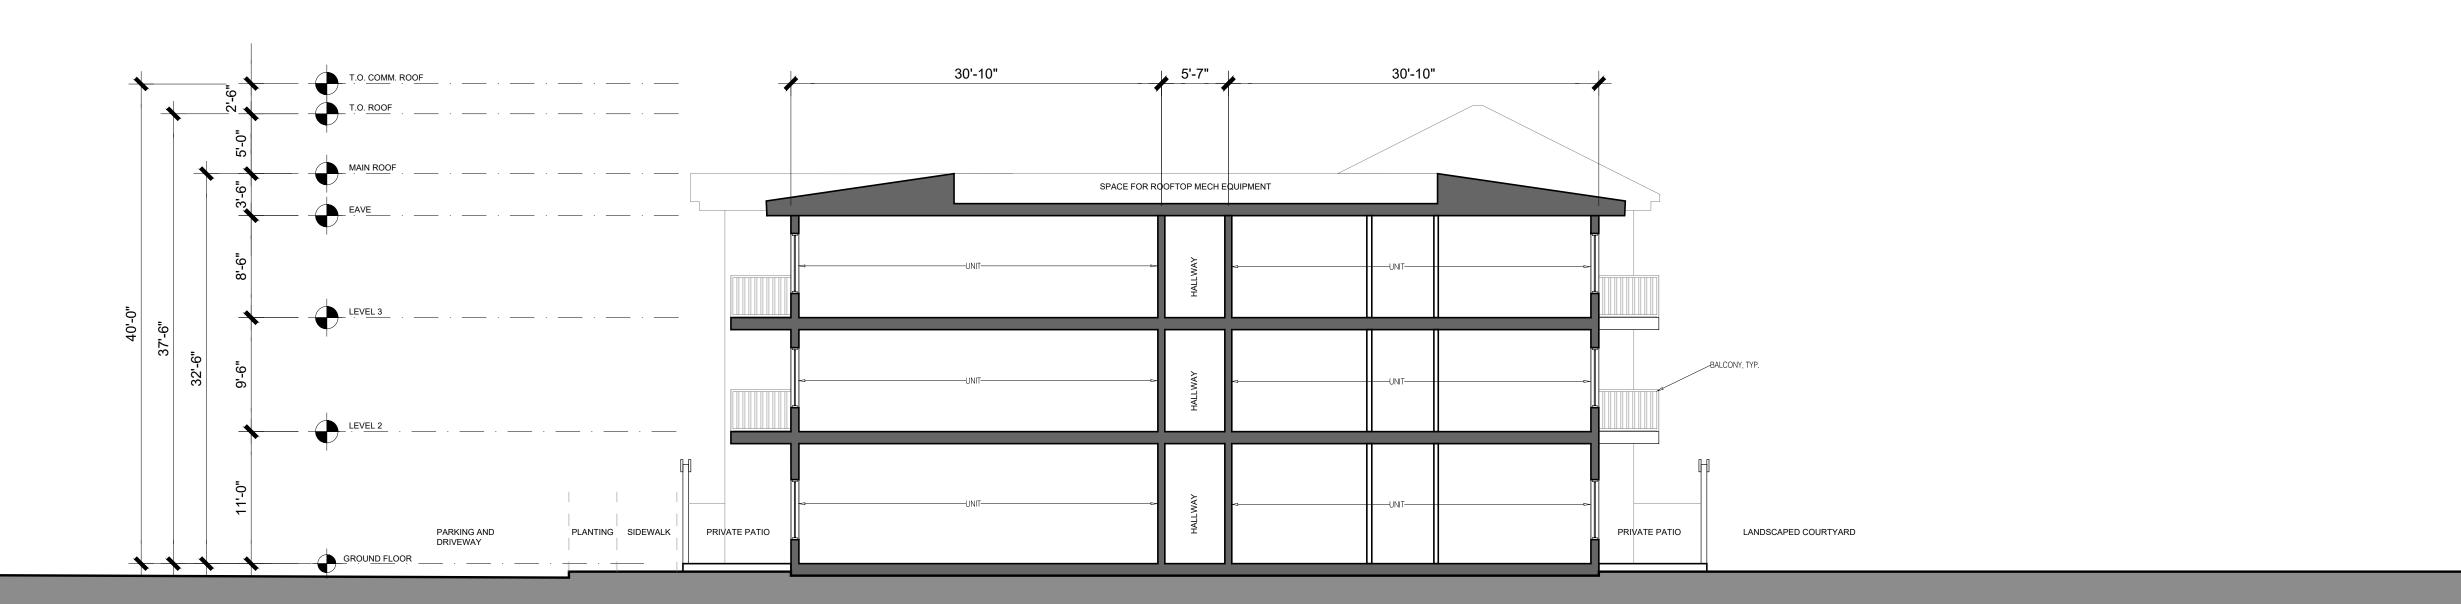
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TYPICAL SECTIONS

**A14** 





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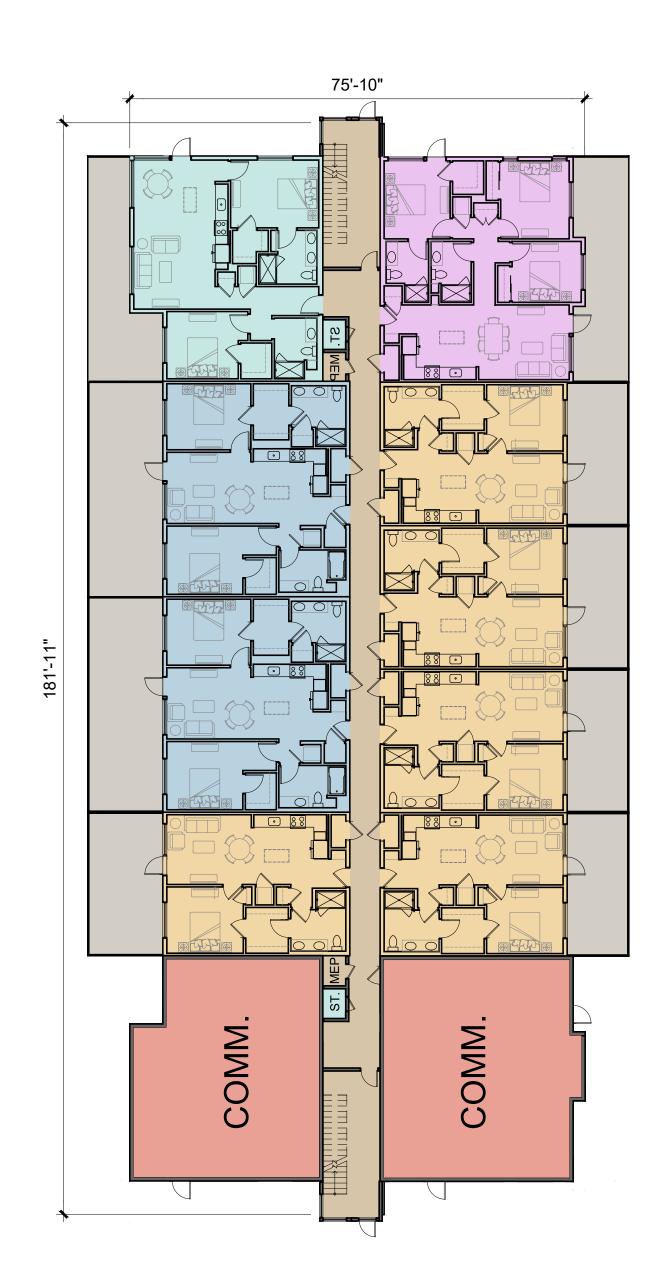








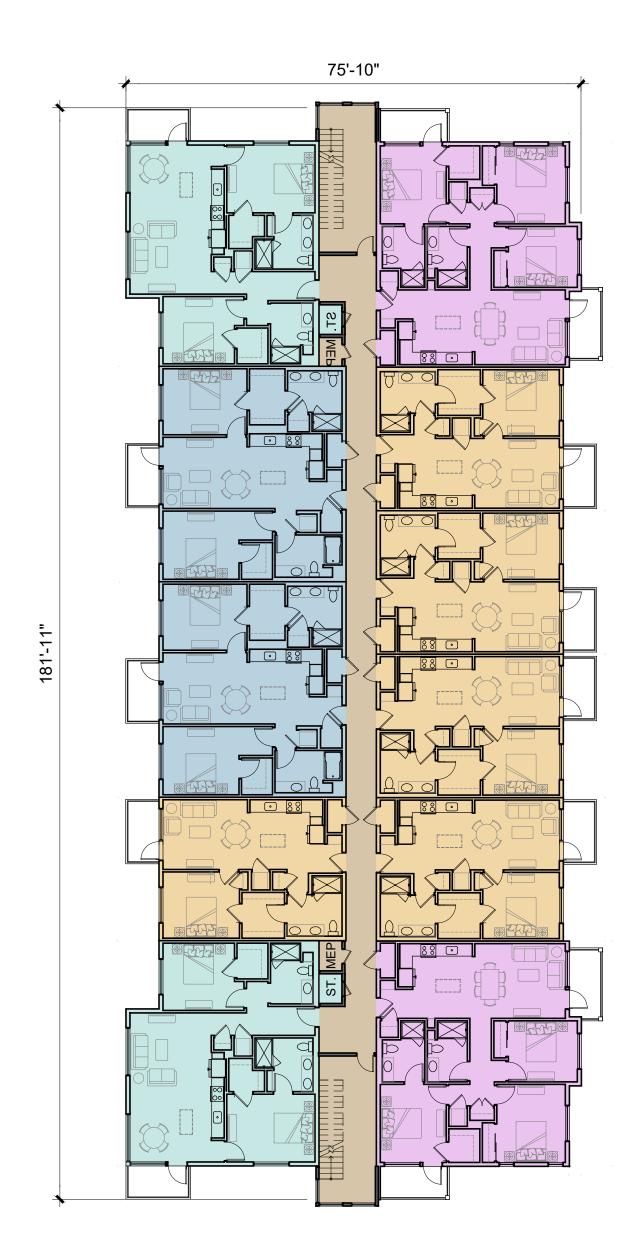

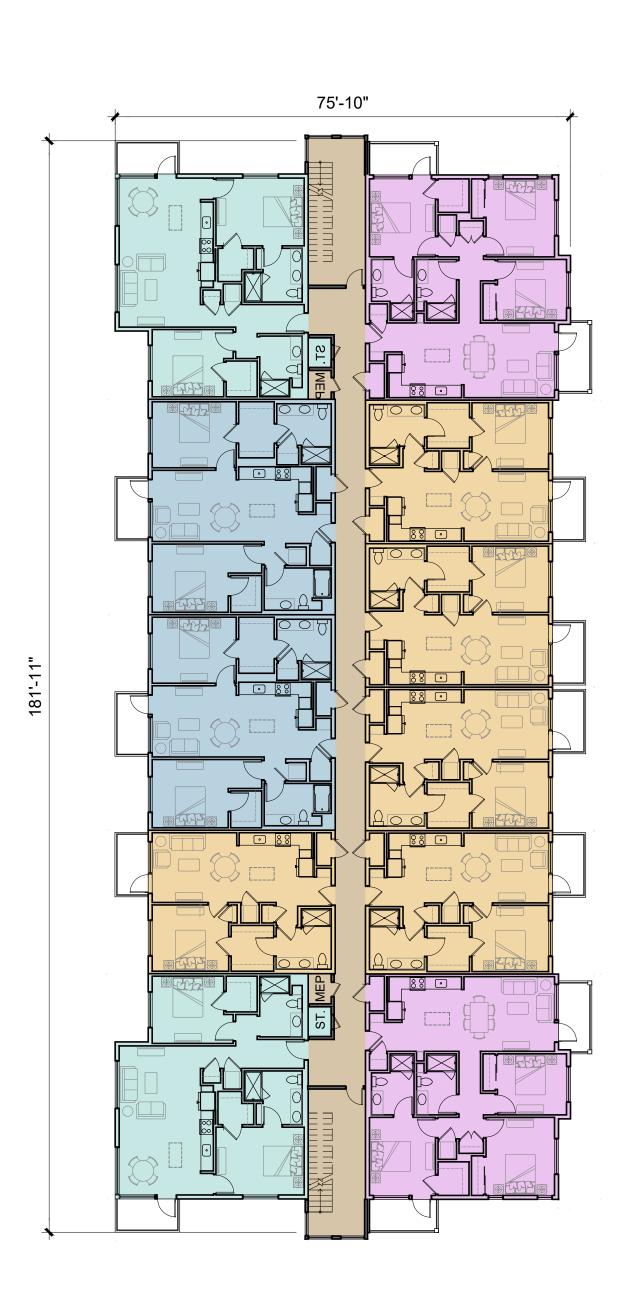

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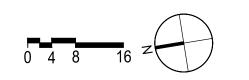
SHEE

BUILDING A PLANS











T.O. COMM. ROOF

T.O. ROOF

MAIN ROOF

EAVE

LEVEL 3

LEVEL 3

# 1 BUILDING A - EAST ELEVATION 3/64"=1'-0" @ 11X17 3/32" = 1'-0" @ 24X36

2 BUILDING A - WEST ELEVATION

- 3/64"=1'-0" @ 11X17 3/32" = 1'-0" @ 24X36



# BUILDING A - SOUTH ELEVATION 3/64"=1'-0" @ 11X17 3/32" = 1'-0" @ 24X36

TO PODE

WAN ROOF

SAVE


LEVEL 3

SECURIO TICORA

SAROUND TICORA

4 BUILDING A - NORTH ELEVATION

3/64"=1'-0" @ 11X17 3/32" = 1'-0" @ 24X36

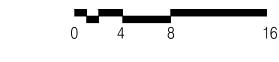

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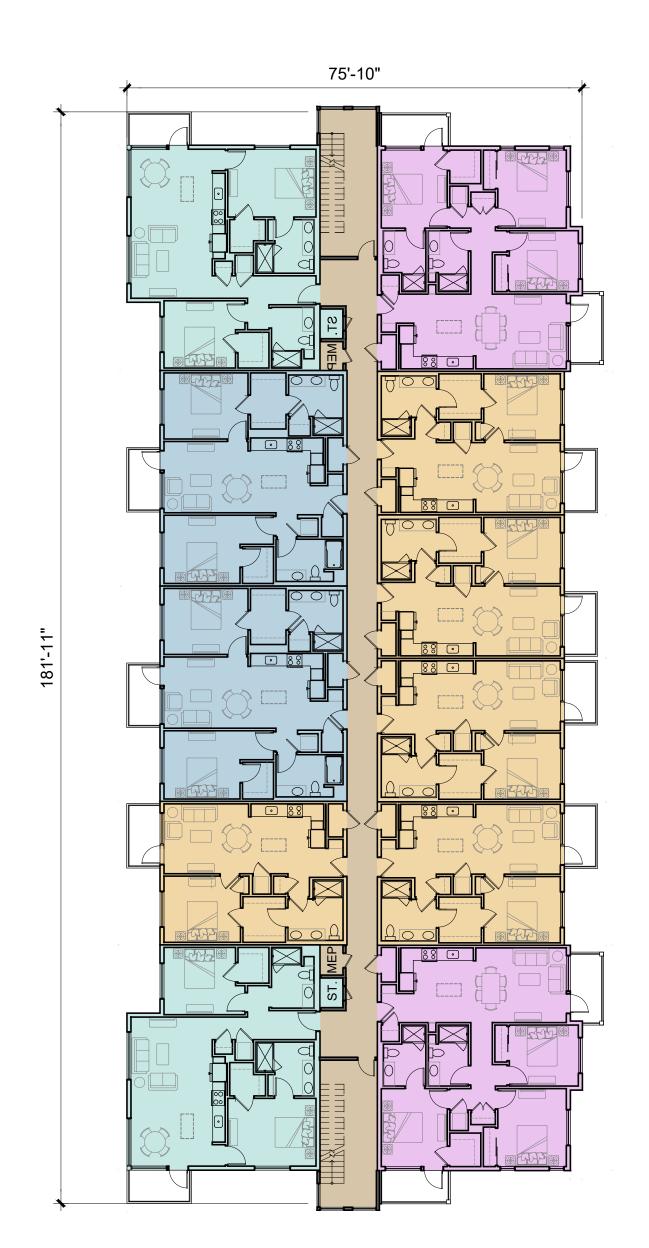
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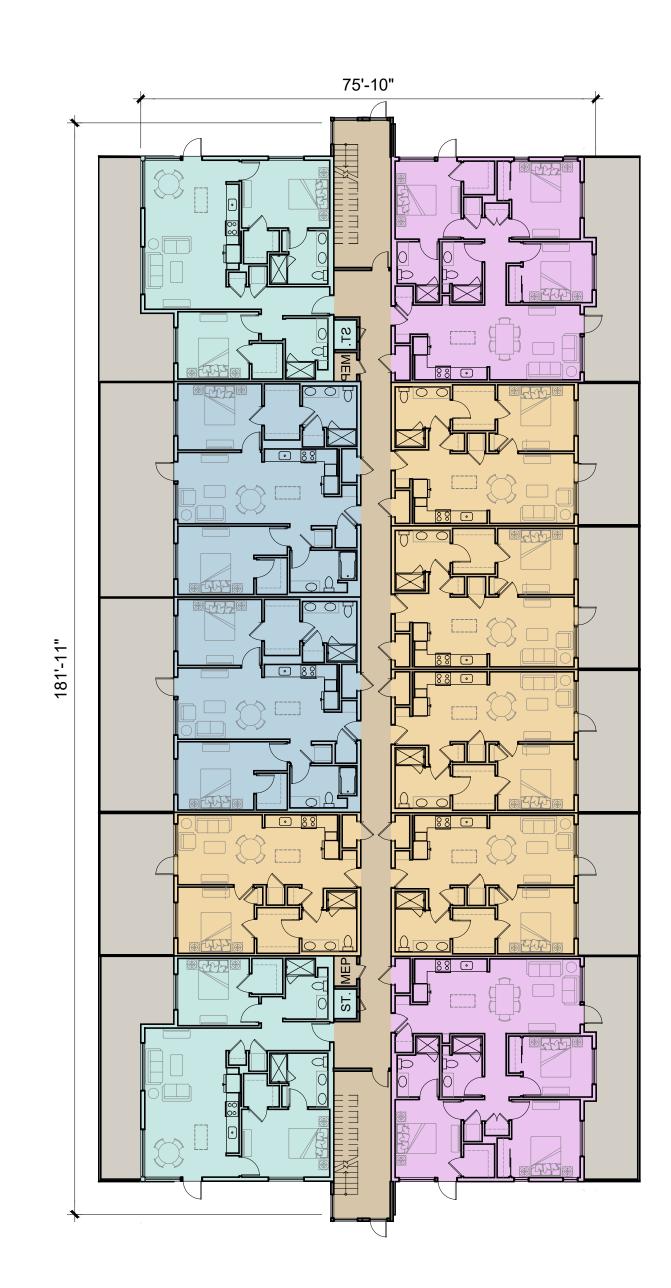
SHE

BUILDING A ELEVATIONS









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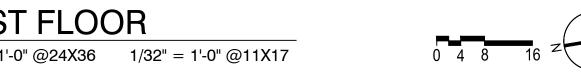
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BUILDING B **PLANS** 











T.O. COMM. ROOF

T.O. ROOF

MAIN ROOF

EAVE

LEVEL 3

LEVEL 3

DUND FLOOR



# **BUILDING B - EAST ELEVATION**

2 BUILDING B - WEST ELEVATION

- 3/64"=1'-0" @ 11X17 3/32" = 1'-0" @ 24X36



# 3 -

# **BUILDING B - SOUTH ELEVATION**



4 BUILDING B - NORTH ELEVATION

3/64"=1'-0" @ 11X17 3/32" = 1'-0" @ 24X36



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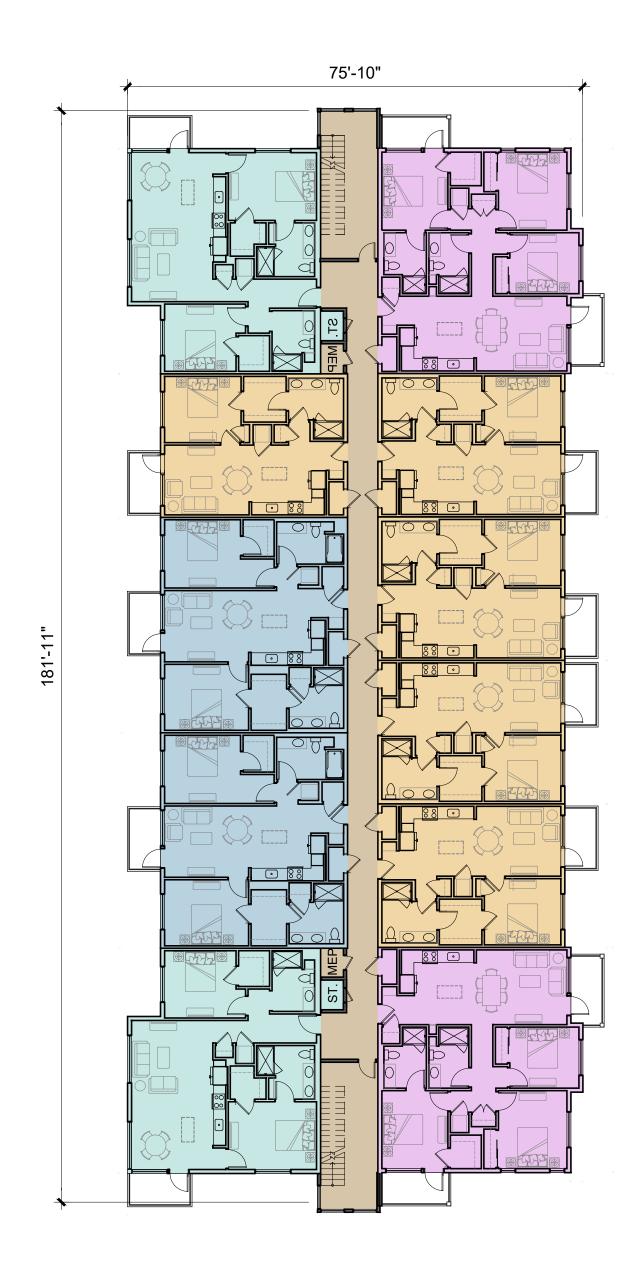
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SHE


BUILDING B ELEVATIONS

**A3.2** 







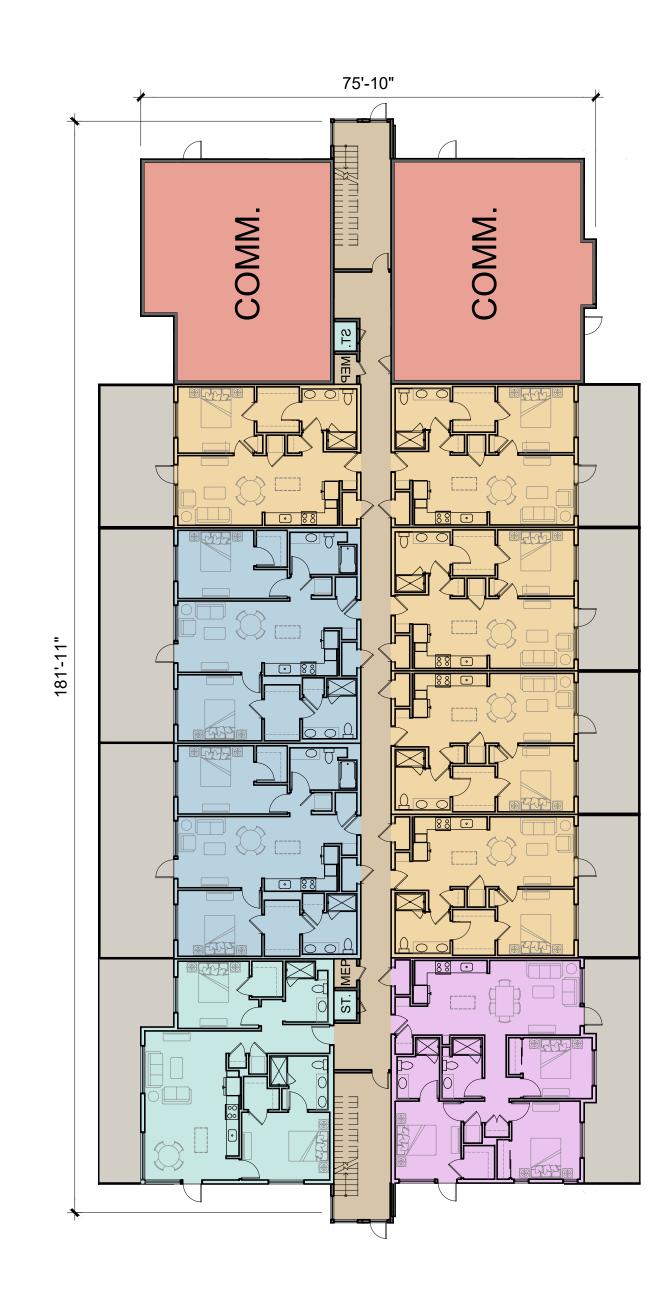

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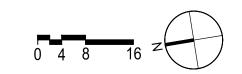
SHEE

BUILDING C PLANS











T.O. COMM. ROOF

T.O. ROOF

MAIN ROOF

EAVE

BRAVE

GROUD FLOOR



# BUILDING C - EAST ELEVATION

2 BUILDING C - WEST ELEVATION

3/64"=1'-0" @ 11X17 3/32" = 1'-0" @ 24X36




# 3

# **BUILDING C - SOUTH ELEVATION**



4 BUILDING C - NORTH ELEVATION

3/64"=1'-0" @ 11X17 3/32" = 1'-0" @ 24X36

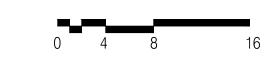

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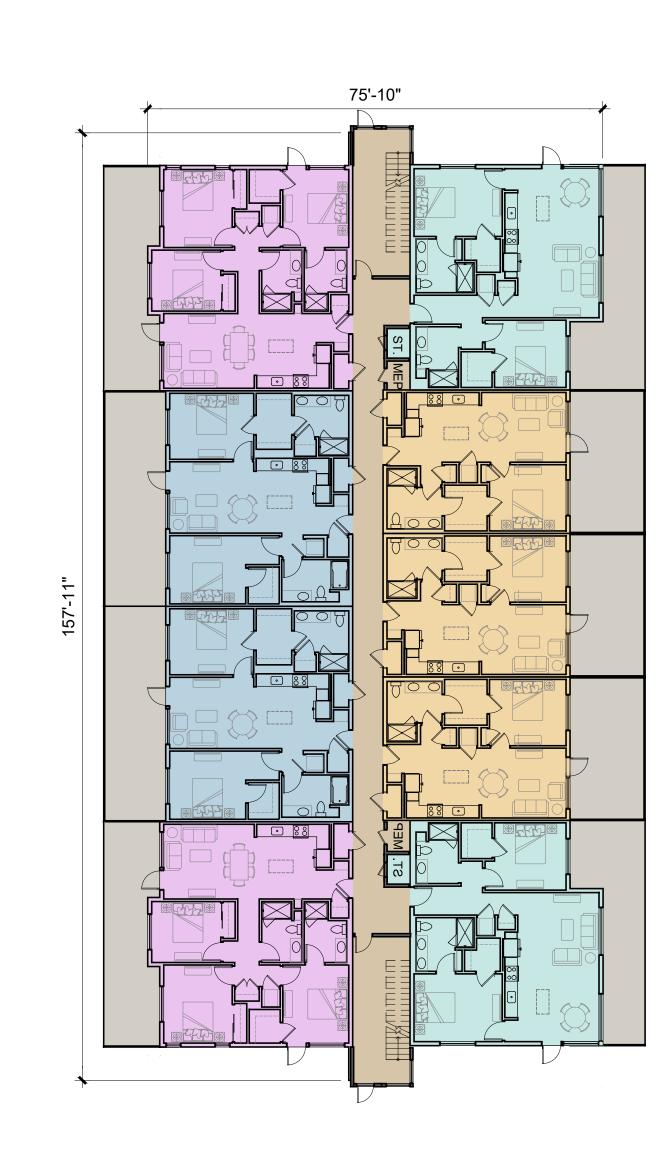
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BUILDING C ELEVATIONS









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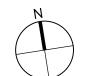
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BUILDING D PLANS












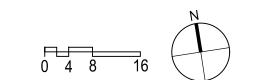







# **BUILDING D - NORTH ELEVATION**



**BUILDING D - SOUTH ELEVATION** 



# **BUILDING D - WEST ELEVATION**



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COTATI

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BUILDING D ELEVATIONS

**A22** 

**BUILDING D - EAST ELEVATION** 









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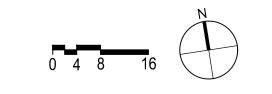
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BUILDING E PLANS


















# **BUILDING E - NORTH ELEVATION**

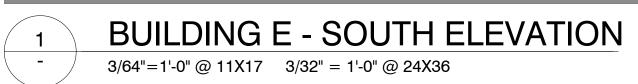



# 3 -

# **BUILDING E - WEST ELEVATION**



0 4 8 16

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SHE

BUILDING E ELEVATIONS


**A24** 

BUILDING E - EAST ELEVATION







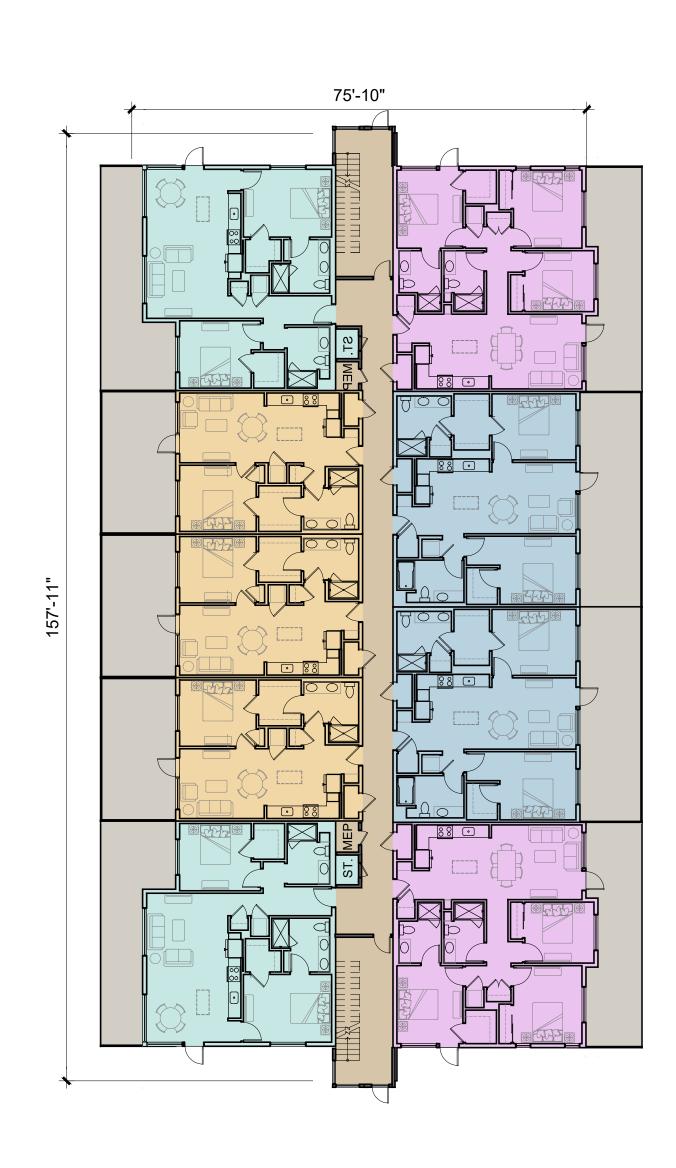

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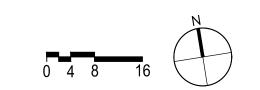
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BUILDING F PLANS

















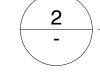

# **BUILDING F - NORTH ELEVATION**

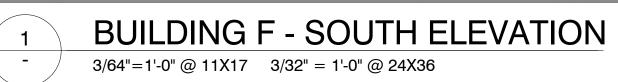

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BUILDING F ELEVATIONS

**A26** 

# TO COMM. ROOF TO ROO

# **BUILDING F - WEST ELEVATION**



BUILDING F - EAST ELEVATION





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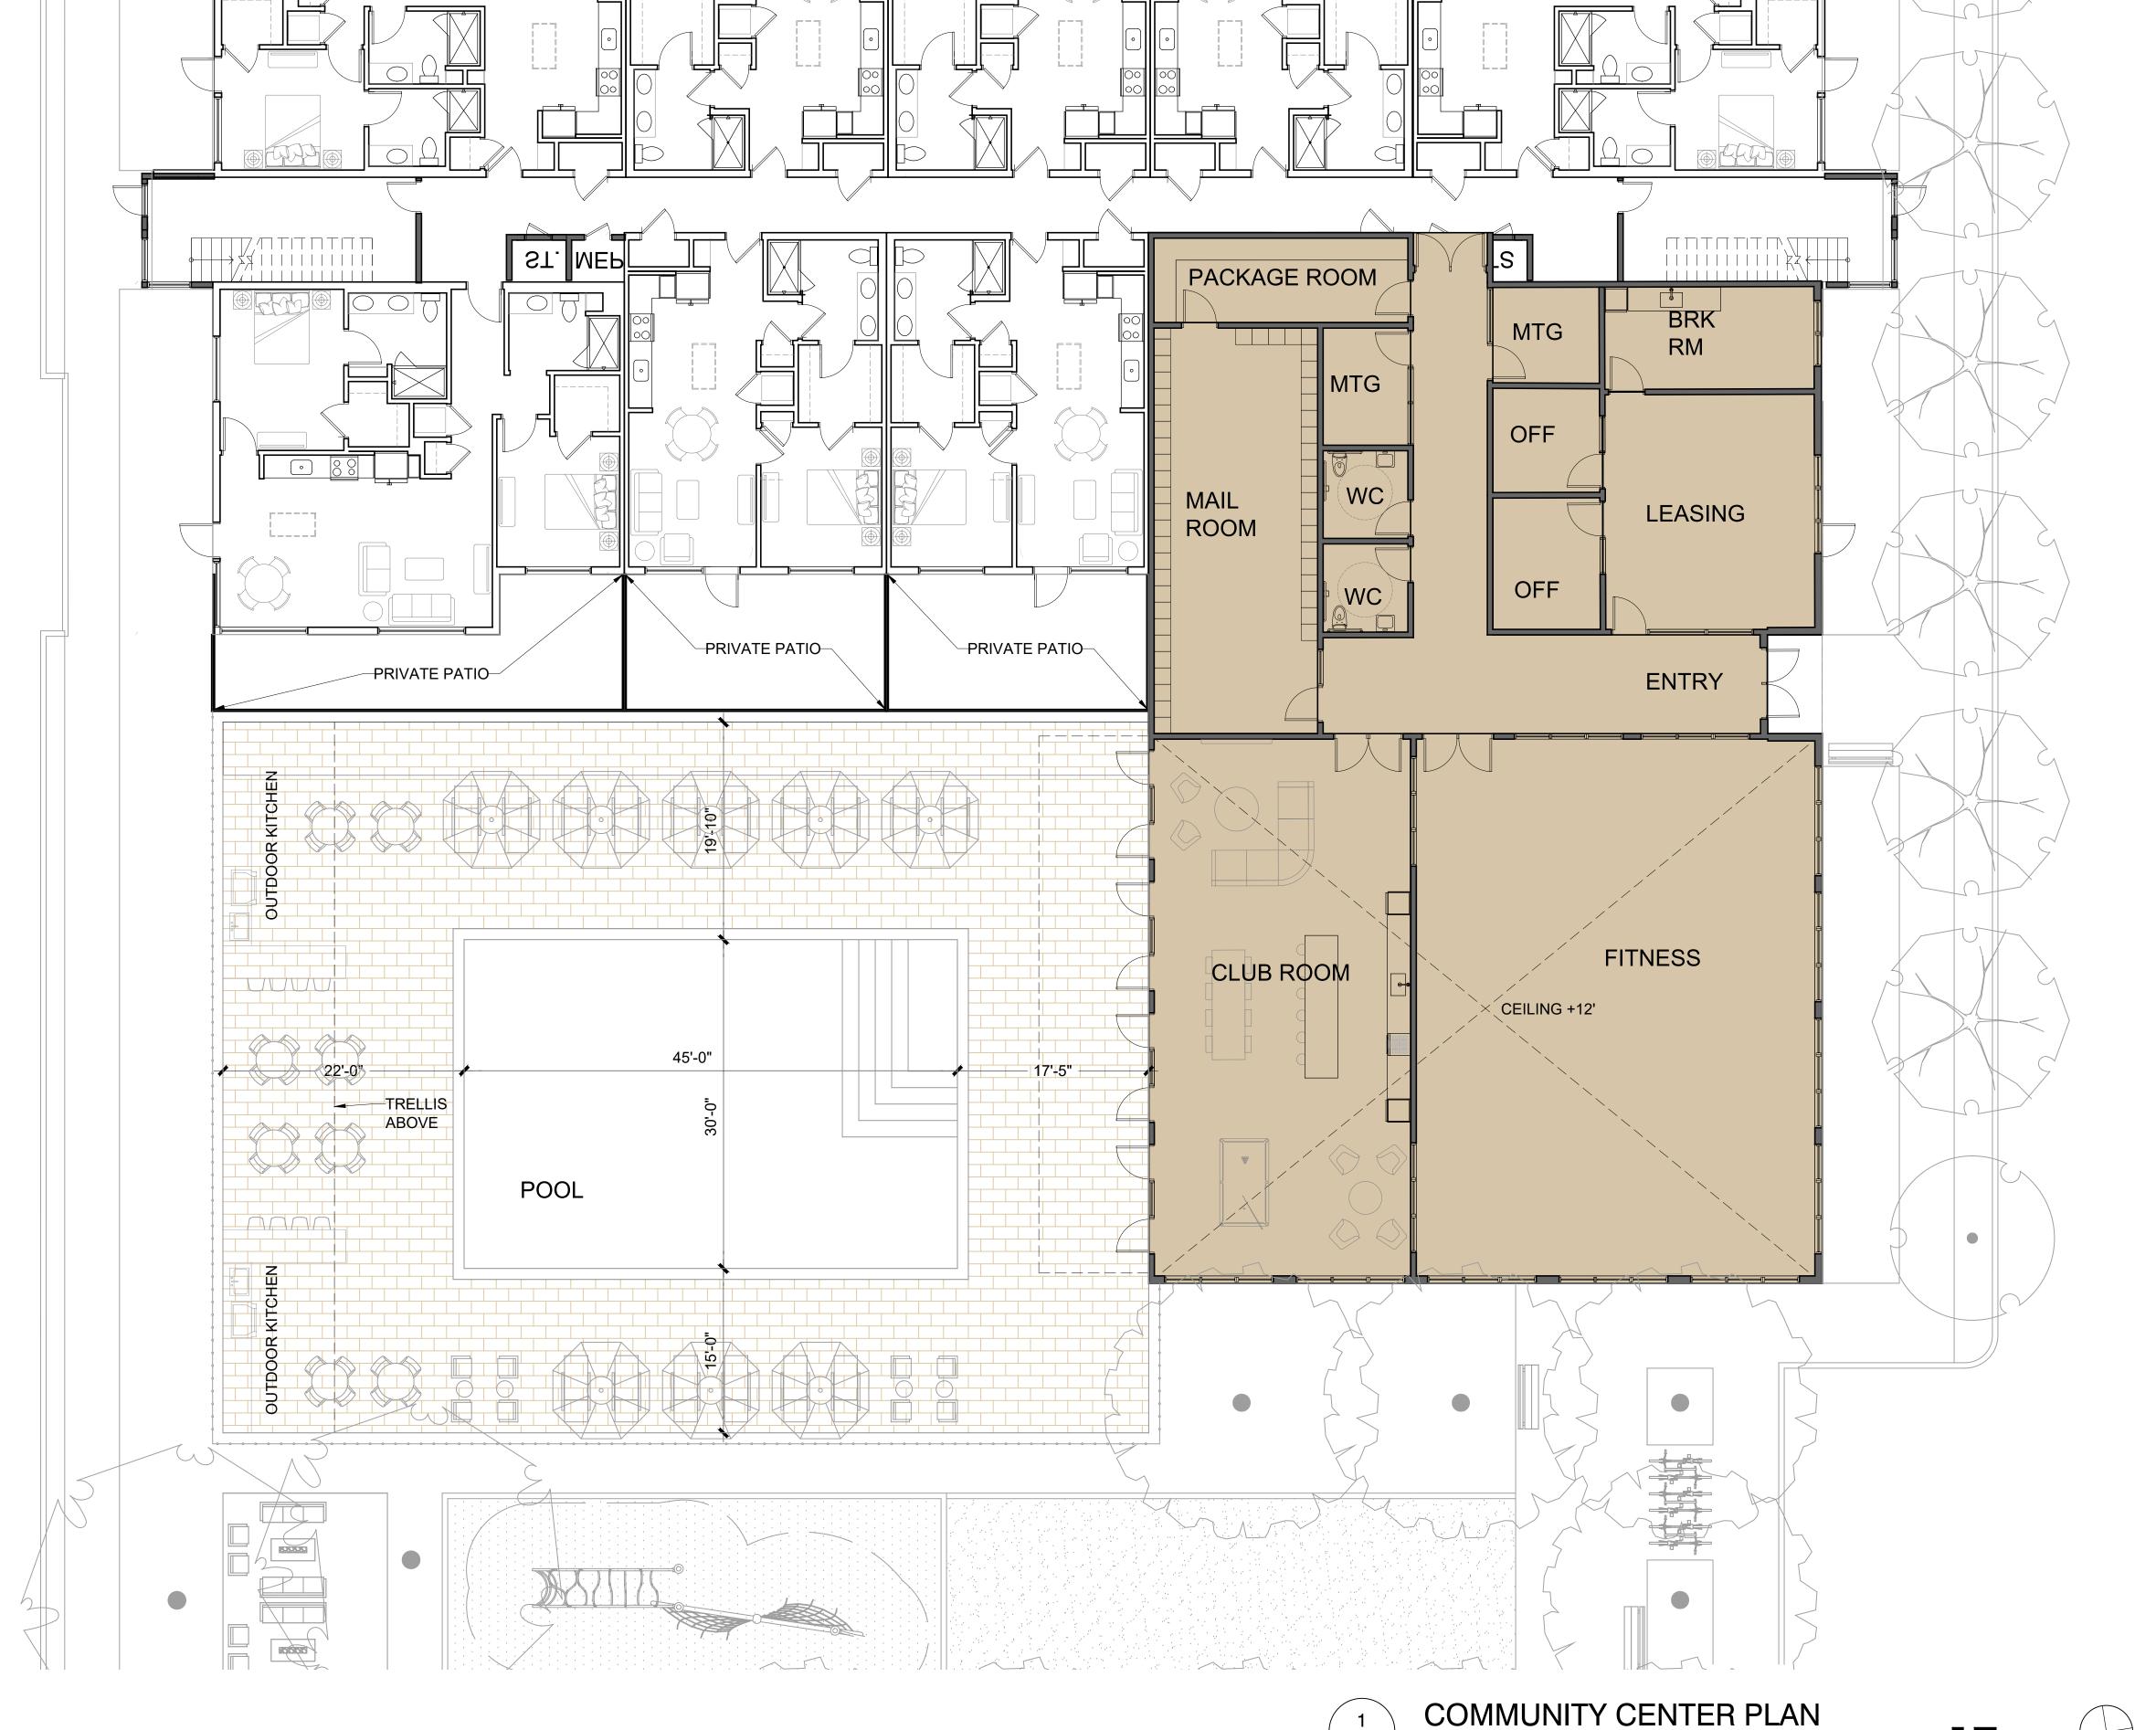
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COMMUNITY CENTER PLAN





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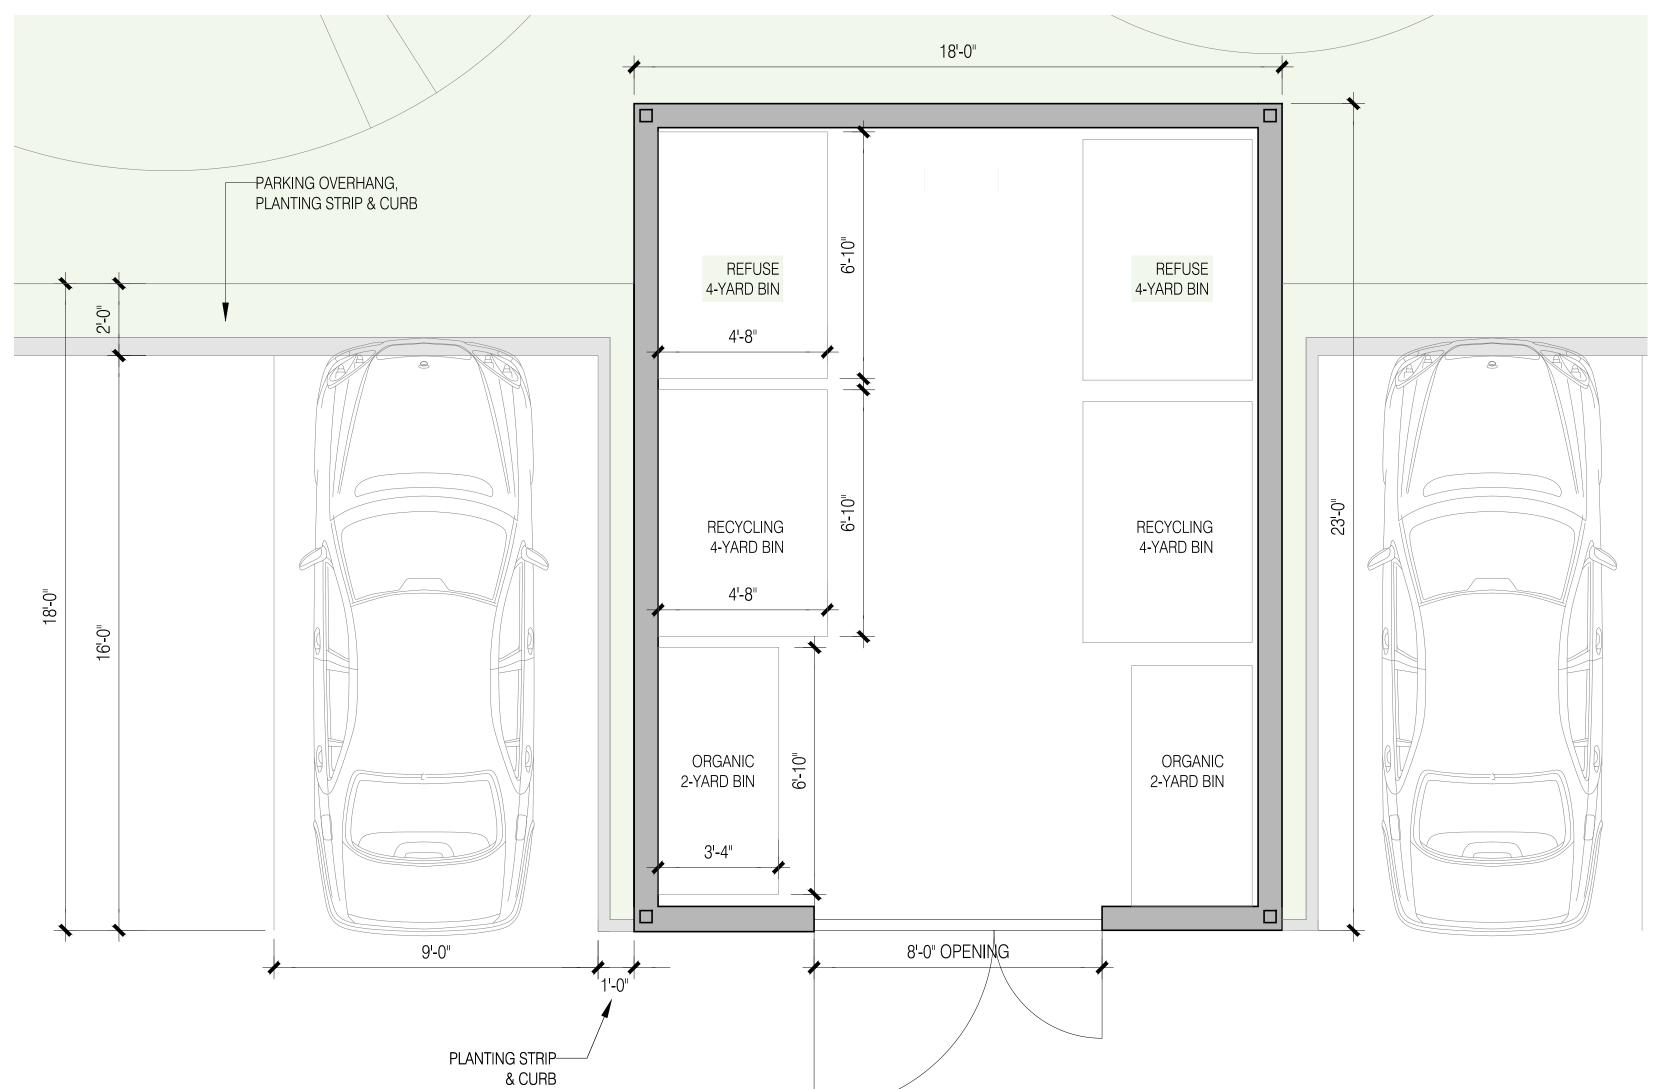
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JOB: 2304

SHEET:

PARKING + TRASH ENCLOSURE

**A33** 



SECOND FLOOR
11'-0"

METAL ROOF
ON POSTS


SPLIT FACE
CMU BLOCK
FIRST FLOOR
0'-0"

FIRST FLOOR
0'-0"

2

REAR ELEVATION - TRASH ENCLOSURE
3/16"=1'-0" @ 11X17 3/8"=1'-0" @ 24X36

1 TRASH ENCLOSURE - PLAN 3/16"=1'-0" @ 11X17 3/8"=1'-0" @ 24X36

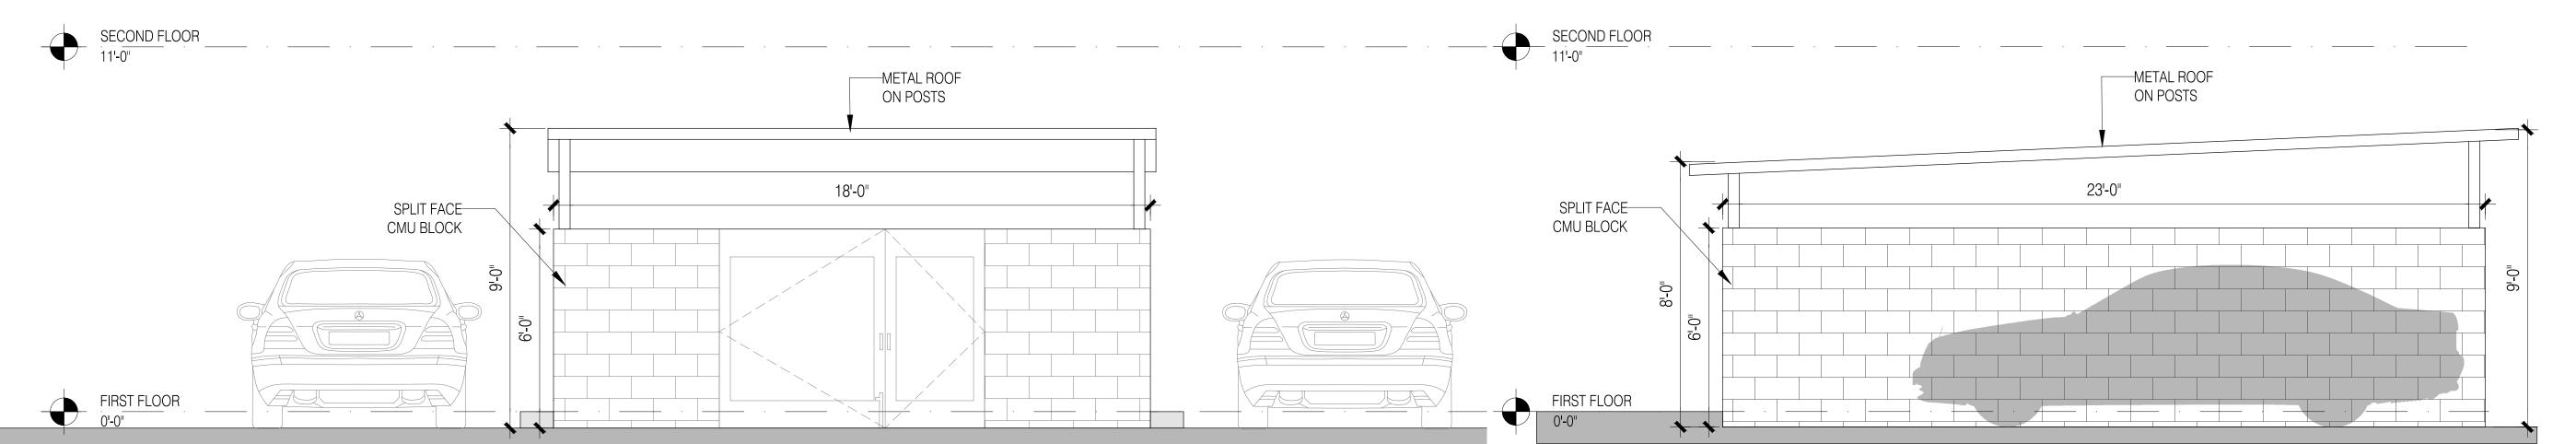





# COTATI **VILLAGE** COMMUNITY

Cotati, CA

11.08.2023 REVISED SUBMITTAL (CORE)


12.18.2023 REVISED SUBMITTAL (FULL)


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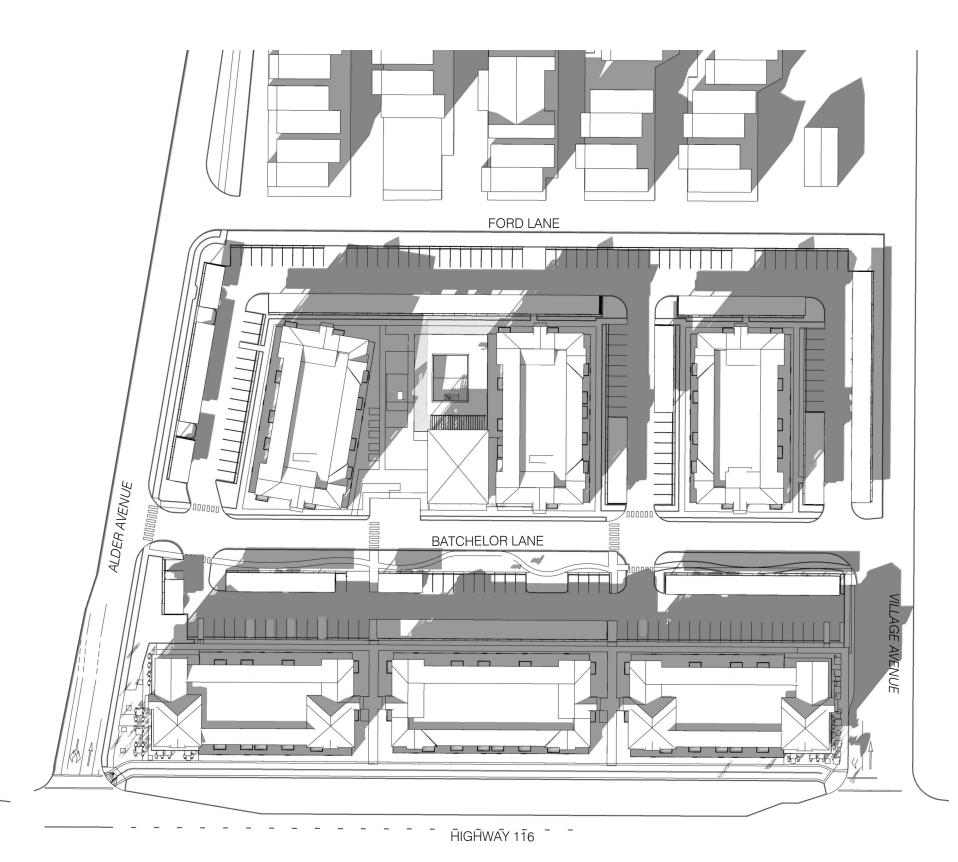
CONSENT OF TRACHTENBERG ARCHITECTS.

JOB: **2304** 


SHADOW STUDY WINTER & SUMMER SOLSTICE



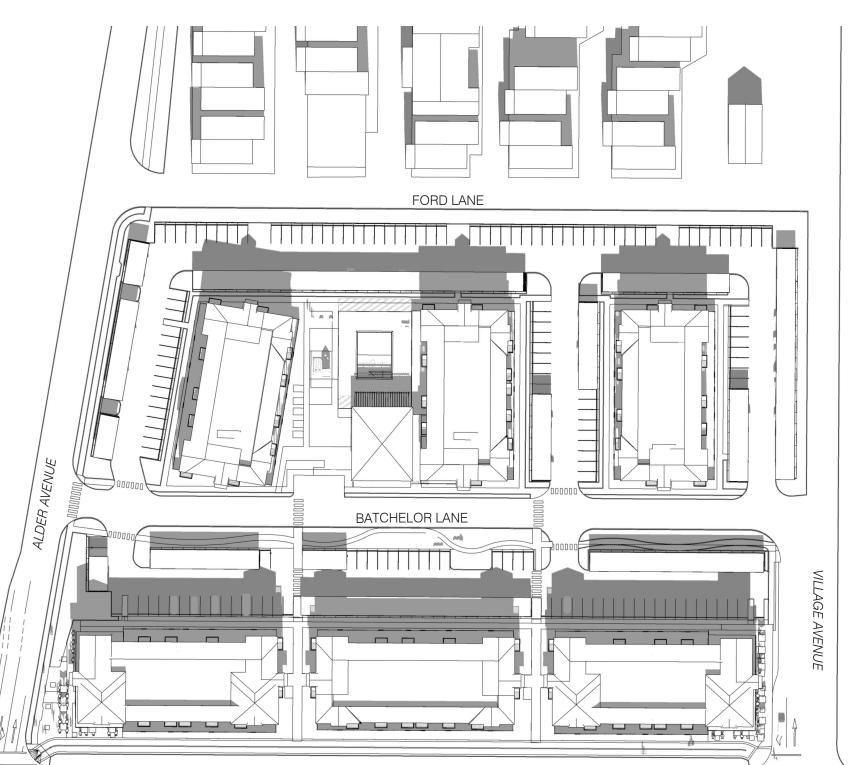


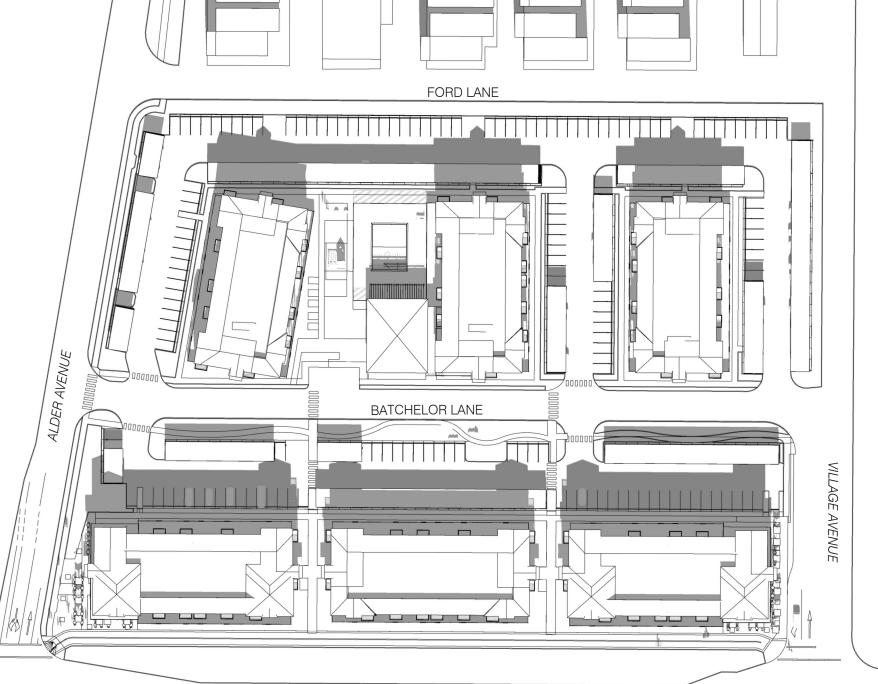


SHADOW STUDY - DEC 21ST - SUNSET -2HRS 

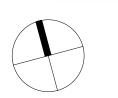


SHADOW STUDY - DEC 21ST - NOON 

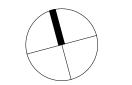

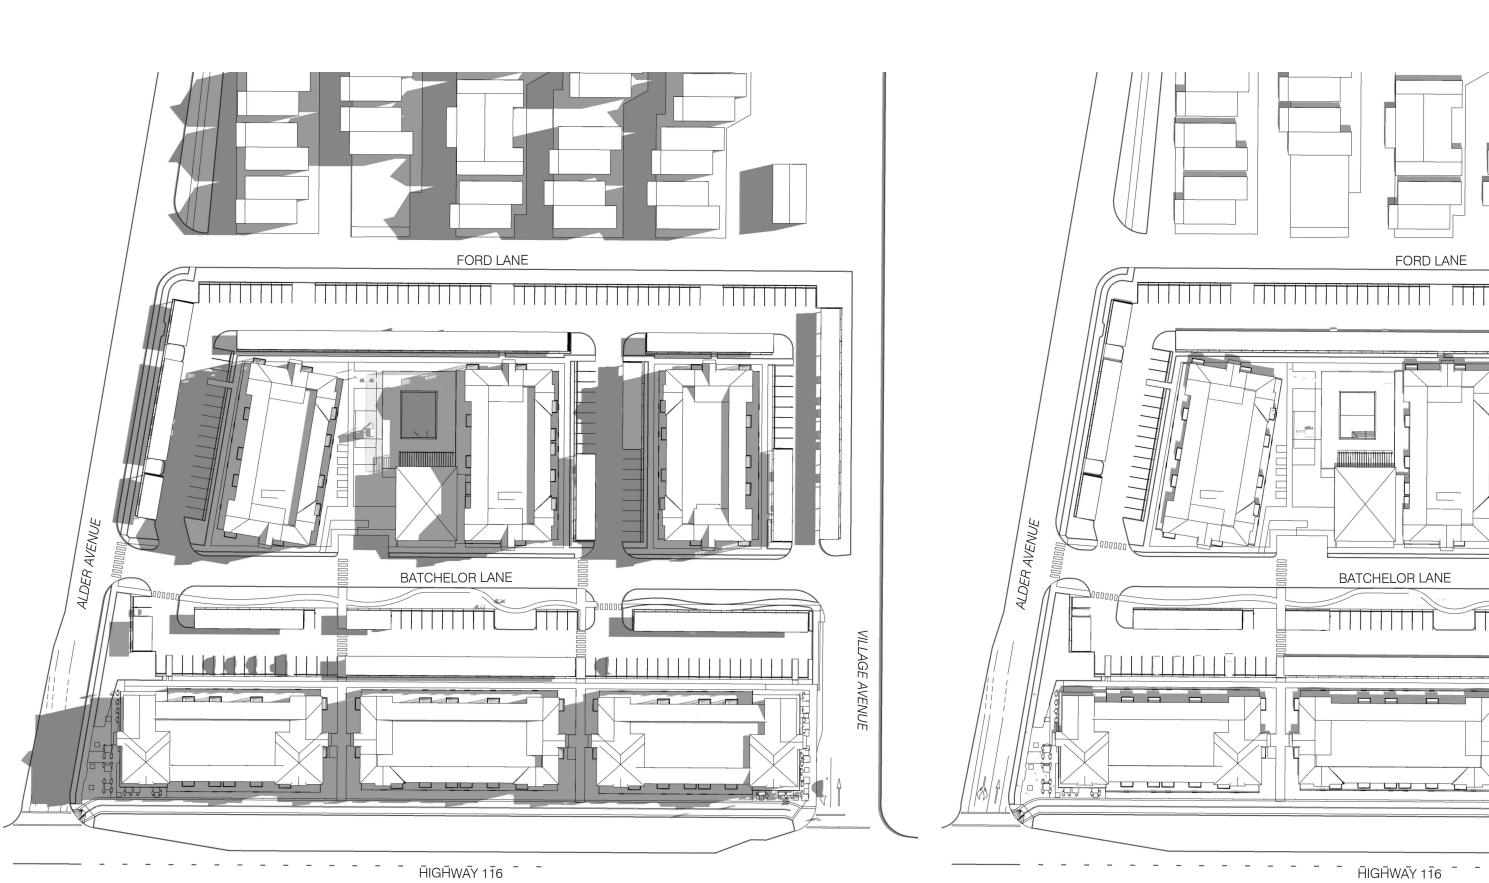


BATCHELOR LANE

SHADOW STUDY - DEC 21ST - SUNRISE +2HRS

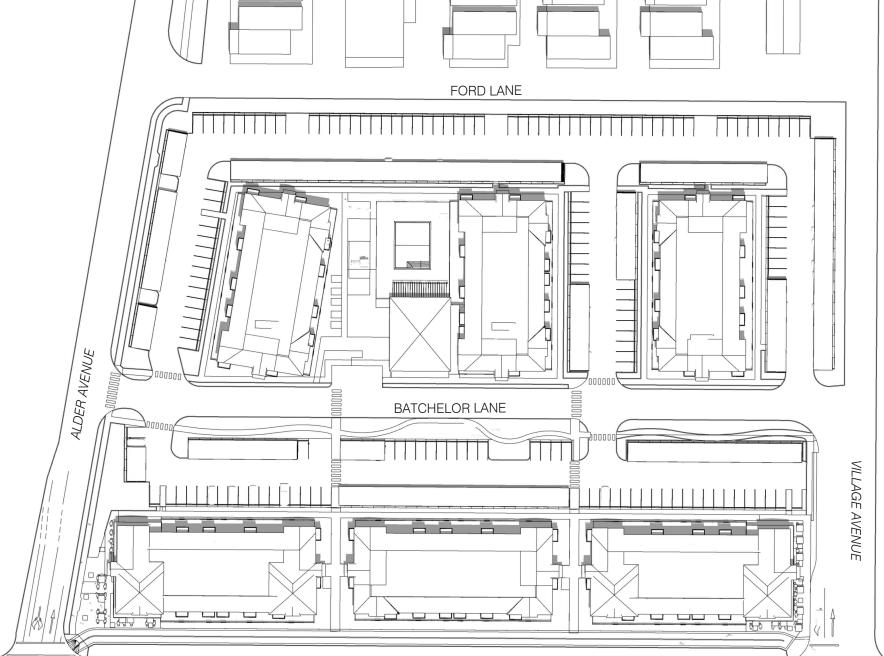

SHADOW STUDY - JUN 21ST - NOON 

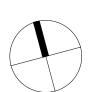


SHADOW STUDY - JUN 21ST - SUNSET -2HRS 

\_\_\_\_\_\_ - \_ - \_ - \_ - \_ - \_ HIGHWAY 116 - \_

BATCHELOR LANE

FORD LANE

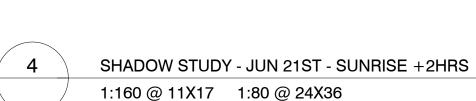





# COTATI **VILLAGE** COMMUNITY

Cotati, CA

11.08.2023 REVISED SUBMITTAL (CORE)


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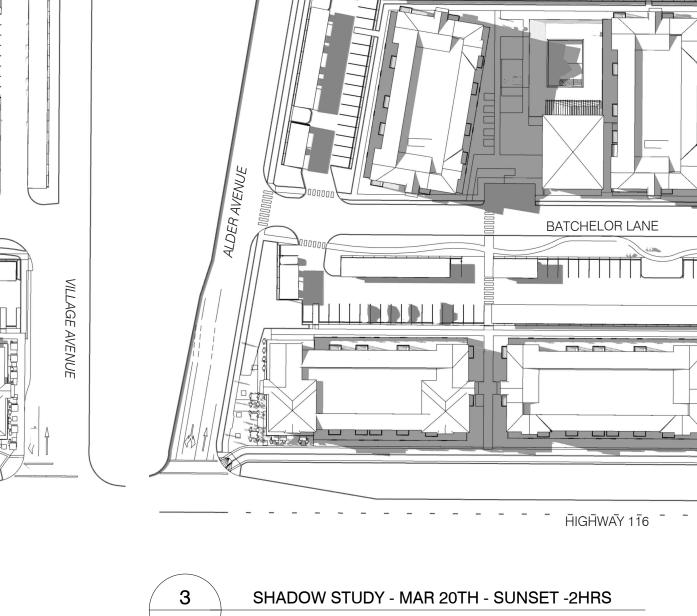
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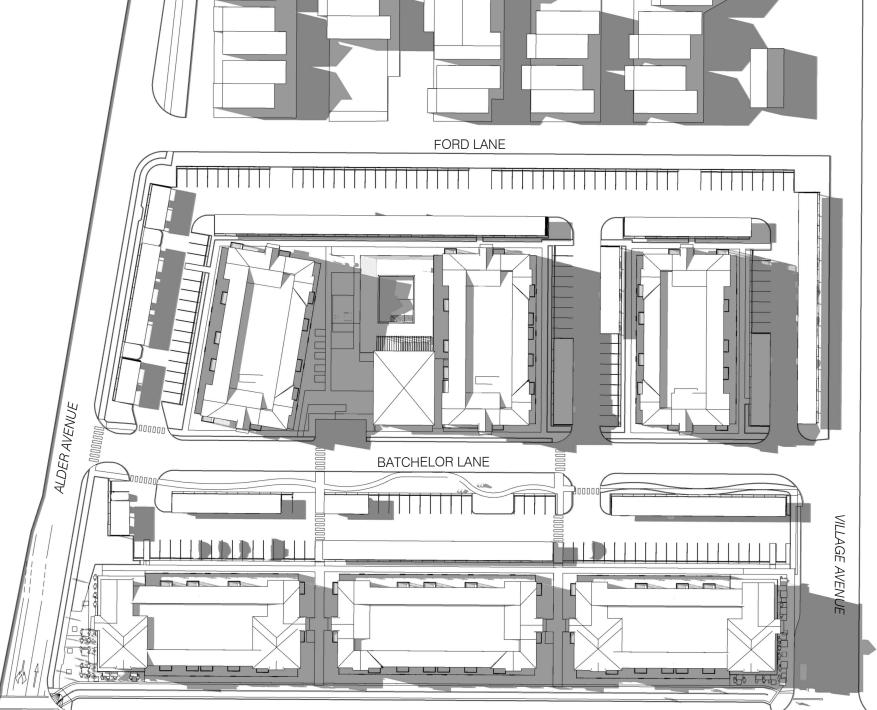
JOB: **2304** 

SHADOW STUDY EQUINOX

**A35** 





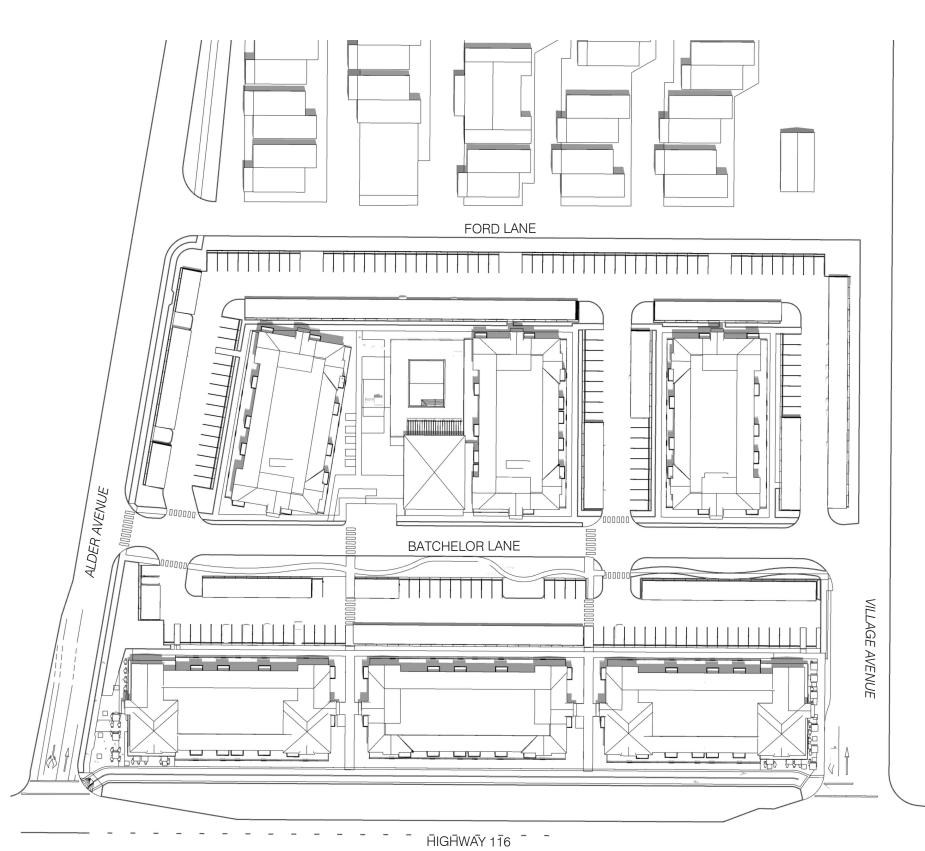




SHADOW STUDY - MAR 20TH - SUNRISE +2HRS 

\_\_\_\_\_\_ - - - - - - - - - - - - HIGHWĀY 116 - -

BATCHELOR LANE

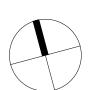

SHADOW STUDY - MAR 20TH - NOON 



SHADOW STUDY - MAR 20TH - SUNSET -2HRS 





TRACHTENBERG ARCHITECTS

2421 Fourth Street Berkeley, California 94710 510.649.1414 www.TrachtenbergArch.com

# COTATI **VILLAGE COMMUNITY**

Cotati, CA

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JOB: **2304** 

**USABLE OPEN** SPACE DIAGRAM





### Commercial Mid-Rise Windows

### Strength & Performance

- Superior product performance developed and tested in the lab, proven in the field Commercial grade metal reinforcements interconnected throughout window
- Vinyl frames deliver consistent thermal performance and minimize condensation Windows are assembled with continuous frames to avoid risky mulls

### Water Resistance

- · Panel level design minimizes water intrusion and air infiltration/ex-filtration
- Fusion welded corners provide environmental comfort and protect against leaks Integral nailfin options for ease of installation and water barrier

### Design & Security

- Durable, co-extruded acrylic exterior finishes allow for color diversity
- Available multiple locking points ensure security and compress the triple
- weather seal for superior air and water resistance
- Easy to operate hardware for egress and fair housing requirements
- · Heavily reinforced intersecting "T-Bar" system allows for design freedom with superior structural, air, water, and thermal performance




# vpi Quality Windows

www.vpiwindows.com (800) 634-1478 | info@vpiwindows.com 3420 E. Ferry, Spokane, WA 99202

> Options: Casement Awning

 Fixed Single Hung Horizontal Slider

### Commercial-Rated Performance: Engineered for Mid-Rise Construction

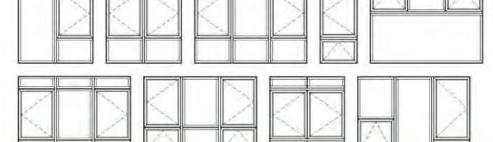

# Sill Details: Casement/Awning 3 1/2" Frame Depth Up to CW PG-70

 U values as low as .18 Sound Rating as high as STC 44/OITC 33

- **Fixed Window** 3 1/2" Frame Depth
  - Up to CW PG-40 U values as low as .16 Sound Rating as high as STC 44/OITC 33

Horizontal Slider

STC 36/OITC 29

3 1/2" Frame Depth


Single Hung 3 1/2" Frame Depth

as STC 36/OITC 29

- Up to LC-PG55 U values as low as .22 Sound Rating as high
- - Up to LC-PG50 U values as low as .22 Sound Rating as high as

# Colors:


**vpi** Quality Windows

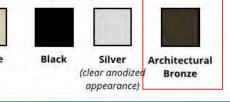



Printing limitations prevent exact color duplication.

Contact your VPI representative for color samples.

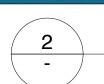

# WINDOW PRODUCT INFORMATION









COMPOSITE FENCING SYSTEM

**Trex** Seclusions

NOTES:

Publication date Jan 29, 2019

SPECIFICATION.

INFORMATION.

CONSTRUCTION DETAILS.

**EXPLODED VIEW** 

4. DRAWING NOT TO SCALE.

1. INSTALLATION TO BE COMPLETED PER MANUFACTURER'S

2. THIS DRAWING IS PROVIDED FOR PLANNING PURPOSES.

REFER TO MANUFACTURER'S INSTALLATIONS FOR

3. REFER TO MANUFACTURER'S WEBSITE FOR PRODUCT







COMPOSITE FENCING SYSTEM

COMPOSITE FENCING SYSTEM

# **BEAUTY AND PRIVACY FROM EVERY ANGLE**

Consult local conditions, codes, and standard building practices for post depth

SPECIFICATION.

1. INSTALLATION TO BE COMPLETED PER MANUFACTURER'S

2. THIS DRAWING IS PROVIDED FOR PLANNING PURPOSES.

REFER TO MANUFACTURER'S INSTALLATIONS FOR

Trex Seclusions

Make your backyard a true masterpiece. Frame it with Trex Seclusions®. This composite fencing system offers the perfect backdrop to compliment any backyard paradise. With lasting beauty and low maintenance, it's the perfect fencing solution.



Learn more at trexfencing.com/videos

COMPONENTS

Post Cap: Pyramid, Flat,

4" x 4.9" Top Rail

1"x5.75" Interlocking Picket

5" x 5" Post

1" x 5.75"

**Bottom Rail Cover** 

Fence Bracket

1 5/8" (Typ)

Fence Bracket——

Aluminum Bottom Rail

Exterior Wood Screws

Post Profile: Cut View / Elevation View

160 EXETER DR., WINCHESTER VA, 22603

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ARCHITECTURAL DRAWING:

TREX SECLUSIONS FENCING

6' TALL x 8' WIDE

# TRACHTENBERG ARCHITECTS

2421 Fourth Street Berkeley, California 94710 510.649.1414 www.TrachtenbergArch.com

# COTATI **VILLAGE COMMUNITY**

Cotati, CA

		11.0	8.20	023	F	RE'	VIS	SEI	D S	SUE	3M	ΙΤΊ	ΓAL	_ ((	CO	RE
		12.1	8.20	023	F	RE'	VIS	SEI	D S	SUE	3M	ΙΤΊ	ΓAL	_ (F	-UL	L)

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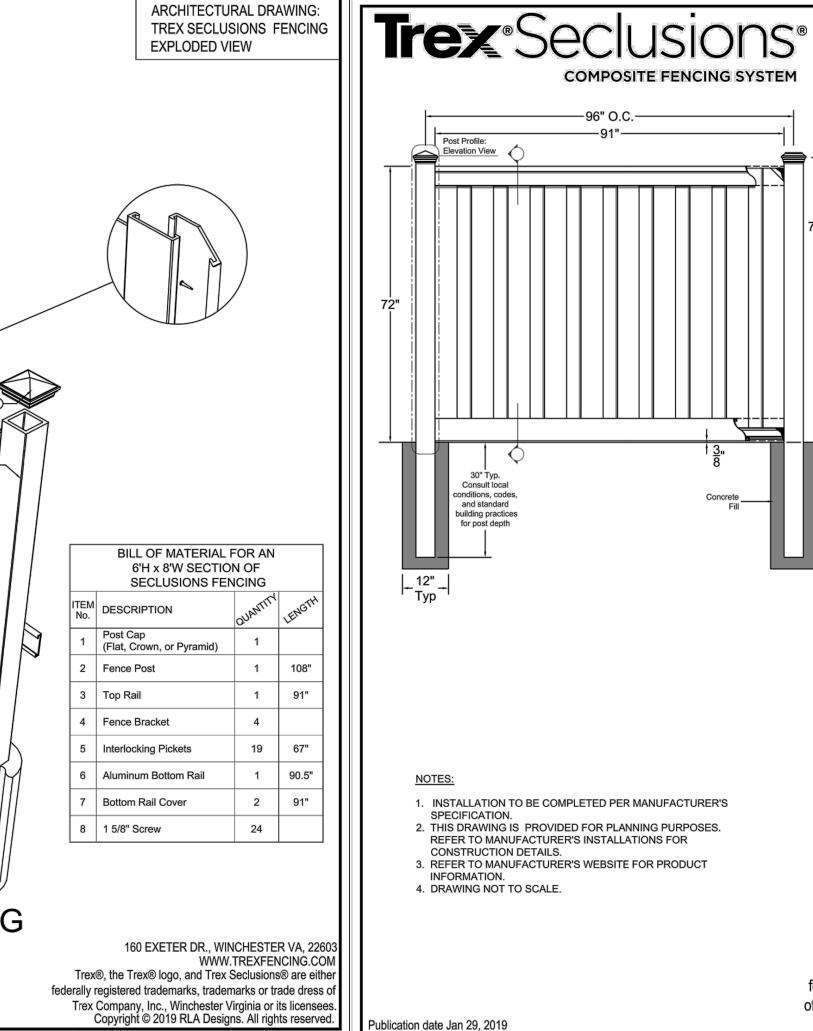
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JOB: **2304** 

SHEET:

FENCE DETAILS & WINDOW INFORMATION

**A38** 



TREX SECLUSIONS FENCING

CONSTRUCTION DETAILS.

3. REFER TO MANUFACTURER'S WEBSITE FOR PRODUCT INFORMATION.
4. DRAWING NOT TO SCALE.

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PATIO FENCE DETAILS



PRIMARY COLOR BEHR AGED BEIGE STUCCO



SECONDARY COLOR BEHR SUEDE GRAY STUCCO




TRIM COLOR

BEHR SUEDE GREY

PAINTED WOOD

TREX SADDLE FENCING

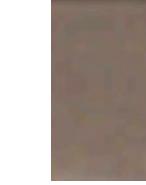

TREX TRANSCEND
COMPOSITE
DECKING
ISLAND MIST



ASPHALT SHINGLE ROOF



VINYL WINDOWS, ARCHITECTURAL BRONZE

TRACHTENBERG ARCHITECTS

2421 Fourth Street
Berkeley, California 94710
510.649.1414
www.TrachtenbergArch.com



### **LEGAL DESCRIPTION:**

REAL PROPERTY IN THE CITY OF COTATI, COUNTY OF SONOMA, STATE OF CALIFORNIA, DESCRIBED AS FOLLOWS:

### PARCEL ONE:

LYING WITHIN THE COTATI RANCHO, COUNTY OF SONOMA, STATE OF CALIFORNIA AND BEING A PORTION OF LOTS 159 AND 160 AS SAID LOTS ARE SHOWN ON THE MAP ENTITLED "MAP OF SUBDIVISION NO. 7 RANCHO COTATI" ON FILE IN BOOK 10 OF MAPS, PAGE 9, SONOMA COUNTY RECORDS, SAID LANDS ALSO BEING A PORTION OF PARCEL NO. TWO OF LOT LINE ADJUSTMENT PER DOCUMENT NO. 2002-063020, PARCEL NO. FIVE OF LOT LINE ADJUSTMENT PER DOCUMENT NO. 2002-063023 BOTH OF OFFICIAL RECORDS OF SONOMA COUNTY, SAID PORTIONS BEING COMBINED TO FORM A SINGLE PARCEL. APN 046-286-021-000

PARCEL A, AS SHOWN UPON THE MAP ENTITLED "COTATI COTTAGES, A PLANNED UNIT DEVELOPMENT" FILED MARCH 19, 2003 IN BOOK 646 OF MAPS, PAGES 5 THROUGH 11, SONOMA COUNTY RECORDS. APN 144-050-009-000

### **BENCHMARK:**

BEING A STANDARD TABLET STAMPED "5 GWM 1945 101" LOCATED IN THE TOP OF THE WEST END OF THE SOUTH HEADWALL OF A CONCRETE CULVERT ON THE SOUTHERLY SIDE OF THE GRAVENSTEIN HIGHWAY (116), 530' WESTERLY OF ALDER AVENUE. NGVD29 DATUM, ELEVATION 100.48'. (NAVD88 DATUM, ELEVATION=103.25' PER CARLISLE MACY TENTATIVE MAP FOR "SOUTH SONOMA BUSINESS PARK".)

### **BASIS OF BEARINGS:**

THE BEARING OF THE MONUMENTED EASTERLY LINE OF ALDER AVENUE AS SHOWN ON THE FINAL MAP OF "COTATI COTTAGES" FILED MARCH 19, 2003 IN BOOK 646 OF MAPS AT PAGES 5-13, SONOMA COUNTY RECORDS, BEING N19°06'07"E.

# **ABBREVIATIONS**

אטטא	LTIATIONS		
ABND		MH N'LY	MANHOLE NORTHERLY
	ABANDONED		
	ASPHALTIC CONCRETE	N.A.P	NOT A PART NOT TO SCALE
AD	AREA DRAIN	NTS Pa	
BW		PCC	
Q.	CENTER LINE	PR.	
CB	CATCH BASIN	PL	PROPERTY LINE
CSP	CORRUGATED STEEL PIPE	R	
DW	DOMESTIC WATER	RCP	
E'LY	EASTERLY	RW	
EG	EXISTING GRADE	R/W	
EX	EXISTING	SD "	
FG	FINISHED GRADE		STANDARD DIMENSION RATIO
FH	FIRE HYDRANT	SF	
FL	FLOW LINE	S'LY	
FNC	TOP OF FENCE		SANITARY SEWER
FS	FINISHED SURFACE	STA	STATION
FW	FIRE WATER	STD	STANDARD
GB	GRADE BREAK	TC	TOP OF CURB
GFF		TF	TOP OF FOOTING
HP	HIGH POINT	TG	TOP OF GRATE
INV	INVERT	TW	TOP OF WALL
LA	LANDSCAPE AREA	TS	TOP OF SLOPE
LL	LOT LINE	TYP	TYPICAL
LP	LOW POINT	w/	WEST/WITH
MIN	MINIMUM	••/	11201/ WIIII

### 

MISCELLANEOUS

<u>LEGEND</u>		
<b></b>	FLOWLINE	
<del></del>	CENTERLINE	
	DAYLIGHT LINE	
	TRACT BOUNDARY / RIGHT-OF-WAY LINE	
	LOT LINE	
_X X	EX. FENCE	
	EX. STORM DRAIN LINE	
	PROP. STORM DRAIN	$\overline{}$
	CATCH BASIN/LOCAL DEPRESSION	_
	JUNCTION STRUCTURE	
———(W <del>)</del>	EX. WATER LINE	
	PROP. WATER LINE	
	FIRE HYDRANT	
•	WATER VALVE	
— · — (S <del>S)</del> · —	EX. SEWER LINE	

PROP. SEWER LINE

$\circ$	MANHOLE
0	CLEANOUT
	PROP. RETAINING WAL
	EX. WALL
	PROP. SCREEN WALL
	PROP. FENCE
	EX. CONTOUR LINE
-	EX. POWER POLE
YYY	SLOPE (2:1 UNLESS OTHERWISE INDICATED)
10	– LOT NUMBER – PLAN TYPE
	RIDGE LINE


DECORATIVE PAVEMENT

OVERLAND EMERGENCY

OVERHEAD LINE

**OVERFLOW** 

# IN THE CITY OF COTATI STATE OF CALIFORNIA

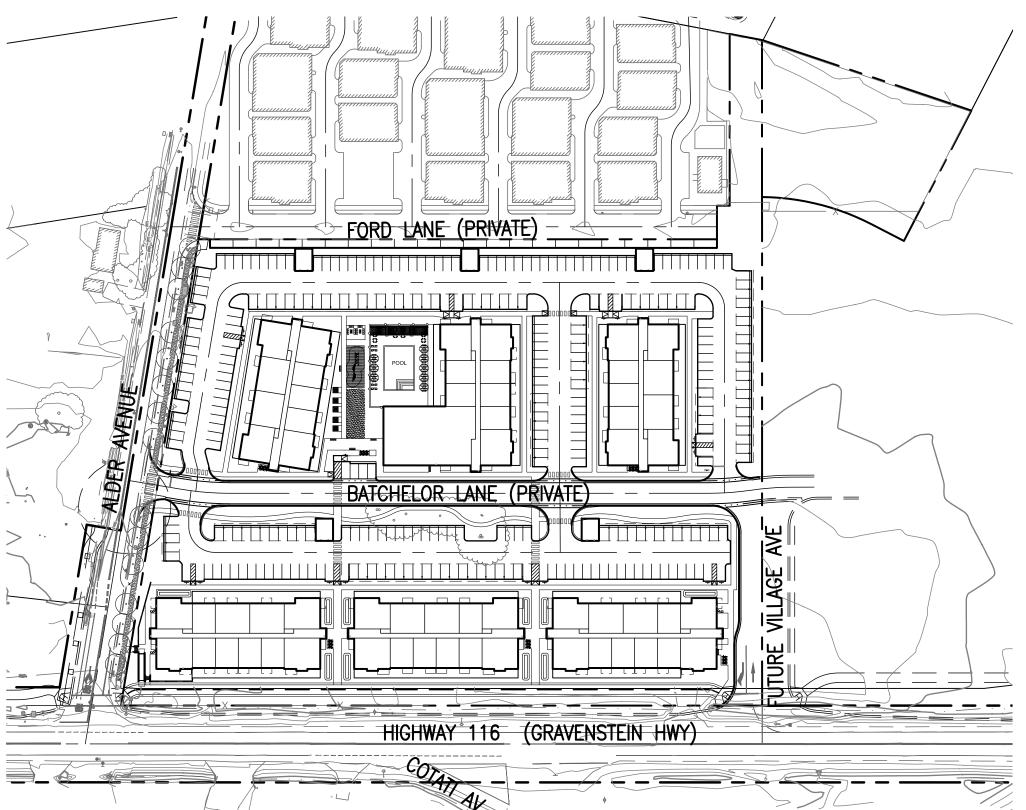

# PROJECT DESCRIPTION:

PERIMETER CONDITIONS (SHEET CO)

1. A PRIVATE STREET IS PROPOSED TO CONNECT ALDER AVE WITH A FUTURE DEVELOPMENT TO THE EAST. ANOTHER FUTURE STREET IS PLANNED ALONG THE EASTERN EDGE OF THE PROJECT. THIS WILL CONNECT TO THE FUTURE WIDENING AND SIGNALIZATION OF HIGHWAY 116 (GRAVENSTEIN HWY).

NO IMPROVEMENTS ARE PROPOSED ALONG HIGHWAY 116 (GRAVENSTEIN HWY) WITH THIS DEVELOPMENT.
THE PROPOSED IMPROVEMENTS DO NOT CONFLICT WITH THE FUTURE CUL—DE—SAC MODIFICATIONS TO ALDER AVE. THE
CURB RETURN ON THE SOUTH SIDE OF BATCHELOR CAN REMAIN IN PLACE AND THE NEW CURB CAN CONNECT

4. REVISED TO MATCH REVISED SITE PLAN.

TOPOGRAPHY (SHEET C1)

1. SIX (6) OAK TREES ARE TO BE SAVED NEAR THE CENTER OF THE SITE.

2. FOUR (4) OAK TREES WILL BE REMOVED ALONG WITH SEVERAL OTHER NON-PROTECTED SPECIES OF TREES.

3. TWO EXISTING STOCKPILES ARE LOCATED ON THE PROPERTY. THESE WILL BE USED FOR SITE GRADING.

4. THE EXISTING CURB RETURNS AT ADDITION AND BATCHELOR SHALL BE REMOVED AND RECONSTRUCTED TO COMPLY WITH CITY MINIMUM CURB RETURN RADIUS.
THERE ARE NO ON—SITE WELLS, SEPTIC TANKS, OR UNDERGROUND FUEL STORAGE TANKS.
NO EXISTING STRUCTURES EXIST.
NO DEMOLITION PLAN IS REQUIRED.

SITE LAYOUT (SHEET C2)
 FIVE (5) RESIDENTIAL BUILDINGS ARE PROPOSED, THE THREE (3) BUILDINGS ALONG HIGHWAY 116 (GRAVENSTEIN HWY) WILL CONTAIN SOME COMMERCIAL/RETAIL AND RESIDENTIAL UNITS.
 BUILDINGS A, B, & C CONTAIN BOTH RESIDENTIAL AND COMMERCIAL/RETAIL UNITS. A PLAZA SERVES THE CORNER COMMERCIAL UNIT IN BUILDING A. ANOTHER SMALLER PLAZA IS LOCATED NEAR THE CORNER OF BUILDING C.
 A PRIVATE COMMUNITY CENTER WITH A POOL IS LOCATED IN THE CENTER OF THE PROJECT.
 FIRE ACCESS IS DEPICTED FOR EACH INTERSECTION. THE INSIDE RADIUS IS 25-FT AND THE OUTSIDE RADIUS IS 45-FT. THE WIDTH OF ALL ACCESS PATHS IS 20-FT. THIS COMPLIES WITH RANCHO ADOBE FIRE REQUIREMENTS.
 REVISED TO MATCH REVISED SITE PLAN.

EASEMENTS (SHEET C3)

1. ALL RELEVANT EASEMENTS FROM THE CURRENT TITLE REPORT (FIDELITY TITLE, DATED 10/21/21) ARE IDENTIFIED ON THIS PLAN. 2. SEVERAL EASEMENTS ARE TO BE VACATED WITH THE COOPERATION OF THE BENEFITING ORGANIZATIONS.
3. PROPOSED EASEMENTS ARE SHOWN FOR UTILITIES AND ACCESS.
4. REVISED TO MATCH REVISED SITE PLAN.

GRADING AND DRAINAGE (SHEET C4)

1. THE FINISHED FLOORS OF A, B, & C ARE SET SO THEY ARE HIGHER THAN THE FUTURE HIGHWAY 116 (GRAVENSTEIN 2. THE FINISHED FLOORS OF D, E, & F ARE SET AT LEAST 1-FT HIGHER THAN THE OVERFLOW ELEVATION OF THE

3. ADA ACCESSIBILITY TO THE AMENITIES IS MAINTAINED THROUGHOUT THE SITE.
4. REVISED TO MATCH REVISED SITE PLAN.

WATER QUALITY AFTER CONSTRUCTION (SHEET C5-0)

1. THE SOUTH 19% OF THE SITE IS TREATED BY 12 BIO-INFILTRATION SWALES LOCATED BETWEEN BUILDINGS A, B, & C.

2. THE NORTH 81% OF THE SITE IS TREATED IN THE MODIFIED BIO-INFILTRATION SWALE LOCATED ALONG THE NORTH PROPERTY LINE OF THE ADJACENT COTATI VILLAS TRACT. SEE EASEMENTS 2.6 AND 2.9 ON SHEET C3.

3. PLANTBLE PAVERS ARE PROPOSED ALONG BUILDING F WITHIN THE GREENBELT EASEMENT. SEE EASEMENT 2.8 ON 4. REVISED TO MATCH REVISED SITE PLAN.

WATER QUALITY DURING CONSTRUCTION (SHEET C5-1)

1. PERIMETER CONTROLS WILL PREVENT SEDIMENT RUNOFF FROM LEAVING THE PROJECT LIMITS.


2. SEDIMENT BASING OFFILE CONTAIN THE RUNOFF AND ALLOW SEDIMENT TO PRECIPITATE OUT BEFORE DISCHARGE TO THE STABILIZED CONSTRUCTION ENTRANCE/EXIT WILL LIMIT TRACKING OF DIRT ON PUBLIC ACCESS ROADS.

INLET PROTECTIONS (ONCE INLETS ARE INSTALLED) WILL PREVENT STORM DRAIN SYSTEM FROM CONVEYING SEDIMENT
LADEN RUNOFF FROM CLOGGING THE PIPES. 5. REVISED TO MATCH REVISED SITE PLAN.

JTILITIES (SHEET C6)
. EACH BUILDING IS SERVED BY A SINGLE SEWER, DOMESTIC WATER SERVICE, AND FIRE WATER SERVICE.
2. WATER CONNECTIONS ARE MADE TO THE MAINS IN ALDER AVENUE, FORD LANE, AND HIGHWAY 116 (GRAVENSTEIN HWY).
SEE EASEMENTS 1.3 AND 1.9 ON SHEET C3.
3. FIRE HYDRANTS ARE LOCATED THROUGHOUT THE SITE TO SERVE EACH BUILDING.
4. THE NORTH HALF OF THE SITE IS SERVED BY THE SEWER MAIN IN FORD LANE, THE SOUTH HALF IS SERVED BY THE SEWER MAIN ALONG HIGHWAY 116 (GRAVENSTEIN HWY). SEE EASEMENTS 2.1 AND 2.7 ON SHEET C3.
5. STORM DRAINAGE IS COLLECTED IN THE STREETS AND DRIVE AISLES AND CONVEYED VIA PIPE TO THE EXISTING SWALE ALONG THE NORTH PROPERTY LINE OF THE COTATI COTTAGES TRACT. FROM THERE IT CONNECTS TO THE STORM DRAIN SYSTEM IN ALDER AVE. SEE EASEMENTS 2.6 AND 2.9 ON SHEET C3.
5. THE OVERHEAD LINES ALONG HIGHWAY 116 (GRAVENSTEIN HWY) WILL BE PLACED UNDERGROUND.
6. REVISED TO MATCH REVISED SITE PLAN.

COTATI VILLAGE COMMUNITY

# COUNTY OF SONOMA

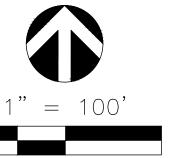

C-3 EASEMENTS EXHIBITS C-4 PRELIMINARY GRADING AND DRAINAGE PLAN

PRELIMINARY EROSION & SEDIMENT PLAN


C-6 PRELIMINARY UTILITY PLAN

### PRELIMINARY EARTHWORK QUANTITY ESTIMATE:

•		,		
<u>ITEM</u>			<b>QUANTITY</b>	
RAW CUT.		 	.+15,100 CY	
RAW FILL .		 	-12,500 CY	
NET CUT (	EXPORT)		-2,600 CY	

UPDATE 4/20/2022

INCLUDES EXISTING STOCKPILES. SPOILS ASSOCIATED WITH BUILDING FOOTING TRENCHES, RETAINING WALL TRENCHES.

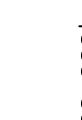

- C-5 PRELIMINARY WATER QUALITY PLAN /

JANTITIES FOR PLAN CHECK PURPOSES ONLY)	<del></del>	CONT 490
<u>M</u>	<b>QUANTITY</b>	SANT
V CUT	.+15,100 CY	
V FILL	-12.500 CY	٨D

# \* ASSUMPTIONS:

- BUILDING SLAB SECTION ASSUMED TO BE 8". STREET PAVEMENT SECTION ASSUMED TO BE 8".
- EARTHWORK QUANTITIES HEREON DO NOT INCLUDE SHRINKAGE OR OVER-EXCAVATION, UTILITY TRENCHES, SIDEWALK UNDERCUT, OR

# **SHEET INDEX:**

- C-O CIVIL TITLE SHEET AND DETAILS C-1 EXISTING TOPOGRAPHY & DEMOLITION PLAN C-2 PRELIMINARY SITE PLAN / PRELIMINARY FIRE ACCESS & HYDRANT PLAN

NOVATO, CA 94947

**OWNER/DEVELOPER:** 

116 ASSOCIATED INVESTORS LLC

CONTACT: STEVE MONAHAN

1101 FIFTH AVE, SUITE 300 SAN RAFAEL, CA 94901

**ARCHITECT:** 

DESIGN DRAW BUILD INC CONTACT: TYLER KOBICK 2866 WEBSTER ST OAKLAND, CA 94609

CONTACT: JEFF AMBROSIA

**CIVIL ENGINEER:** 

CONTACT: ALI MONSHIZADEH

**SOILS ENGINEER:** 

MILLER PACIFIC ENGINEERING GROUP

504 REDWOOD BLVD, SUITE 220

ONE VENTURE, SUITE 130

1223 HIGH ST

**AUBURN, 95603** 

MFKESSLER, INC.

IRVINE, CA 92618

CONTACT:

LANDSCAPE ARCHITECT:

YAMASAKI LANDSCAPE ARCHITECTURE

**TRAFFIC ENGINEER:** W-TRANS TRAFFIC CONSULTANTS MENDOCINO AVE, SUITE 201 NTA ROSA, CA 95401

### **ADDRESS:** GRAVENSTEIN HWY & ALDER AVE

COTATI, CA 94931

ASSESSOR PARCEL NO.

# APN: 046-286-021 & 144-050-009

LAND AREA: 340,745 SQUARE FEET (7.82 ACRES)

# **SURVEY NOTE:**

PROJECT SURVEY AND TOPOGRAPHY SOURCE IS SURVEY PREPARED BY ADOBE ASSOCIATES, MARCH 2003.

# **ZONING:**

CG - COMMERCIAL GRAVENSTEIN CORRIDOR

# **FLOOD ZONE:**

FLOOD ZONE X — AREAS DETERMINED TO BE OUTSIDE THE 0.2% ANNUAL CHANCE FLOOD PLAIN (500—YEAR FLOOD).

COMMUNITY MAP NO. 06097C0878E DATED: DECEMBER 02, 2008.



ROHNERT PARK EXPY.

ENTERPRISE DR.

VICINITY MAP

**UTILITY PURVEYORS:** 

(707) 665-3631

STORM DRAIN

(707) 665-3638

(707) 665 - 363

(800) 743-5000

(800) 743-5000

(855) 837-9042

TRASH/REFUSE

(800) 243-0291

RECOLOGY SONOMA MARIN

**TELEPHONE** 

ELECTRICITY PG&E

SEWER
CITY OF COTATI PUBLIC WORKS DEPARTMENT

CITY OF COTATI PUBLIC WORKS DEPARTMENT

CITY OF COTATI PUBLIC WORKS DEPARTMENT

MARDONE AVE

SANTA ALICIA DR

# **COTATI VILLAGE COMMUNITY**

**DECEMBER 18, 2023** COTATI, CA

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THE COPYRIGHT OF THIS DRAWING IS VESTED

- A PRIVATE STREET(BATCHELOR LANE) IS PROPOSED TO CONNECT ALDER AVE WITH A FUTURE DEVELOPMENT TO THE EAST. ANOTHER FUTURE STREET (VILLAGE AVE) IS PLANNED ALONG THE EASTERN EDGE OF THE PROJECT. THIS WILL CONNECT TO THE FUTURE WIDENING AND SIGNALIZATION OF HIGHWAY 17 (GRAVENSTEIN HWY).
- NO IMPROVEMENTS ARE PROPOSED ALONG HIGHWAY 116 (GRAVENSTEIN HWY) WITH THIS
- DEVELOPMENT. THE PROPOSED IMPROVEMENTS DO NOT CONFLICT WITH THE FUTURE CUL-DE-SAC MODIFICATIONS TO ALDER AVE. THE CURB RETURN ON THE SOUTH SIDE OF BATCHELOR CAN REMAIN IN PLACE AND THE NEW CURB CAN
- FIVE (5) RESIDENTIAL BUILDINGS ARE PROPOSED, THE THREE (3) BUILDINGS ALONG HIGHWAY 116 (GRAVENSTEIN HWY) WILL CONTAIN SOME COMMERCIAL/RETAIL AND RESIDENTIAL UNITS.

CONNECT DIRECTLY.



CIVIL TITLE SHEET AND DETAILS

C0-0






# COTATI VILLAGE COMMUNITY

**DECEMBER 18, 2023** COTATI, CA


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- 2003 BY ADOBE ASSOCIATES, INC. 4. FIVE (6) OAK TREES ARE TO BE SAVED NEAR
- THE CENTER OF THE SITE. 5. FOUR (4) OAK TREES ARE TO BE REMOVED
- ALONG WITH SEVERAL OTHER NON-PROTECTED SPECIES OF TREES. 6. TWO EXISTING STOCKPILES ARE LOCATED ON
- THE PROPERTY. 7. THE EXISTING CURB RETURNS AT ALDER AND FUTURE BATCHELOR SHALL BE REMOVED AND RECONSTRUCTED TO COMPLY WITH CITY
- MINIMUM CURB RETURN RADIUS. 8. THERE ARE NO ON-SITE WELLS, SEPTIC TANKS, OR UNDERGROUND FUEL STORAGE TANKS.
- 9. NO EXISTING STRUCTURES EXIST.
- 10. NO DEMOLITION PLAN IS REQUIRED.

BENCHMARK: BEING A STANDARD TABLET STAMPED "5 GWM 1945 101" LOCATED IN THE TOP OF THE WEST END OF THE SOUTH HEADWALL OF A CONCRETE CULVERT ON THE SOUTHERLY SIDE OF GRAVENSTEIN HIGHYWAY (116), 530' WESTERLY OF ALDER AVENUE. NGVD 1929 DATUM, ELEVATION-100.48'. (NAVD 1988 DATUM ELEVATION=103.25' PER CARLISLE MACY TENTATIVE MAP FOR "SOUTH SONOMA BUSINESS PARK".) COTATI COTTAGES USED 102.81'.

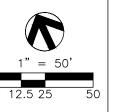

**EXISTING** TOPOGRAPHY & DEMOLITION PLAN



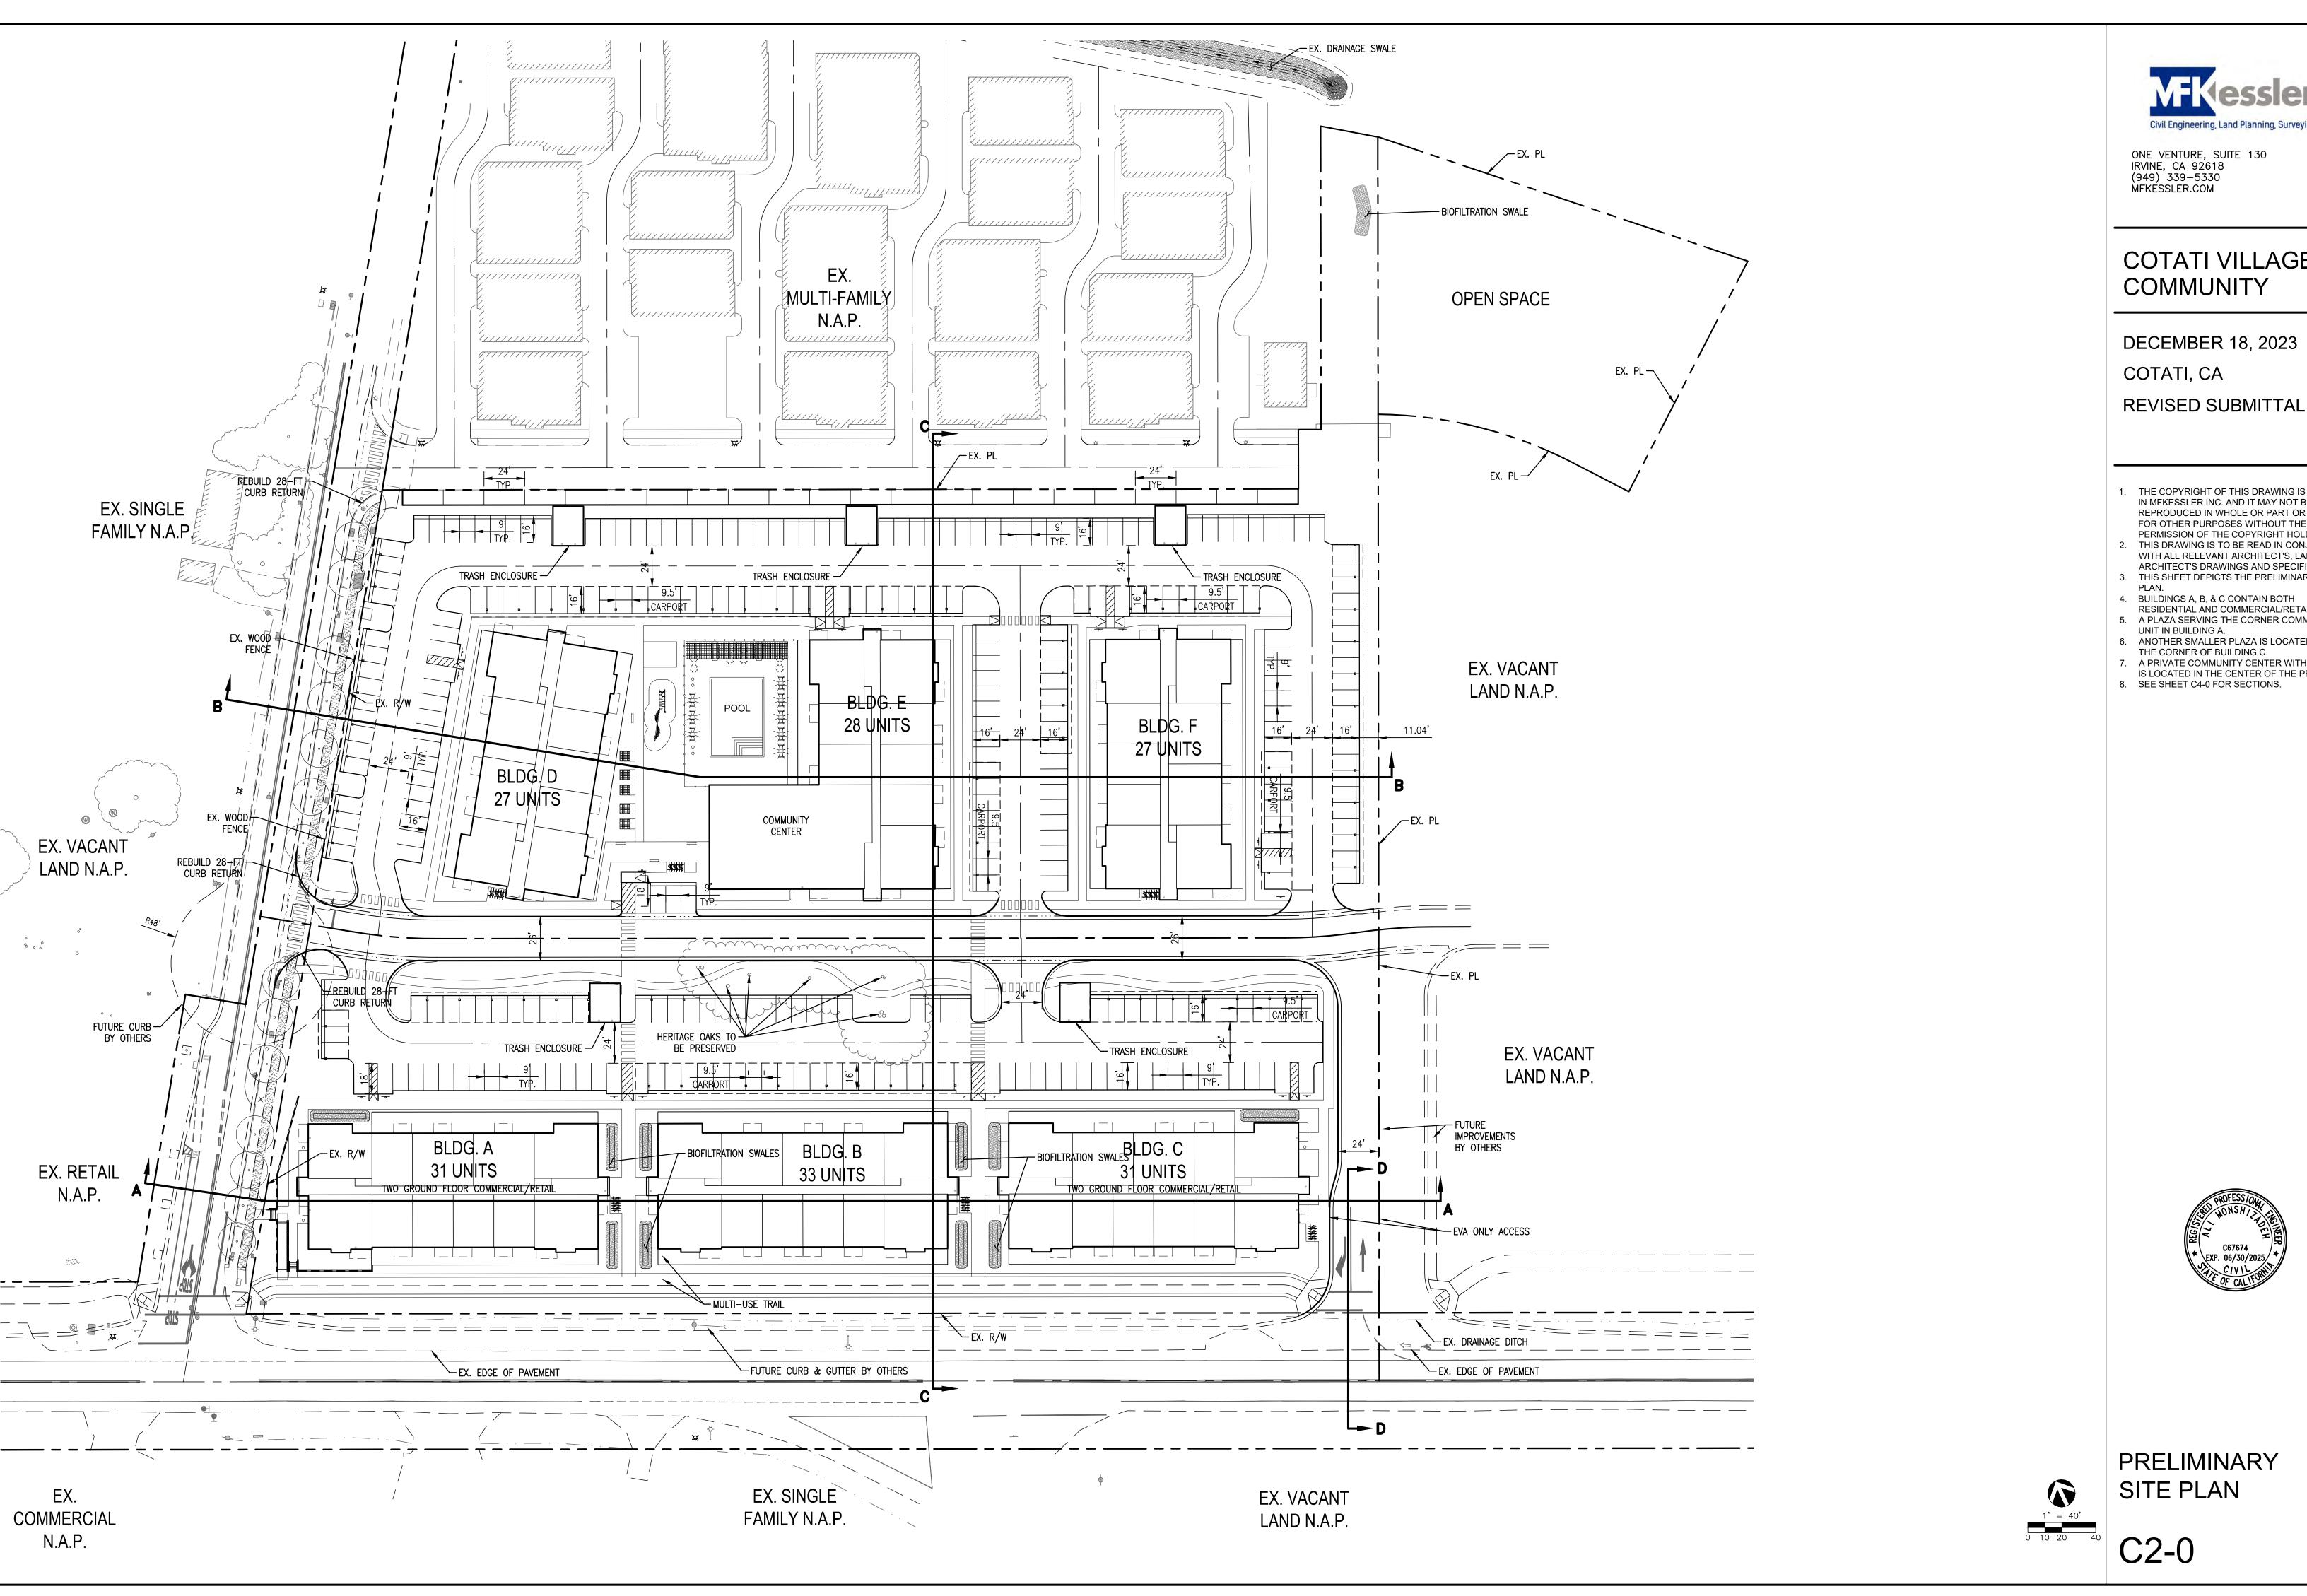

# COTATI VILLAGE COMMUNITY


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- 4. BUILDINGS A, B, & C CONTAIN BOTH RESIDENTIAL AND COMMERCIAL/RETAIL UNITS. 5. A PLAZA SERVING THE CORNER COMMERCIAL
- UNIT IN BUILDING A. 6. ANOTHER SMALLER PLAZA IS LOCATED NEAR THE CORNER OF BUILDING C.
- 7. A PRIVATE COMMUNITY CENTER WITH A POOL
- IS LOCATED IN THE CENTER OF THE PROJECT. 8. SEE SHEET C4-0 FOR SECTIONS.



**PRELIMINARY** SITE PLAN

C2-0



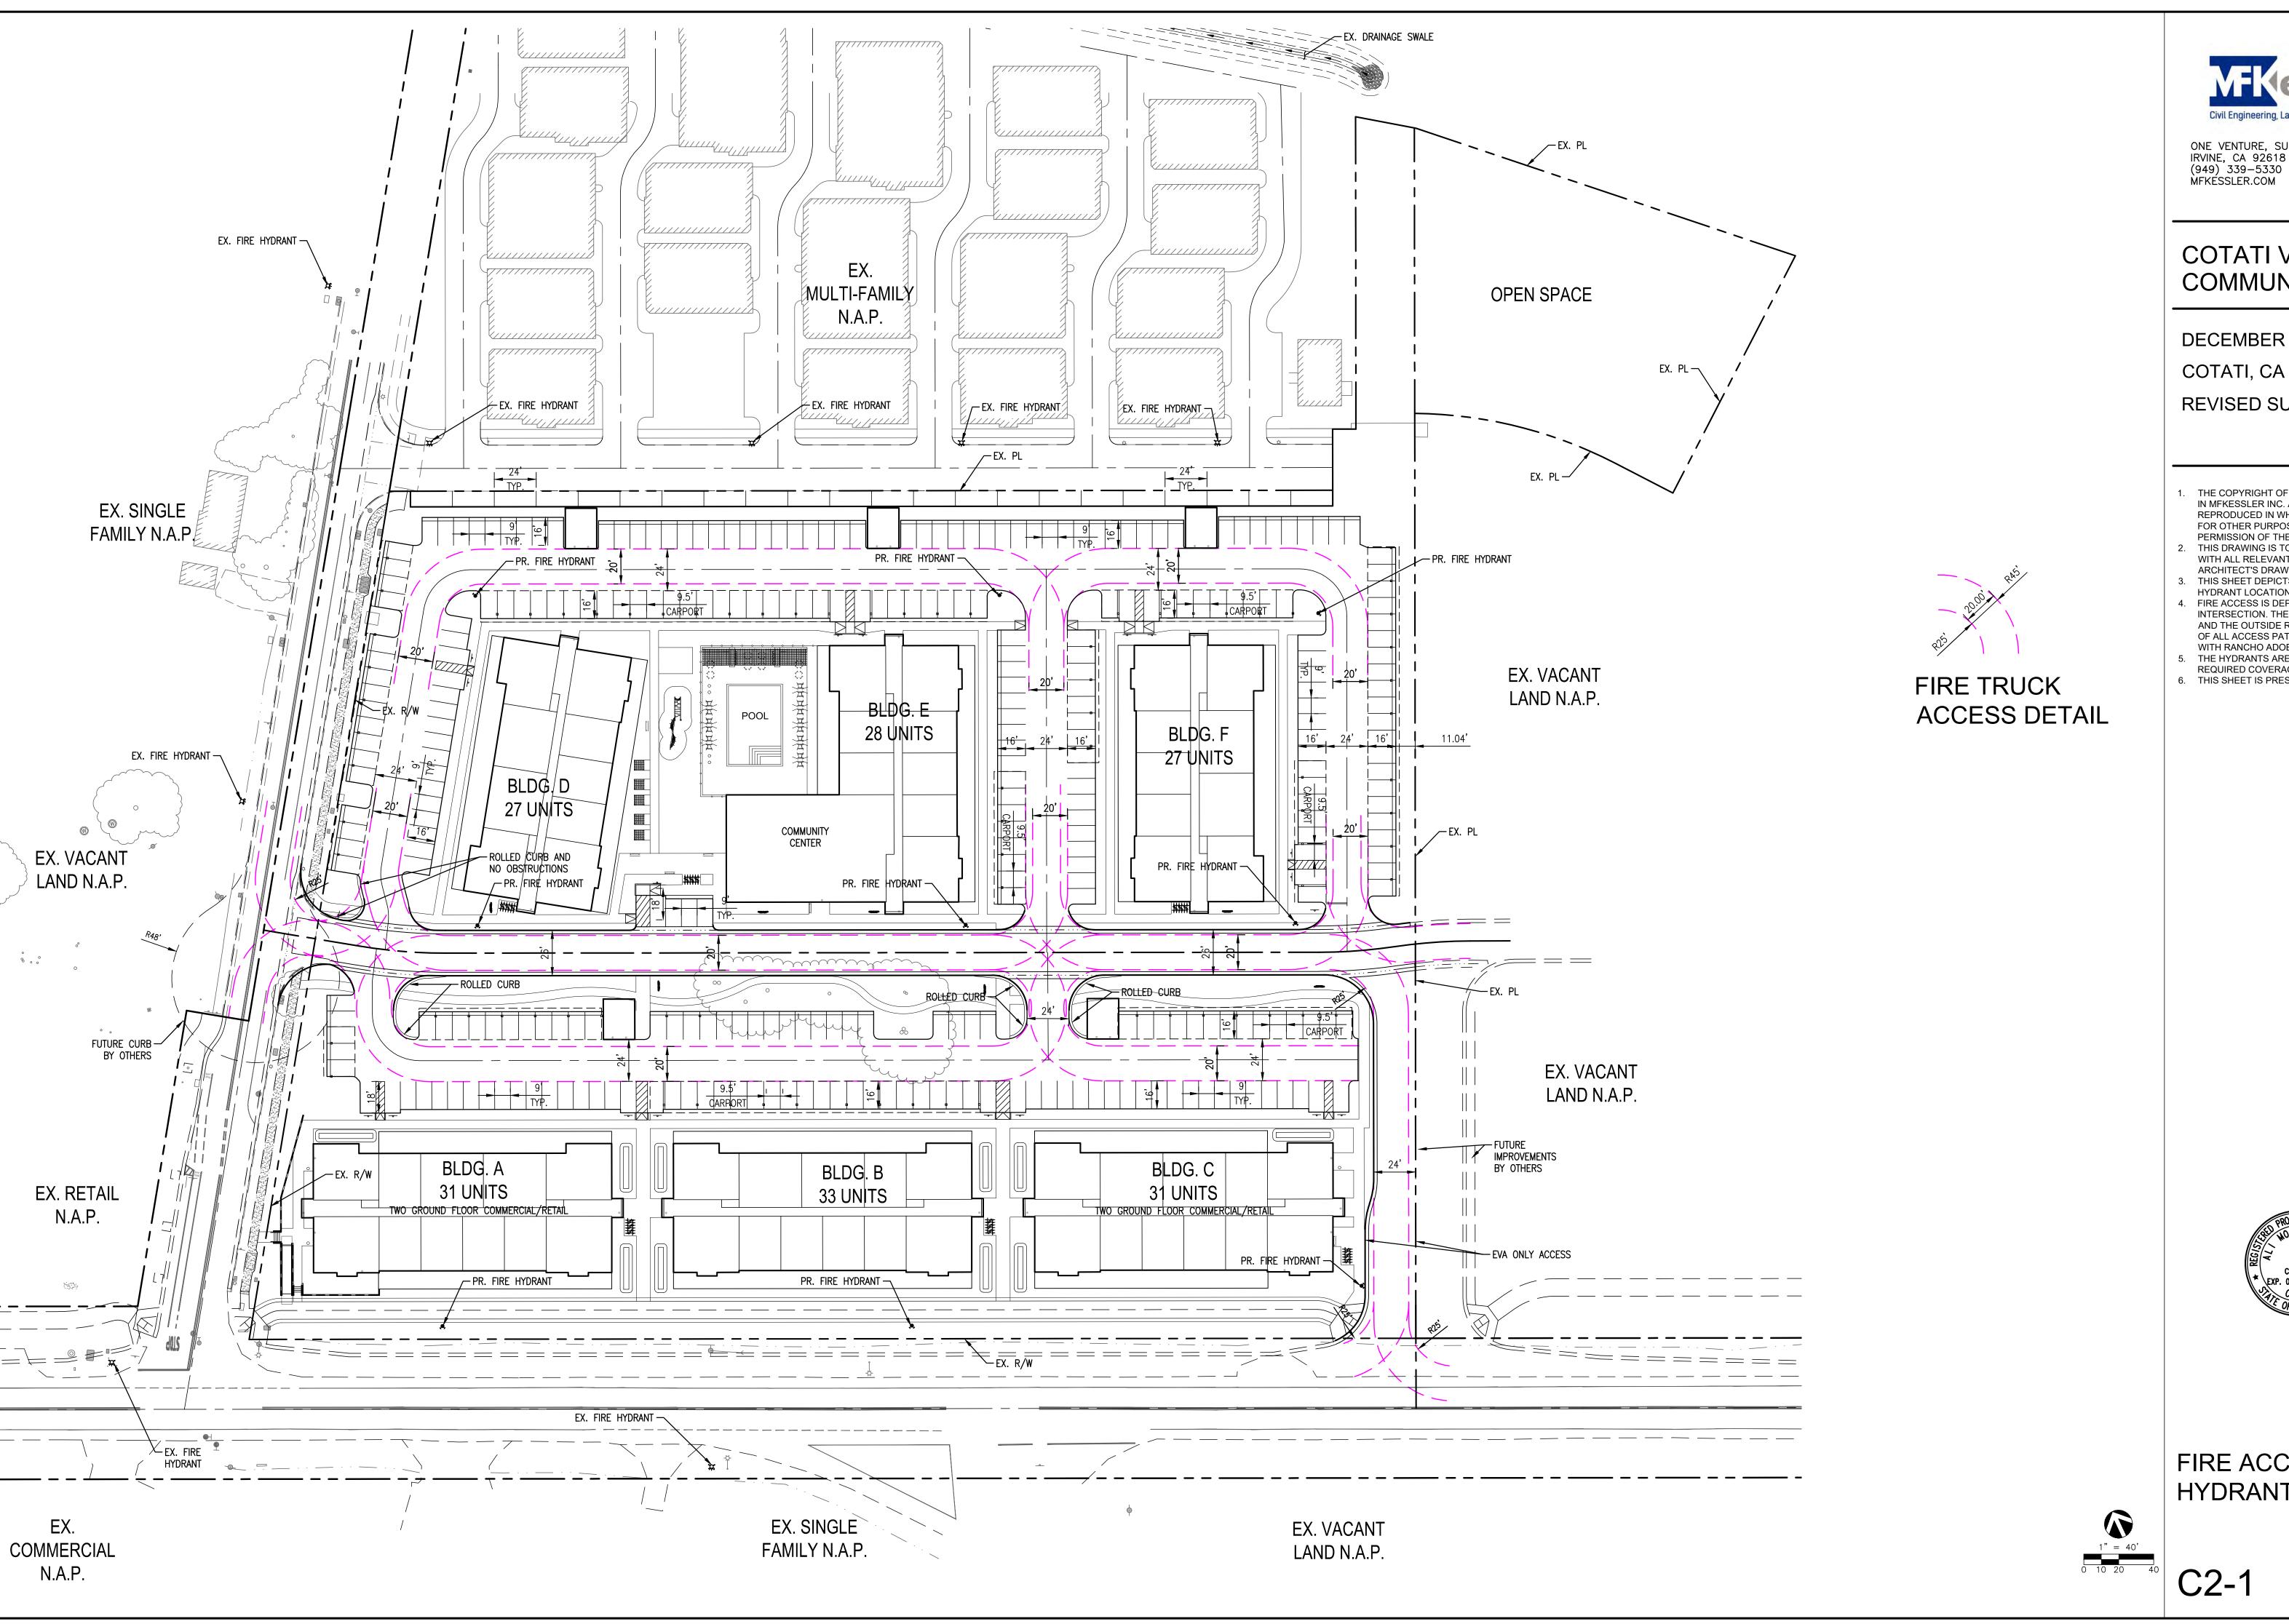

# COTATI VILLAGE COMMUNITY


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- HYDRANT LOCATIONS. FIRE ACCESS IS DEPICTED FOR EACH AND THE OUTSIDE RADIUS IS 45-FT. THE WIDTH OF ALL ACCESS PATHS IS 20-FT. THIS COMPLIES
- THE HYDRANTS ARE LOCATED TO PROVIDE THE REQUIRED COVERAGE OF EACH BUILDING. 6. THIS SHEET IS PRESENTED IN COLOR.



FIRE ACCESS & HYDRANT PLAN



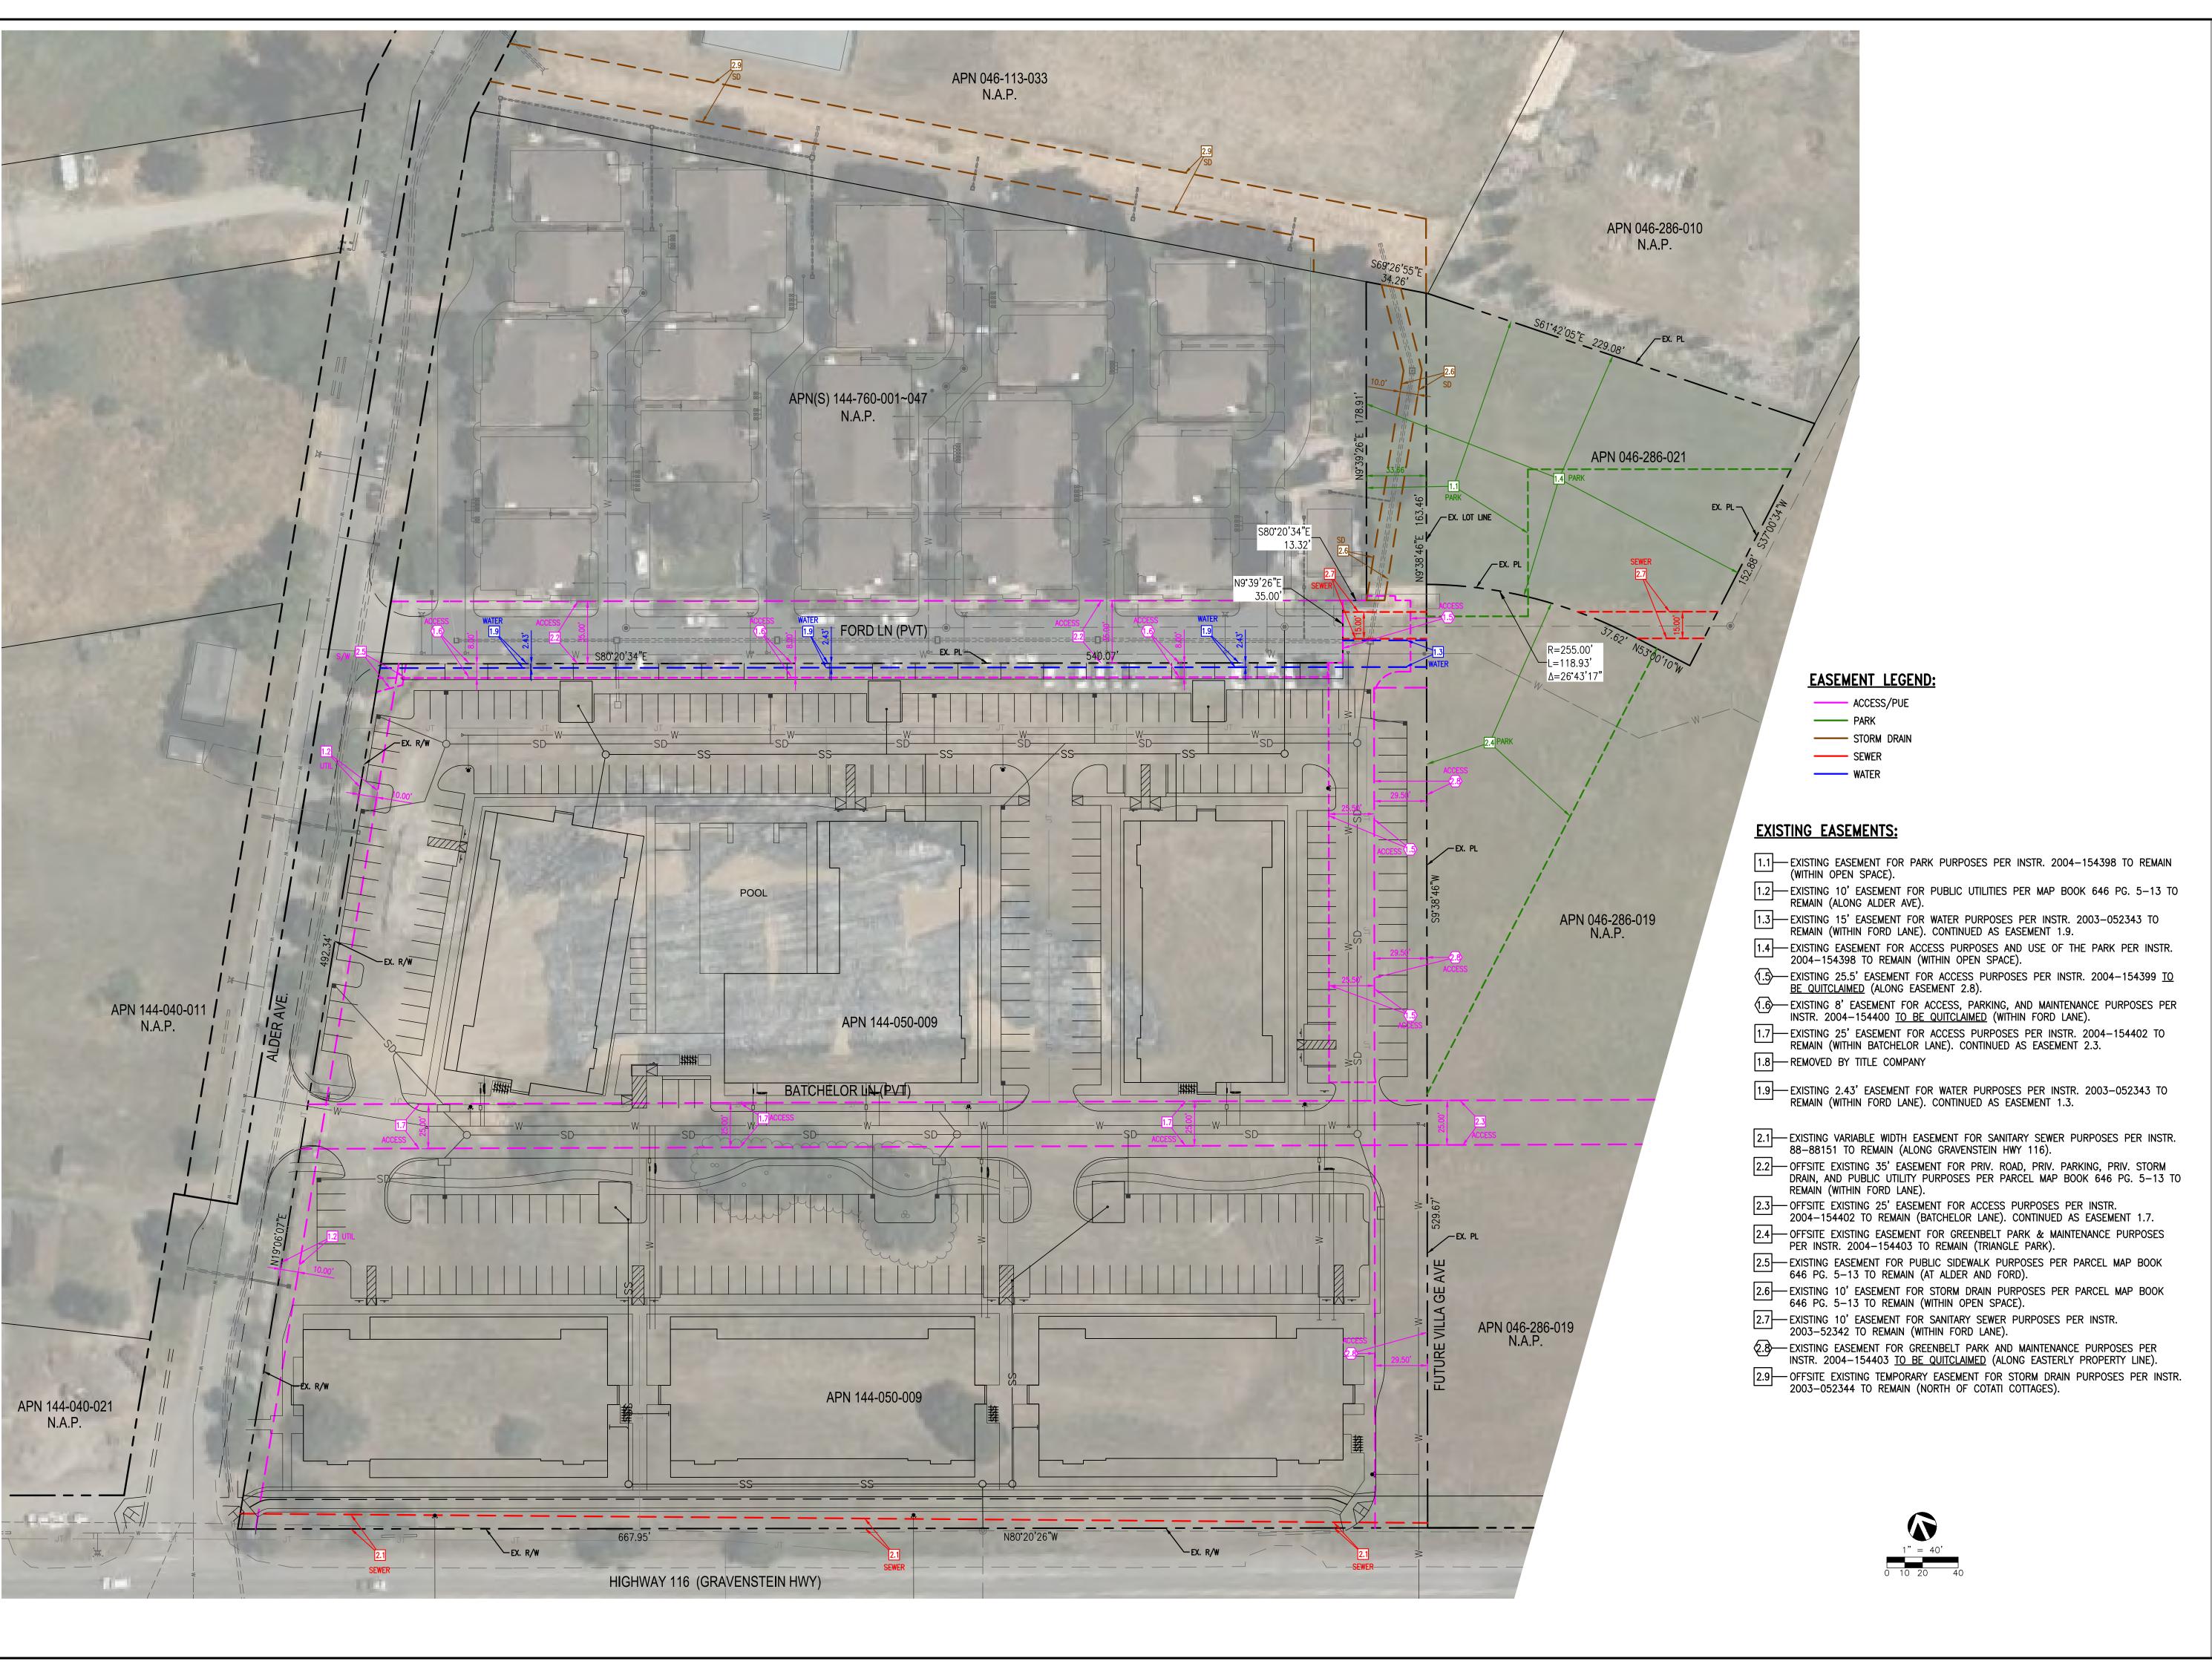

# COTATI VILLAGE COMMUNITY

DECEMBER 18, 2023 COTATI, CA REVISED SUBMITTAL


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   THIS SHEET DEPICTS THE EXISTING
- EASEMENTS FOR THE SITE INCEDDING OF SITE ASSEMBLY OF SITE OF S
- DATED 10/25/22) ARE IDENTIFIED ON THIS PLA

  5. SEVERAL EASEMENTS ARE TO BE VACATED
  WITH THE COOPERATION OF THE BENEFITING
  ORGANIZATIONS.
- 6. THIS SHEET IS PRESENTED IN COLOR.7. REVISED TO MATCH NEW SITE PLAN.



EXISTING EASEMENTS

C3-0

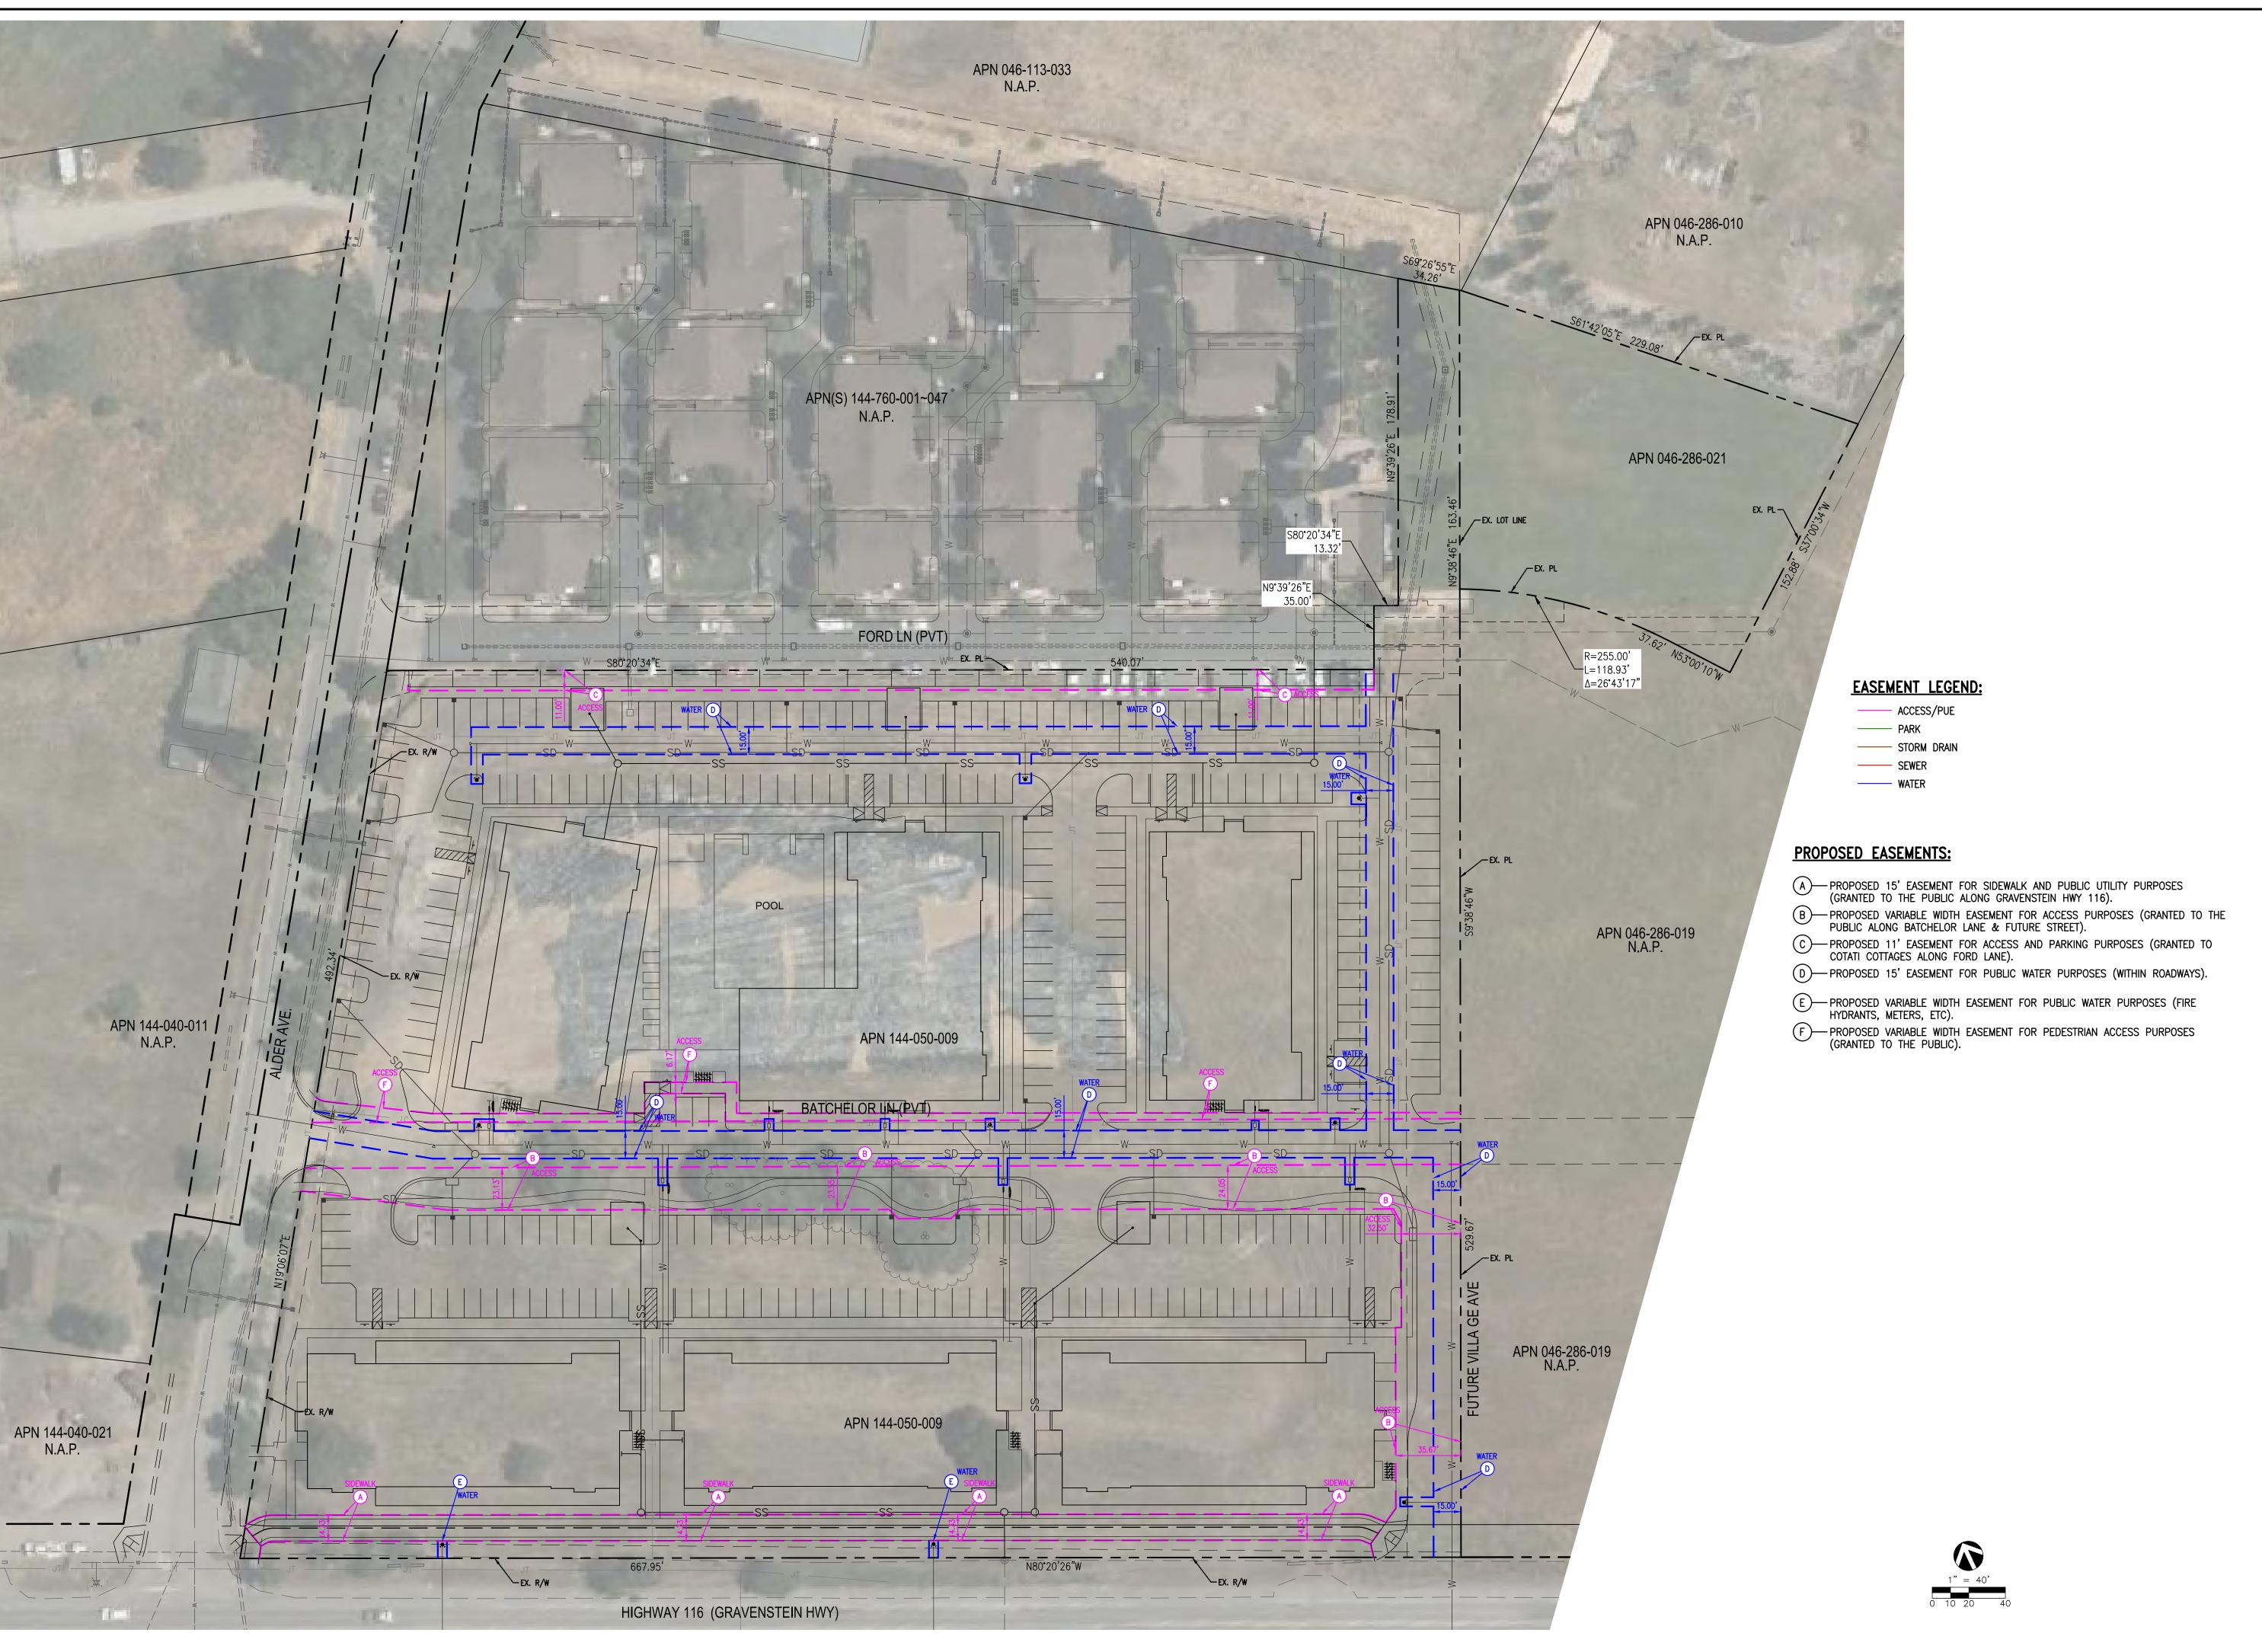



# COTATI VILLAGE COMMUNITY

**DECEMBER 18, 2023** COTATI, CA

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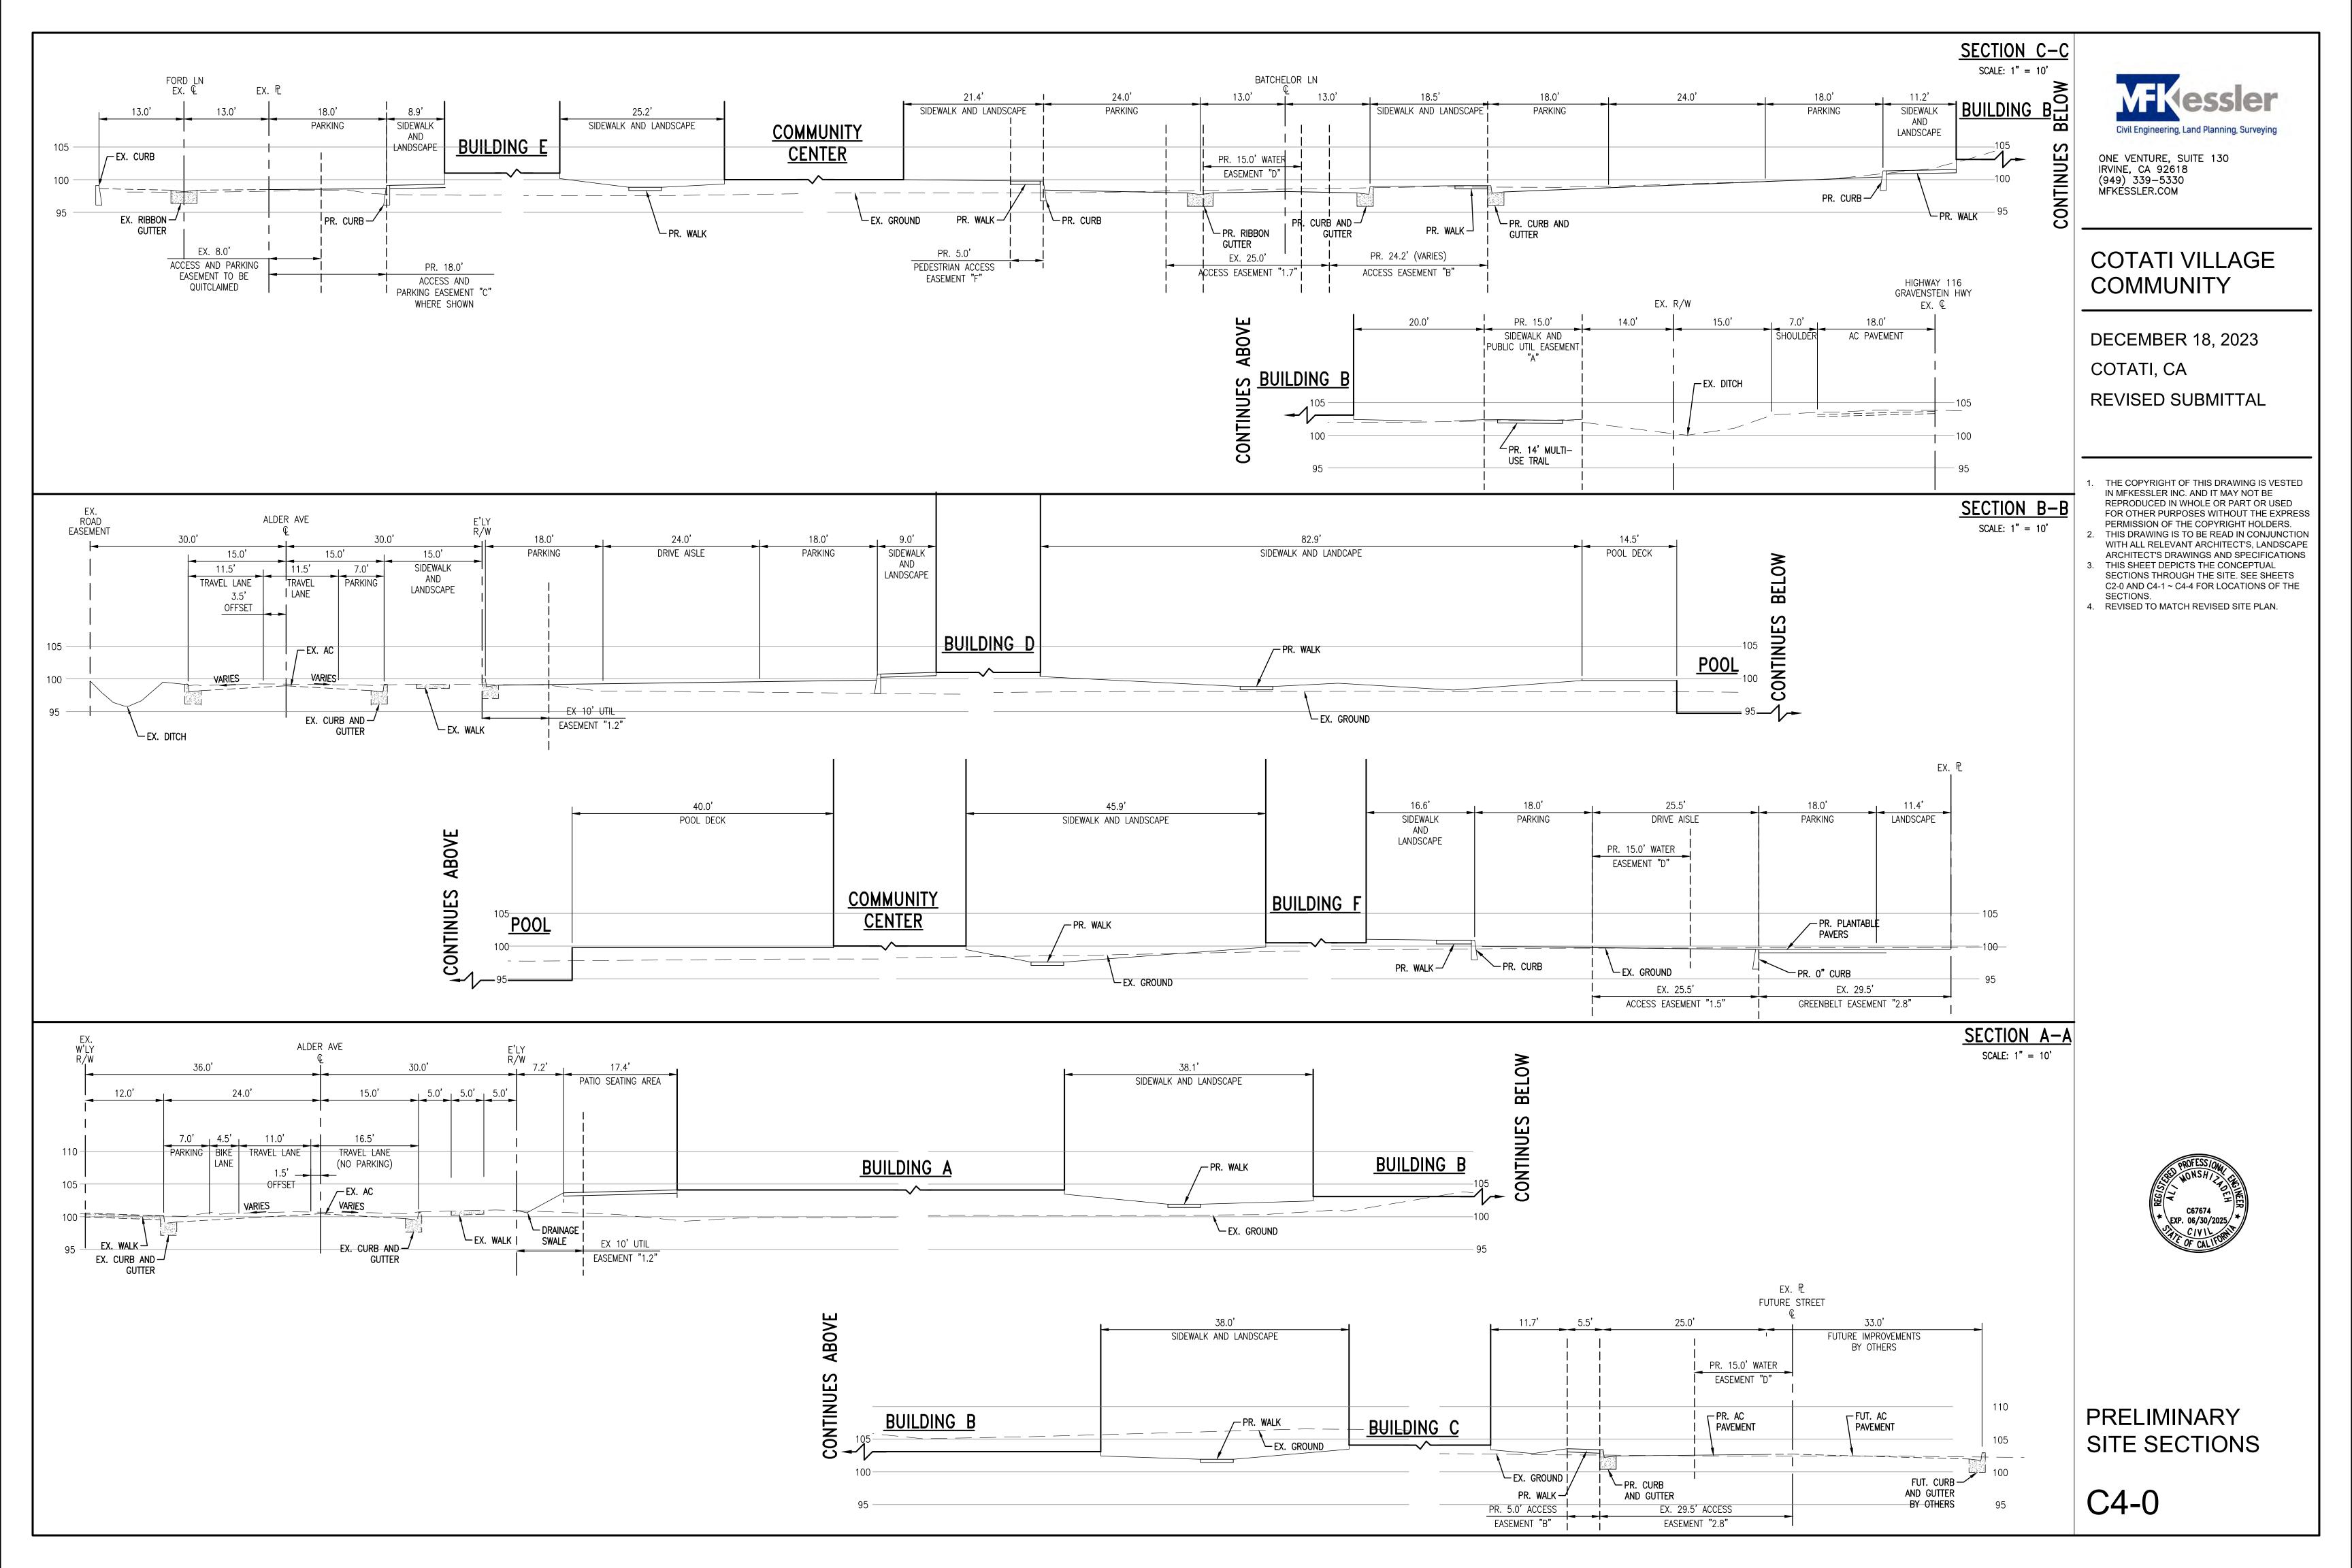
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- WITH ALL RELEVANT ARCHITECT'S, LANDSCAPE ARCHITECT'S DRAWINGS AND SPECIFICATIONS THIS SHEET DEPICTS THE PROPOSED
- EASEMENTS FOR THE SITE.


  SOME PROPOSED EASEMENTS WILL REPLACE
- EXISTING EASEMENTS.
- 5. THIS SHEET IS PRESENTED IN COLOR. 6. REVISED TO MATCH NEW SITE PLAN.



PROPOSED **EASEMENTS** 

C3-1



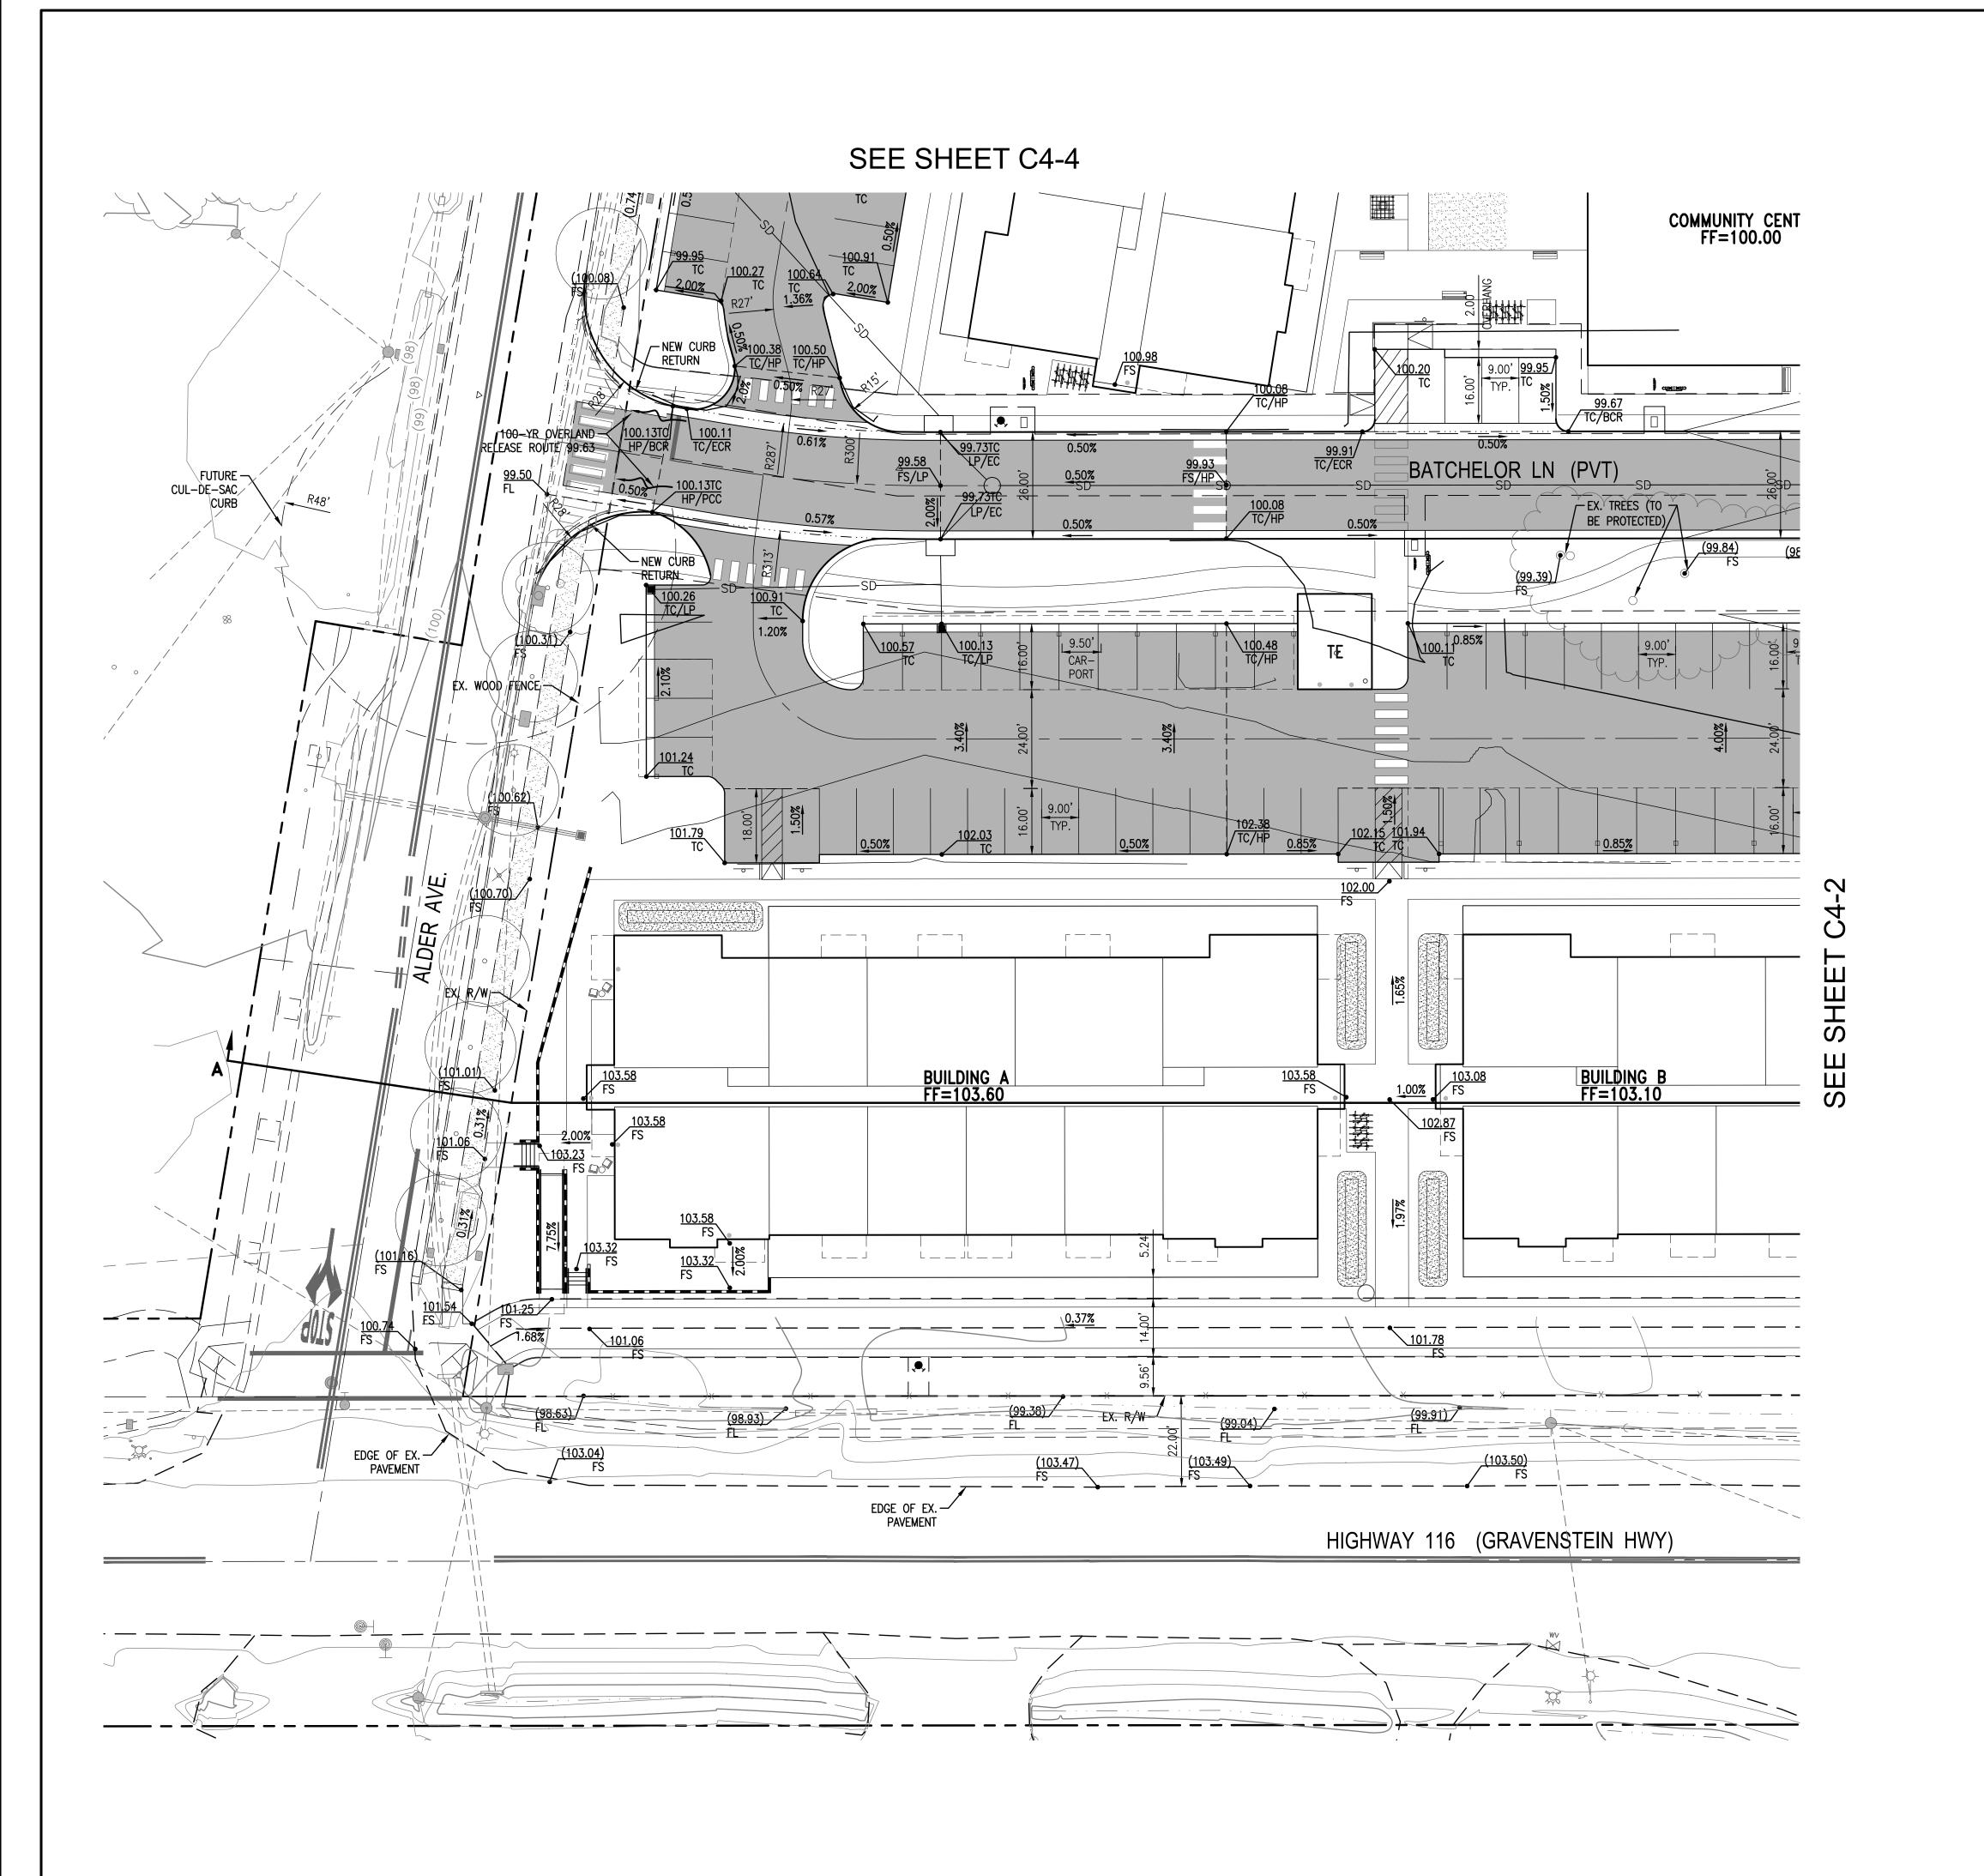




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   THIS SHEET DEPICTS THE PRELIMINARY
- GRADING AND DRAINAGE FOR BUILDINGS A & B.

  4. THE FINISHED FLOORS OF A & B ARE SET SO
  THEY ARE HIGHER THAN THE PROPOSED
  HIGHWAY 116 (GRAVENSTEIN HWY)
  IMPROVEMENTS.
- 5. ADA ACCESSIBILITY TO THE COMMERCIAL/ RETAIL UNITS IS MAINTAINED ALONG THE FRONTAGE OF HIGHWAY 116.
- 6. REVISED TO MATCH REVISED SITE PLAN.






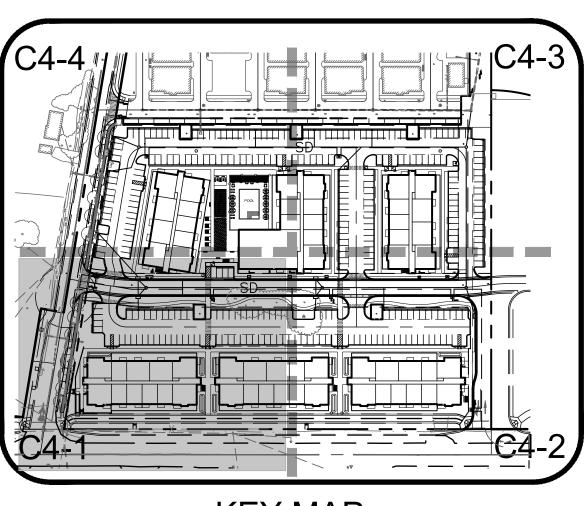

PRELIMINARY GRADING PLAN

C4-1

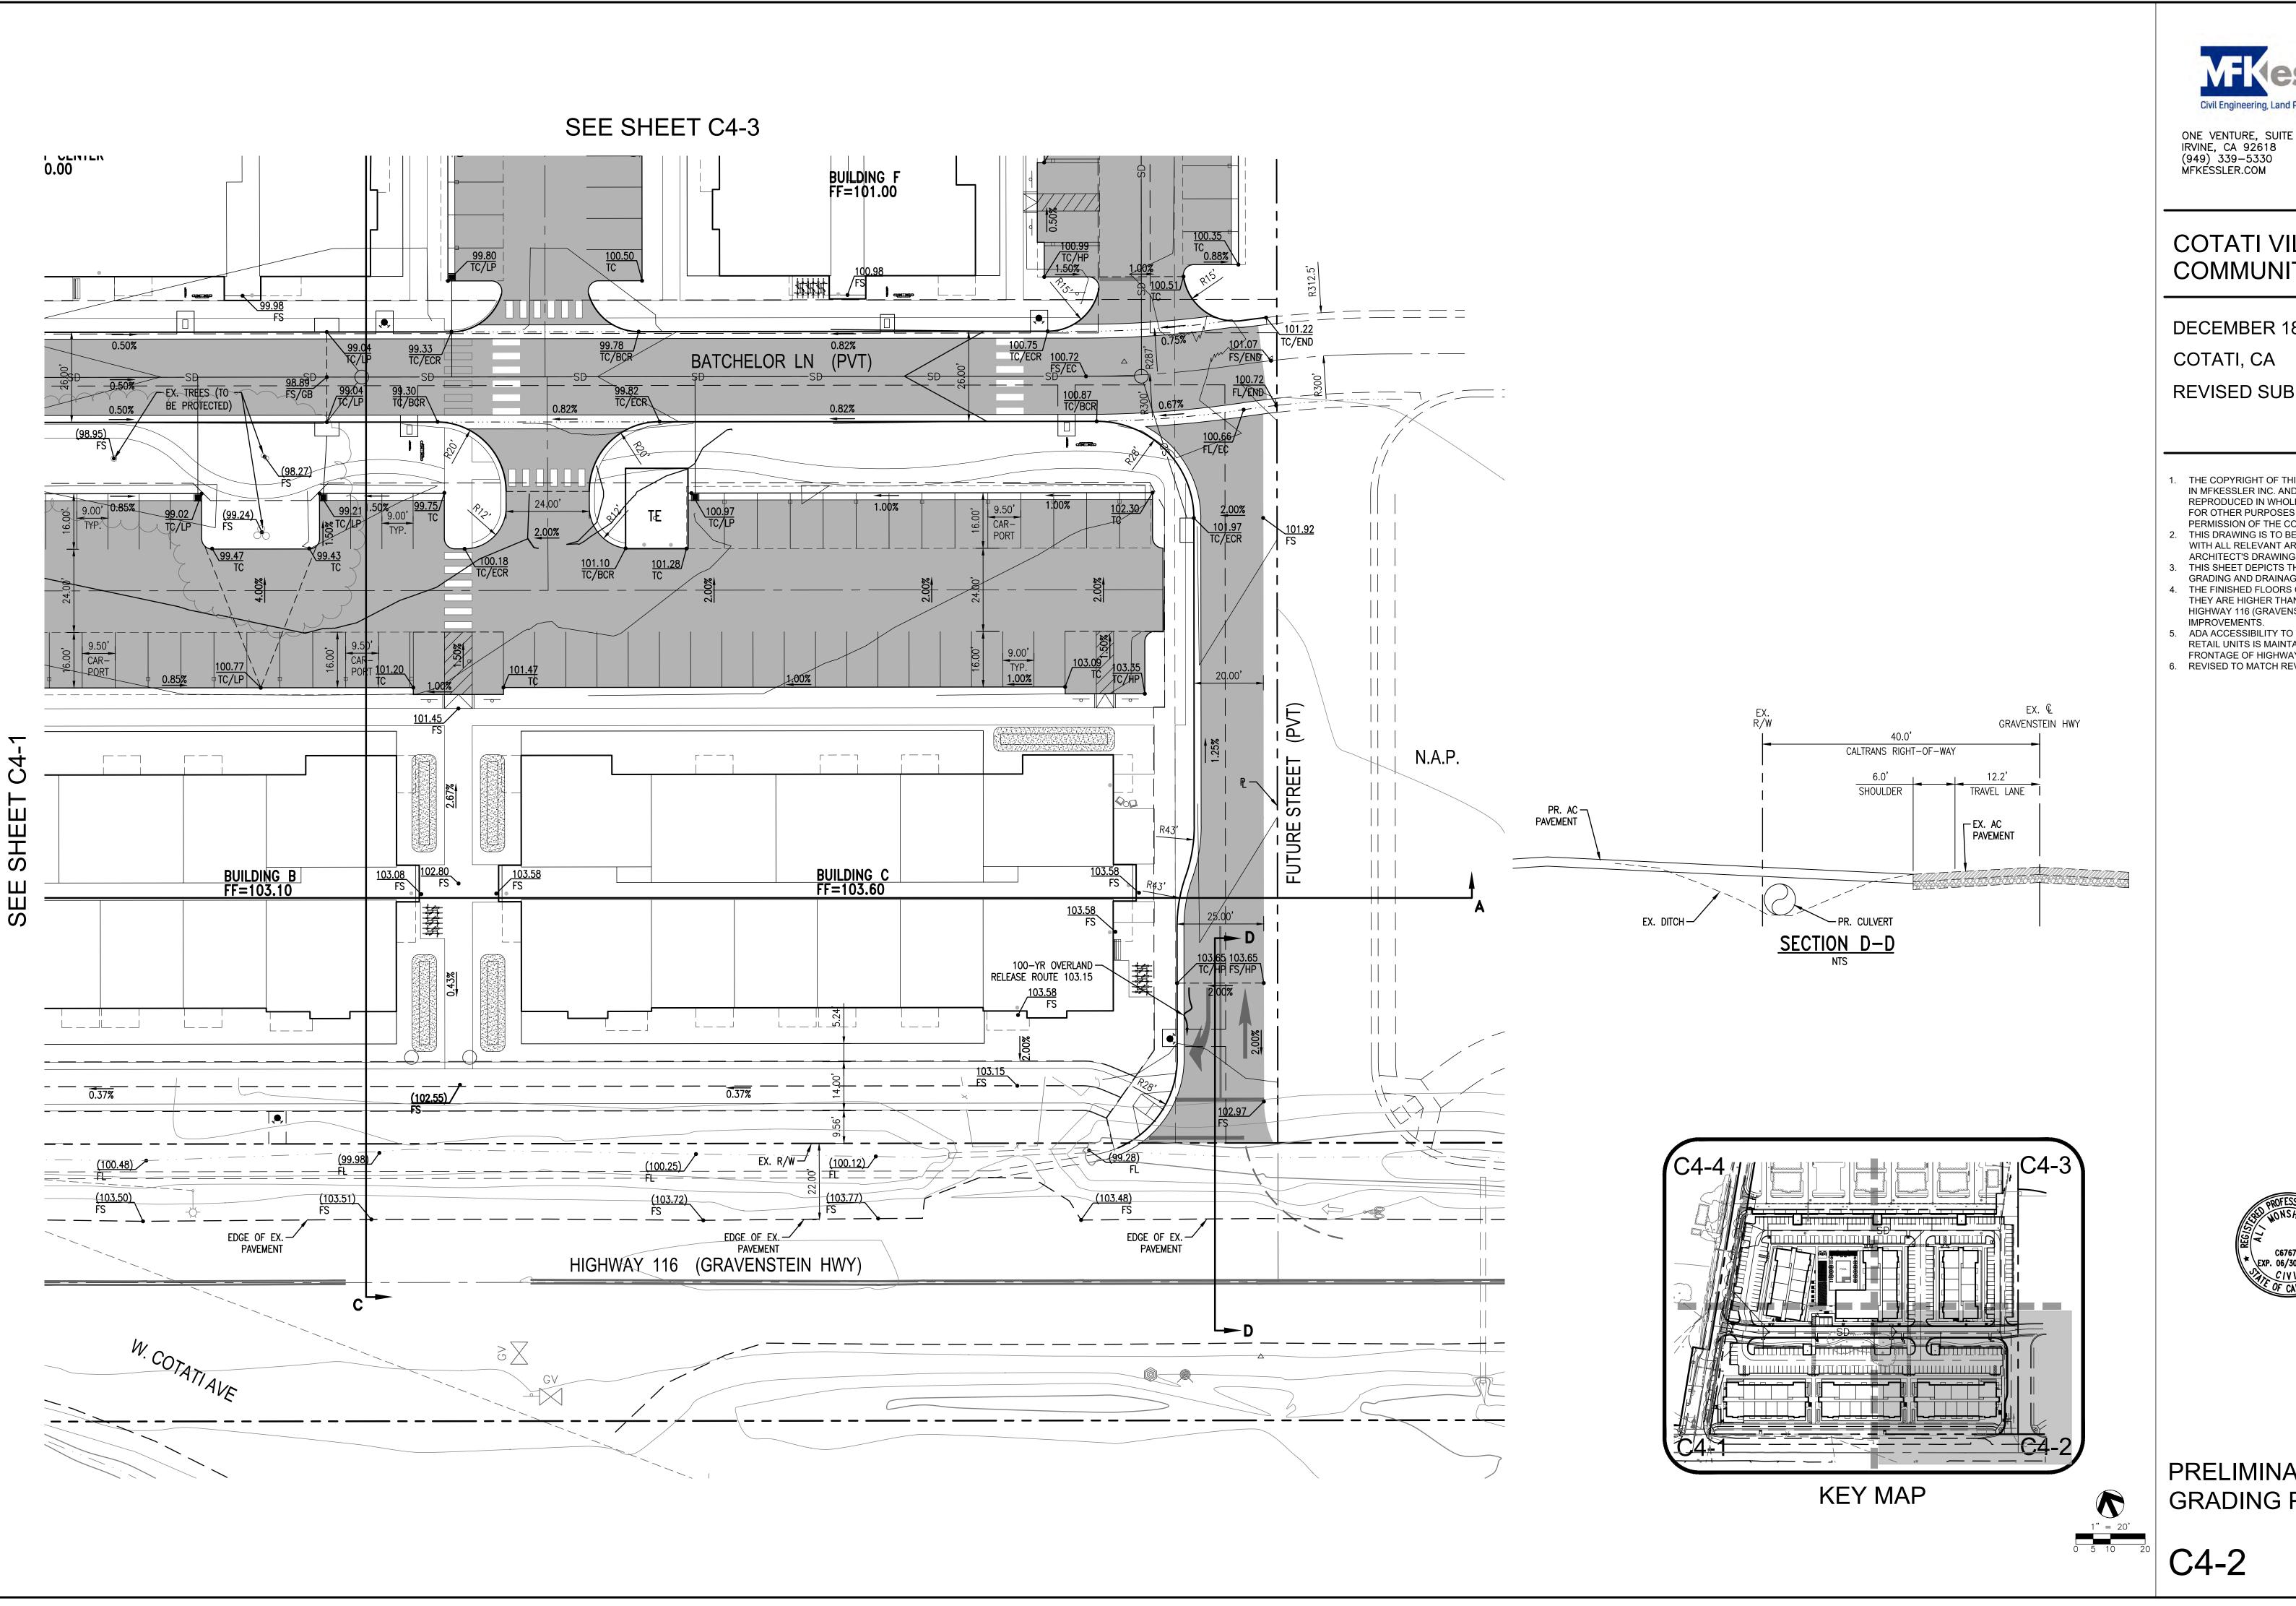



# COTATI VILLAGE COMMUNITY


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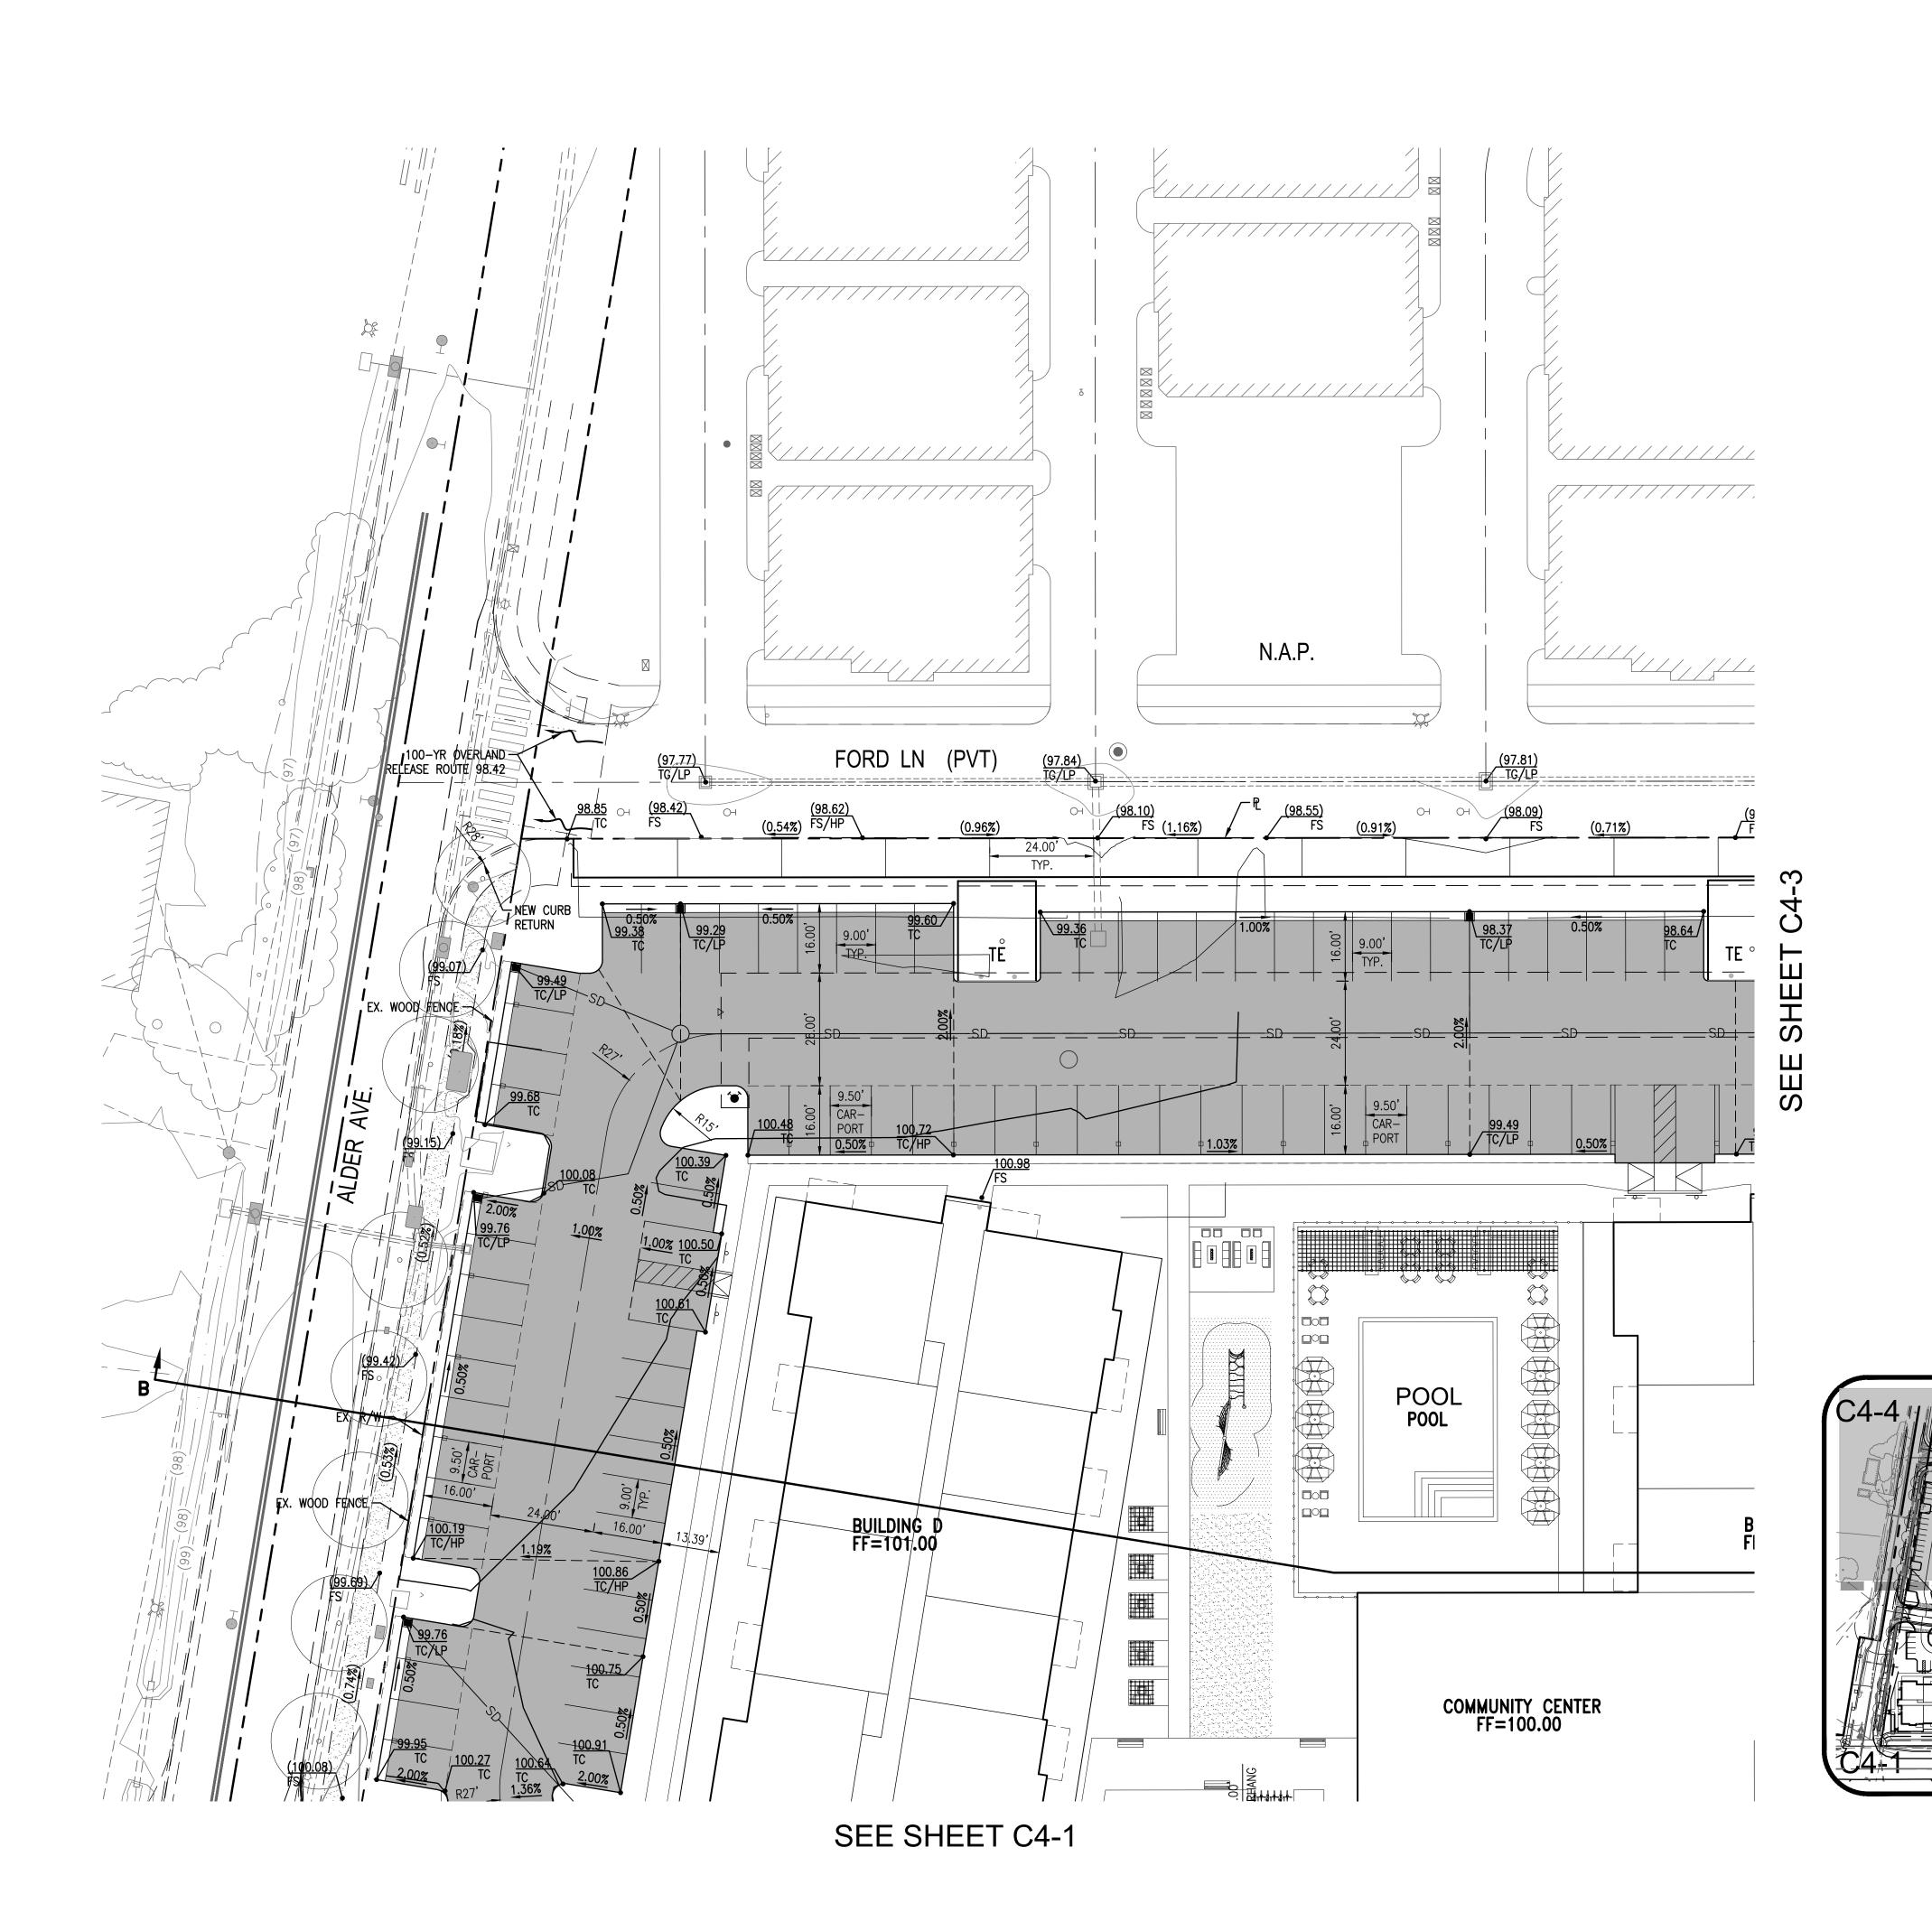
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- THIS SHEET DEPICTS THE PRELIMINARY GRADING AND DRAINAGE FOR BUILDINGS B & C THE FINISHED FLOORS OF B & C ARE SET SO THEY ARE HIGHER THAN THE PROPOSED HIGHWAY 116 (GRAVENSTEIN HWY)
- IMPROVEMENTS. ADA ACCESSIBILITY TO THE COMMERCIAL/ RETAIL UNITS IS MAINTAINED ALONG THE
- FRONTAGE OF HIGHWAY 116. 6. REVISED TO MATCH REVISED SITE PLAN.



PRELIMINARY **GRADING PLAN** 





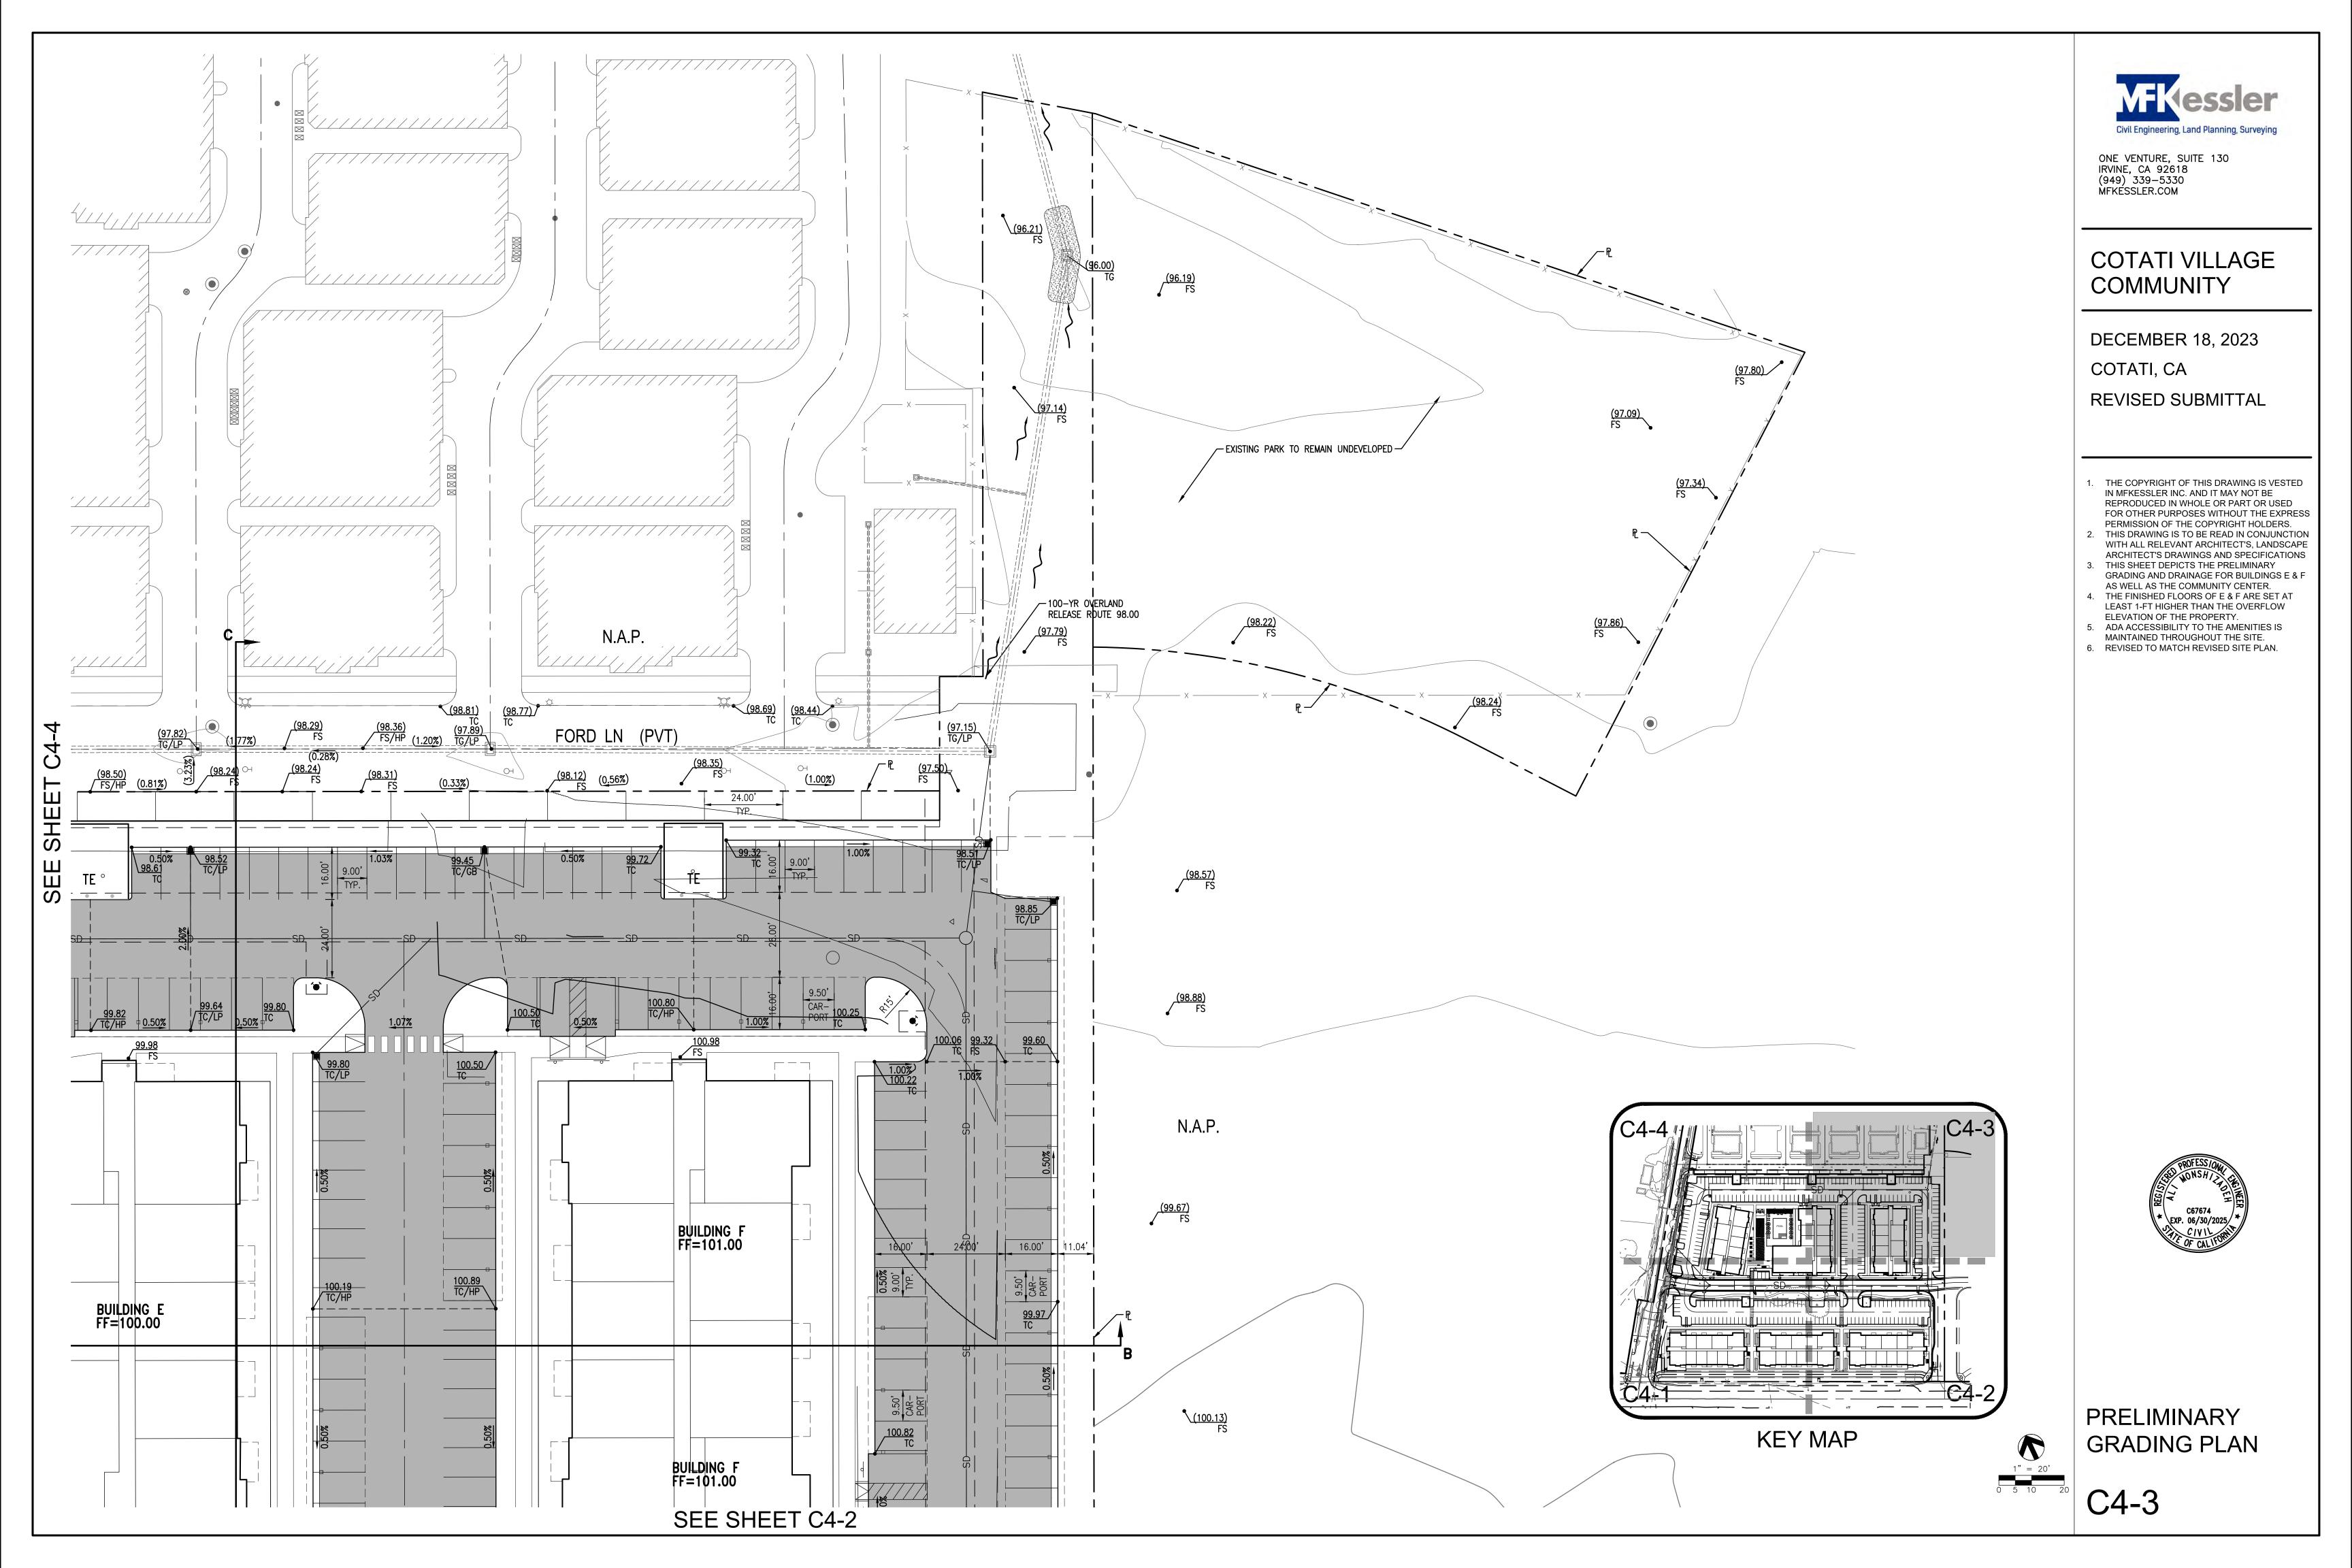

# COTATI VILLAGE COMMUNITY

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- WITH ALL RELEVANT ARCHITECT'S, LANDSCAPE
  ARCHITECT'S DRAWINGS AND SPECIFICATIONS
  3. THIS SHEET DEPICTS THE PRELIMINARY
  GRADING AND DRAINAGE FOR BUILDINGS D & E
- AS WELL AS THE COMMUNITY CENTER.


  4. THE FINISHED FLOORS OF D & E ARE SET AT LEAST 1-FT HIGHER THAN THE OVERFLOW ELEVATION OF THE PROPERTY.
- 5. ADA ACCESSIBILITY TO THE AMENITIES IS MAINTAINED THROUGHOUT THE SITE.



PRELIMINARY GRADING PLAN

C4-4

**KEY MAP** 

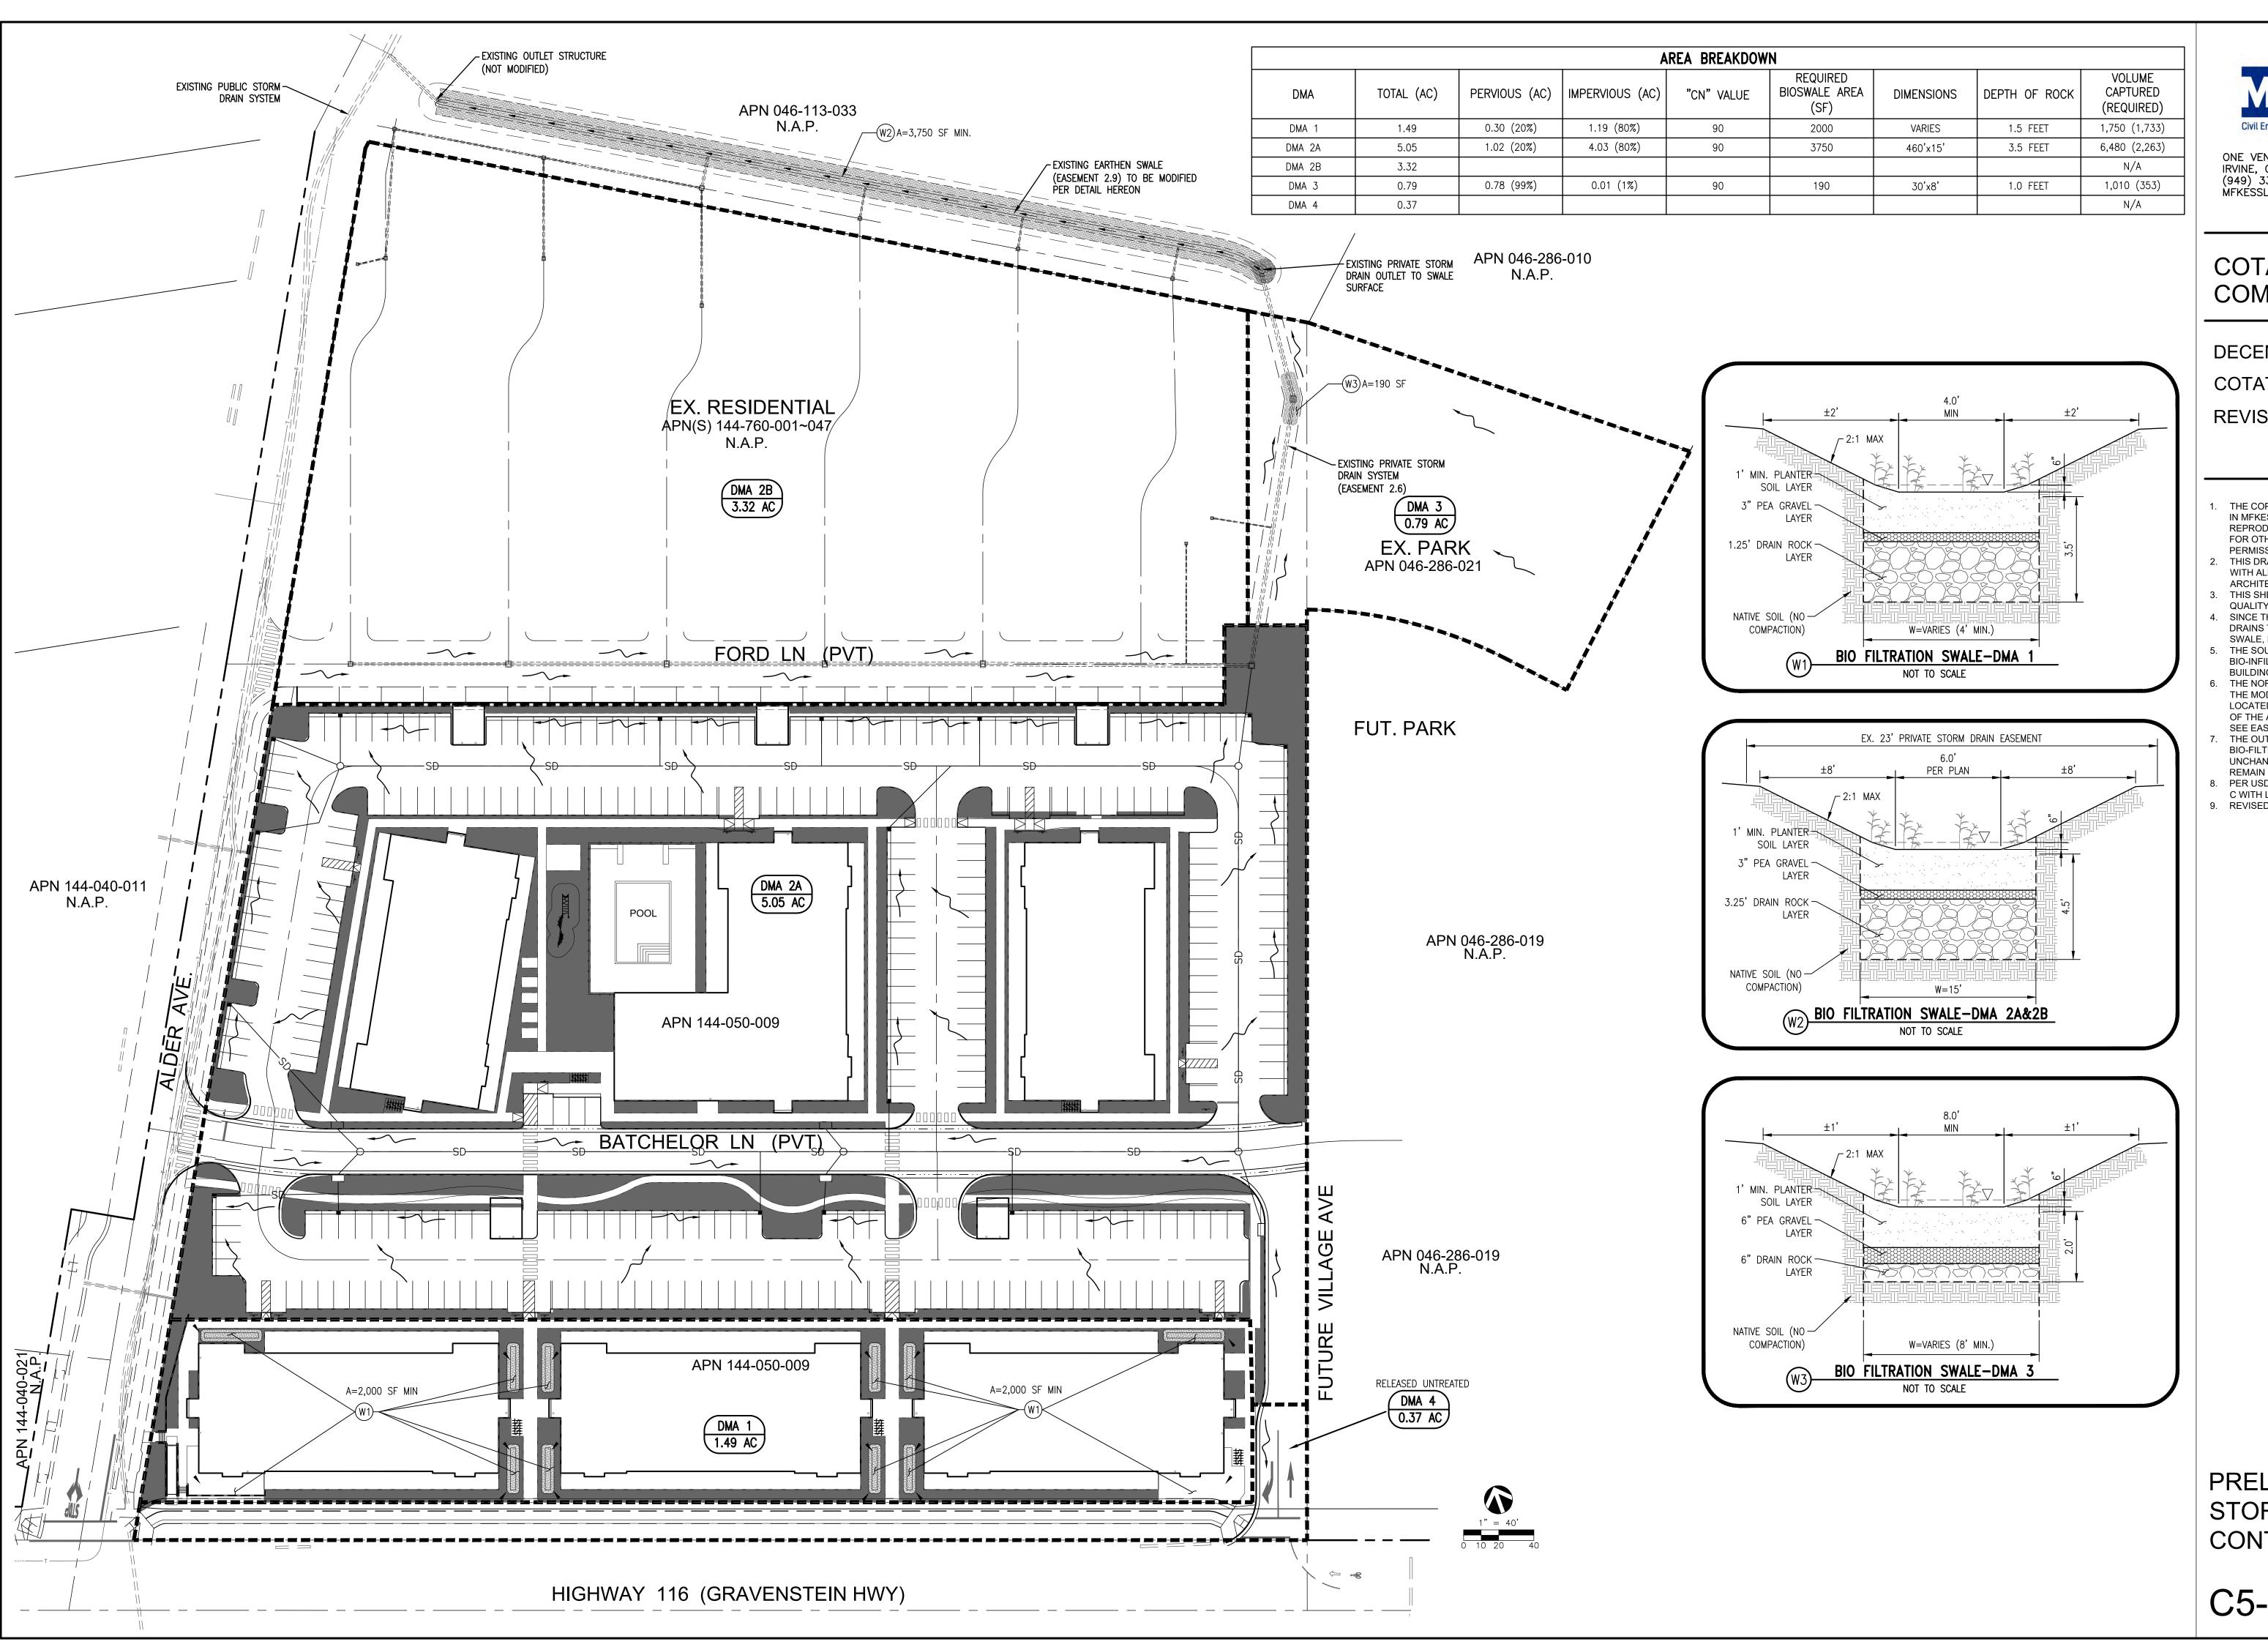



# COTATI VILLAGE COMMUNITY

**DECEMBER 18, 2023** COTATI, CA


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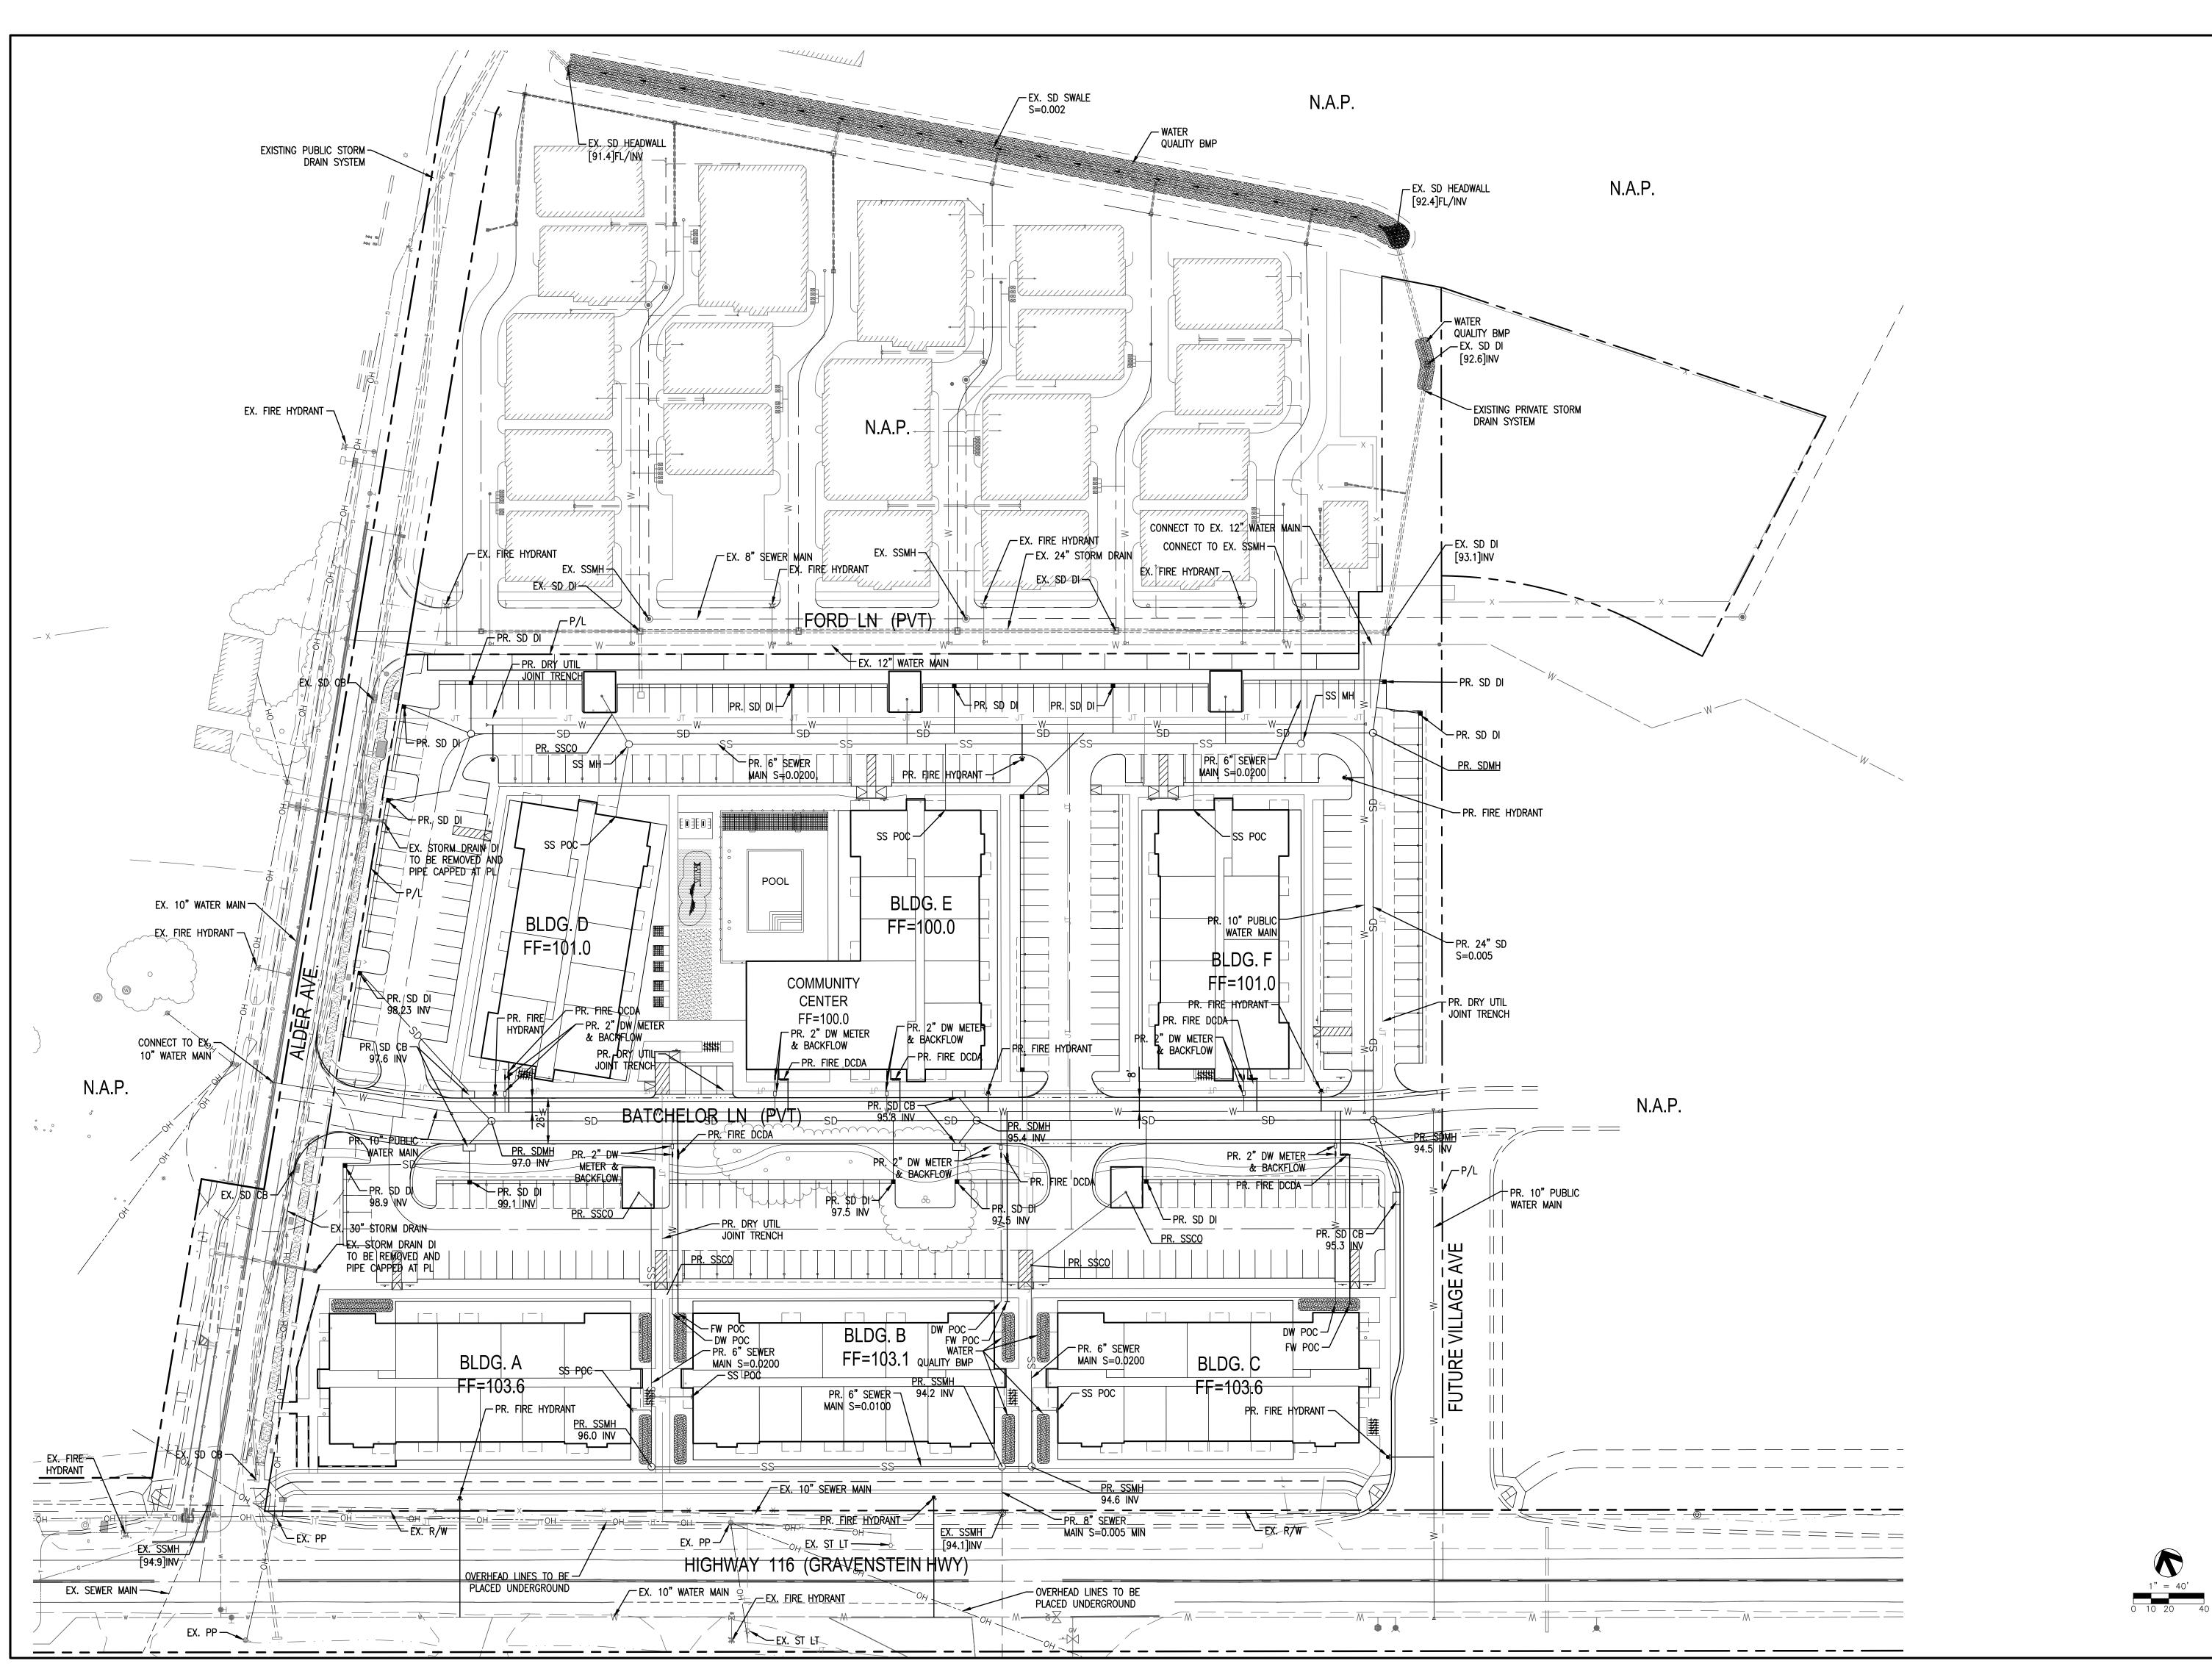
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- QUALITY LAYOUT. SINCE THE ADJACENT COTATI VILLAS TRACT DRAINS TO THE MODIFIED BIO-INFILTRATION
- SWALE, IT IS INCLUDED IN THE CALCULATIONS. THE SOUTH 19% OF THE SITE IS TREATED BY 12 BIO-INFILTRATION SWALES LOCATED BETWEEN BUILDINGS A, B, & C.
- THE NORTH 81% OF THE SITE IS TREATED IN THE MODIFIED BIO-INFILTRATION SWALE LOCATED ALONG THE NORTH PROPERTY LINE OF THE ADJACENT COTATI COTTAGES TRACT.
- SEE EASEMENTS 2.6 AND 2.9 ON SHEET C3. THE OUTLET STRUCTURE OF THE BIO-FILTRATION SWALE WILL REMAIN UNCHANGED, AND THE OUTFLOW RATE WILL
- REMAIN UNCHANGED. PER USDA GEOTECH REPORT, SOILS ARE TYPE C WITH LOW PERMEABILITY (0.05~0.2 IN/HR).
- REVISED TO MATCH NEW SITE PLAN.



**PRELIMINARY** STORMWATER CONTROL PLAN

C5-0



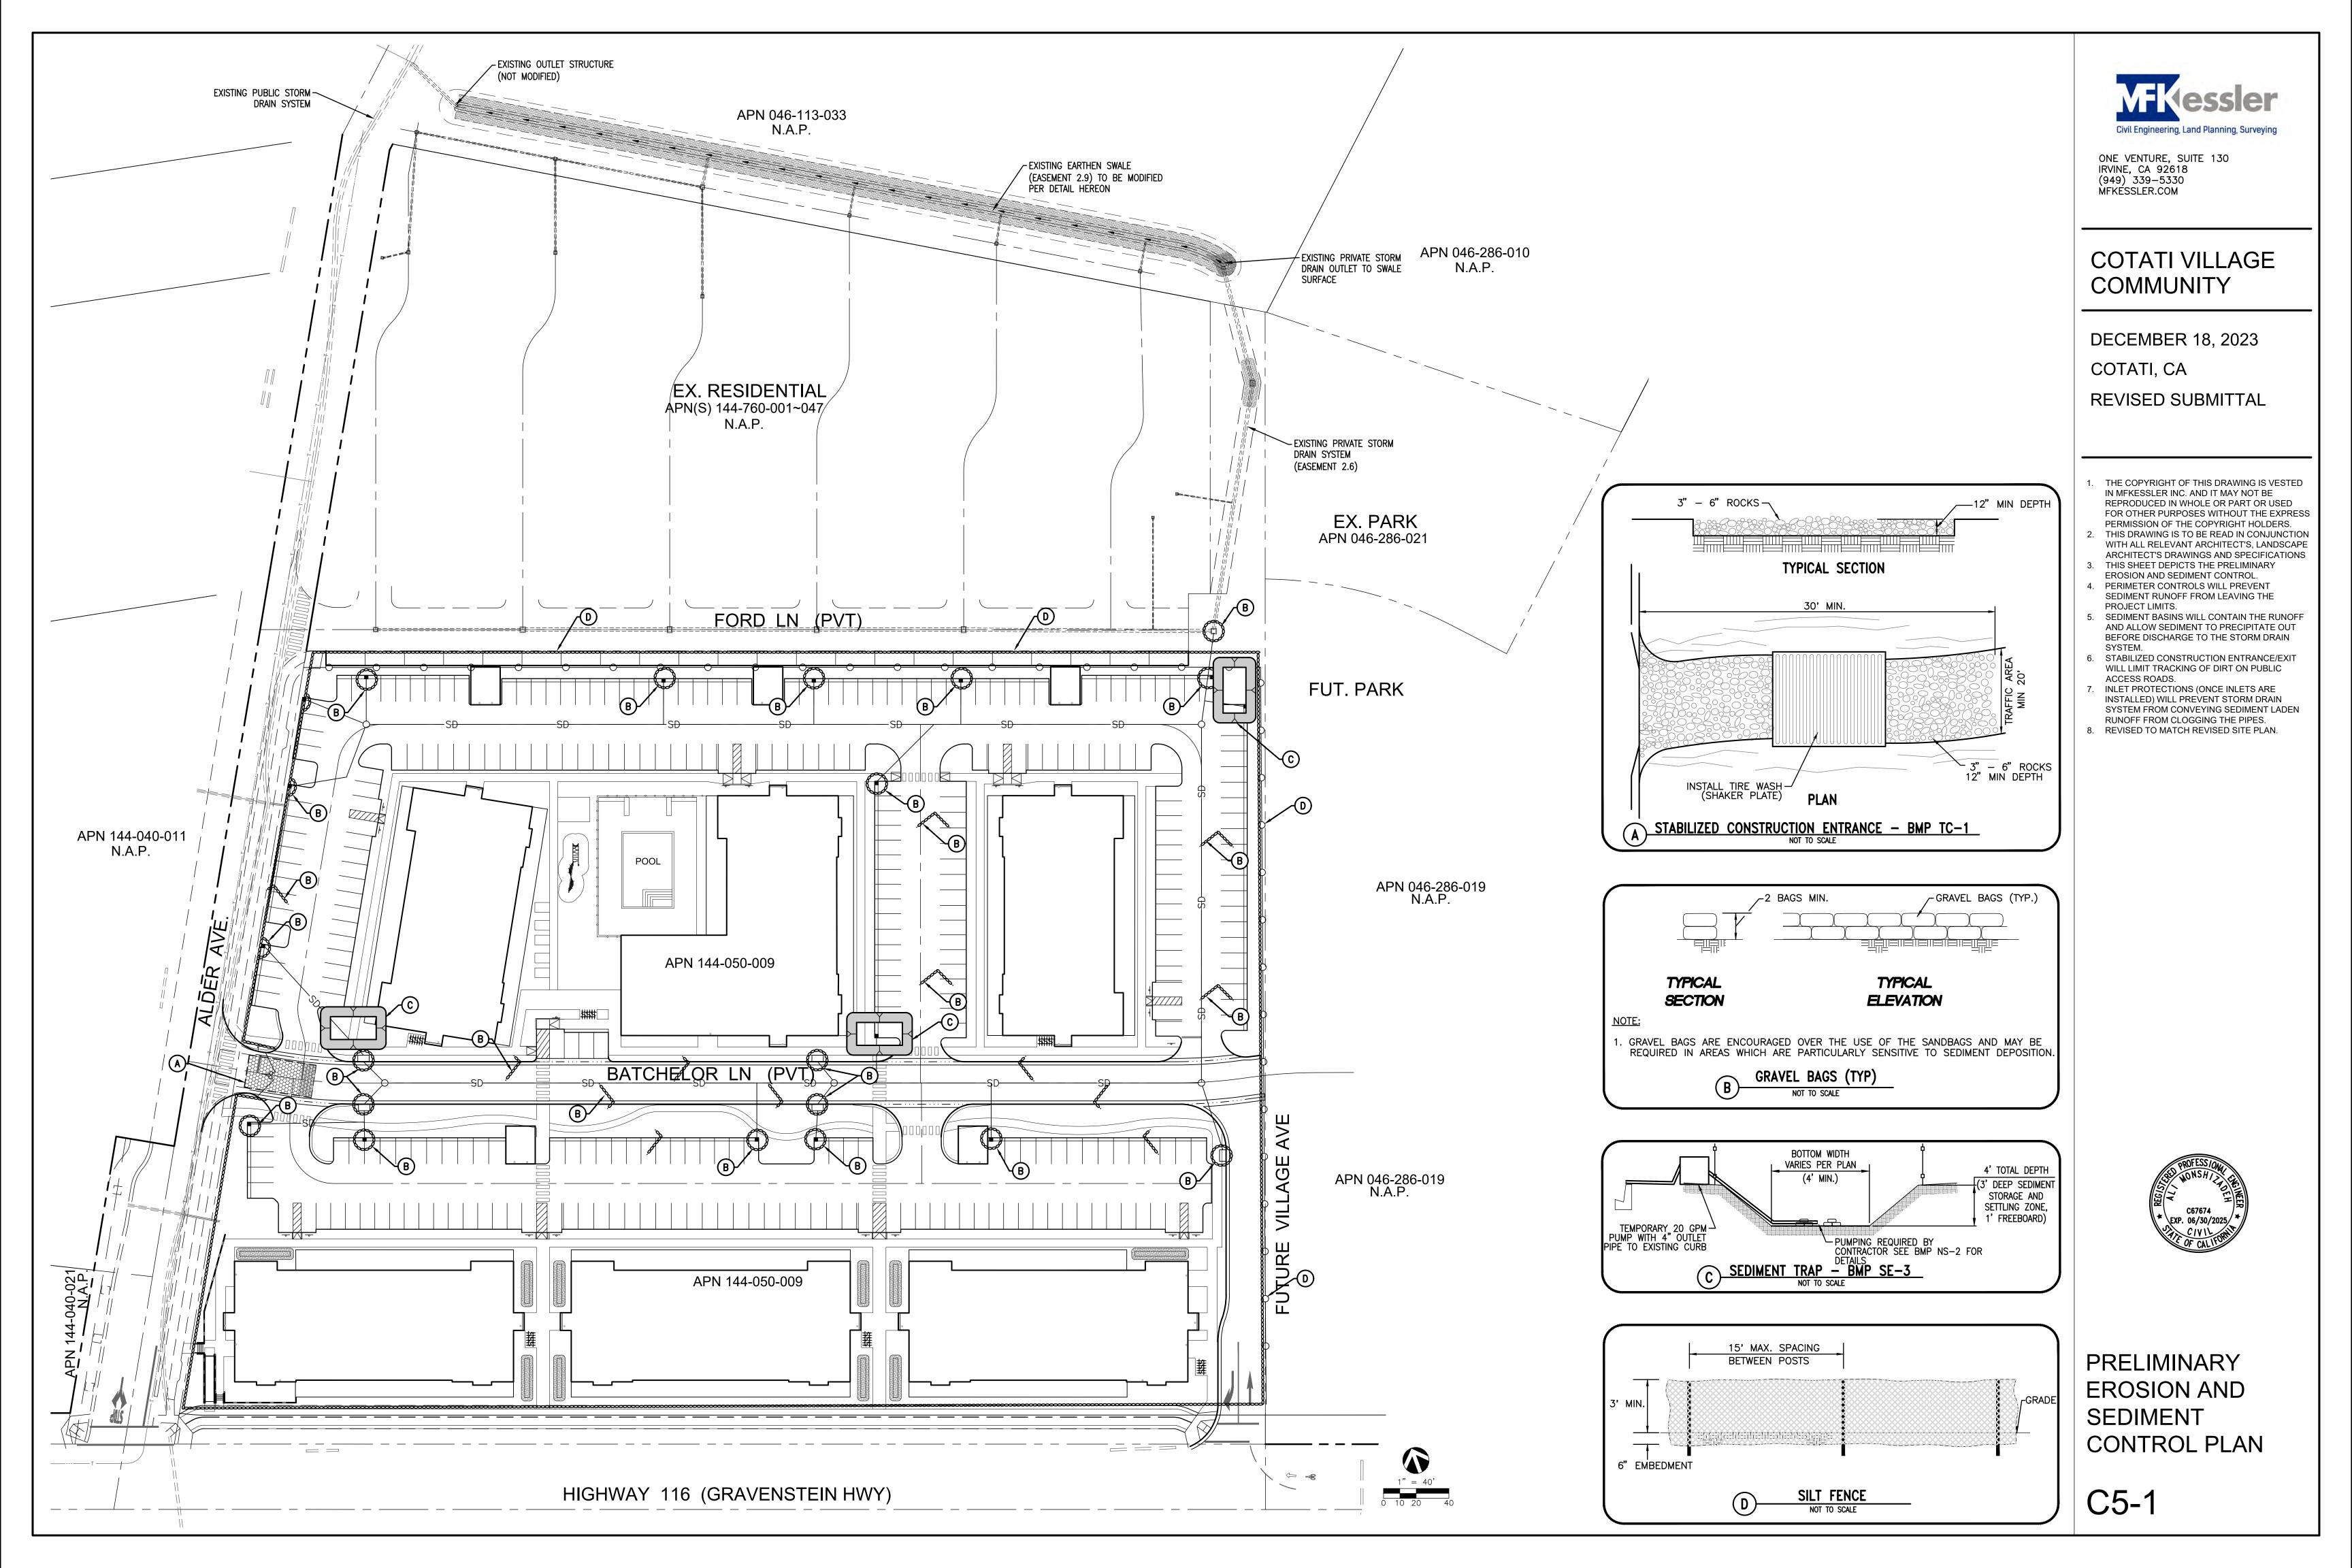



# COTATI VILLAGE COMMUNITY

DECEMBER 18, 2023 COTATI, CA

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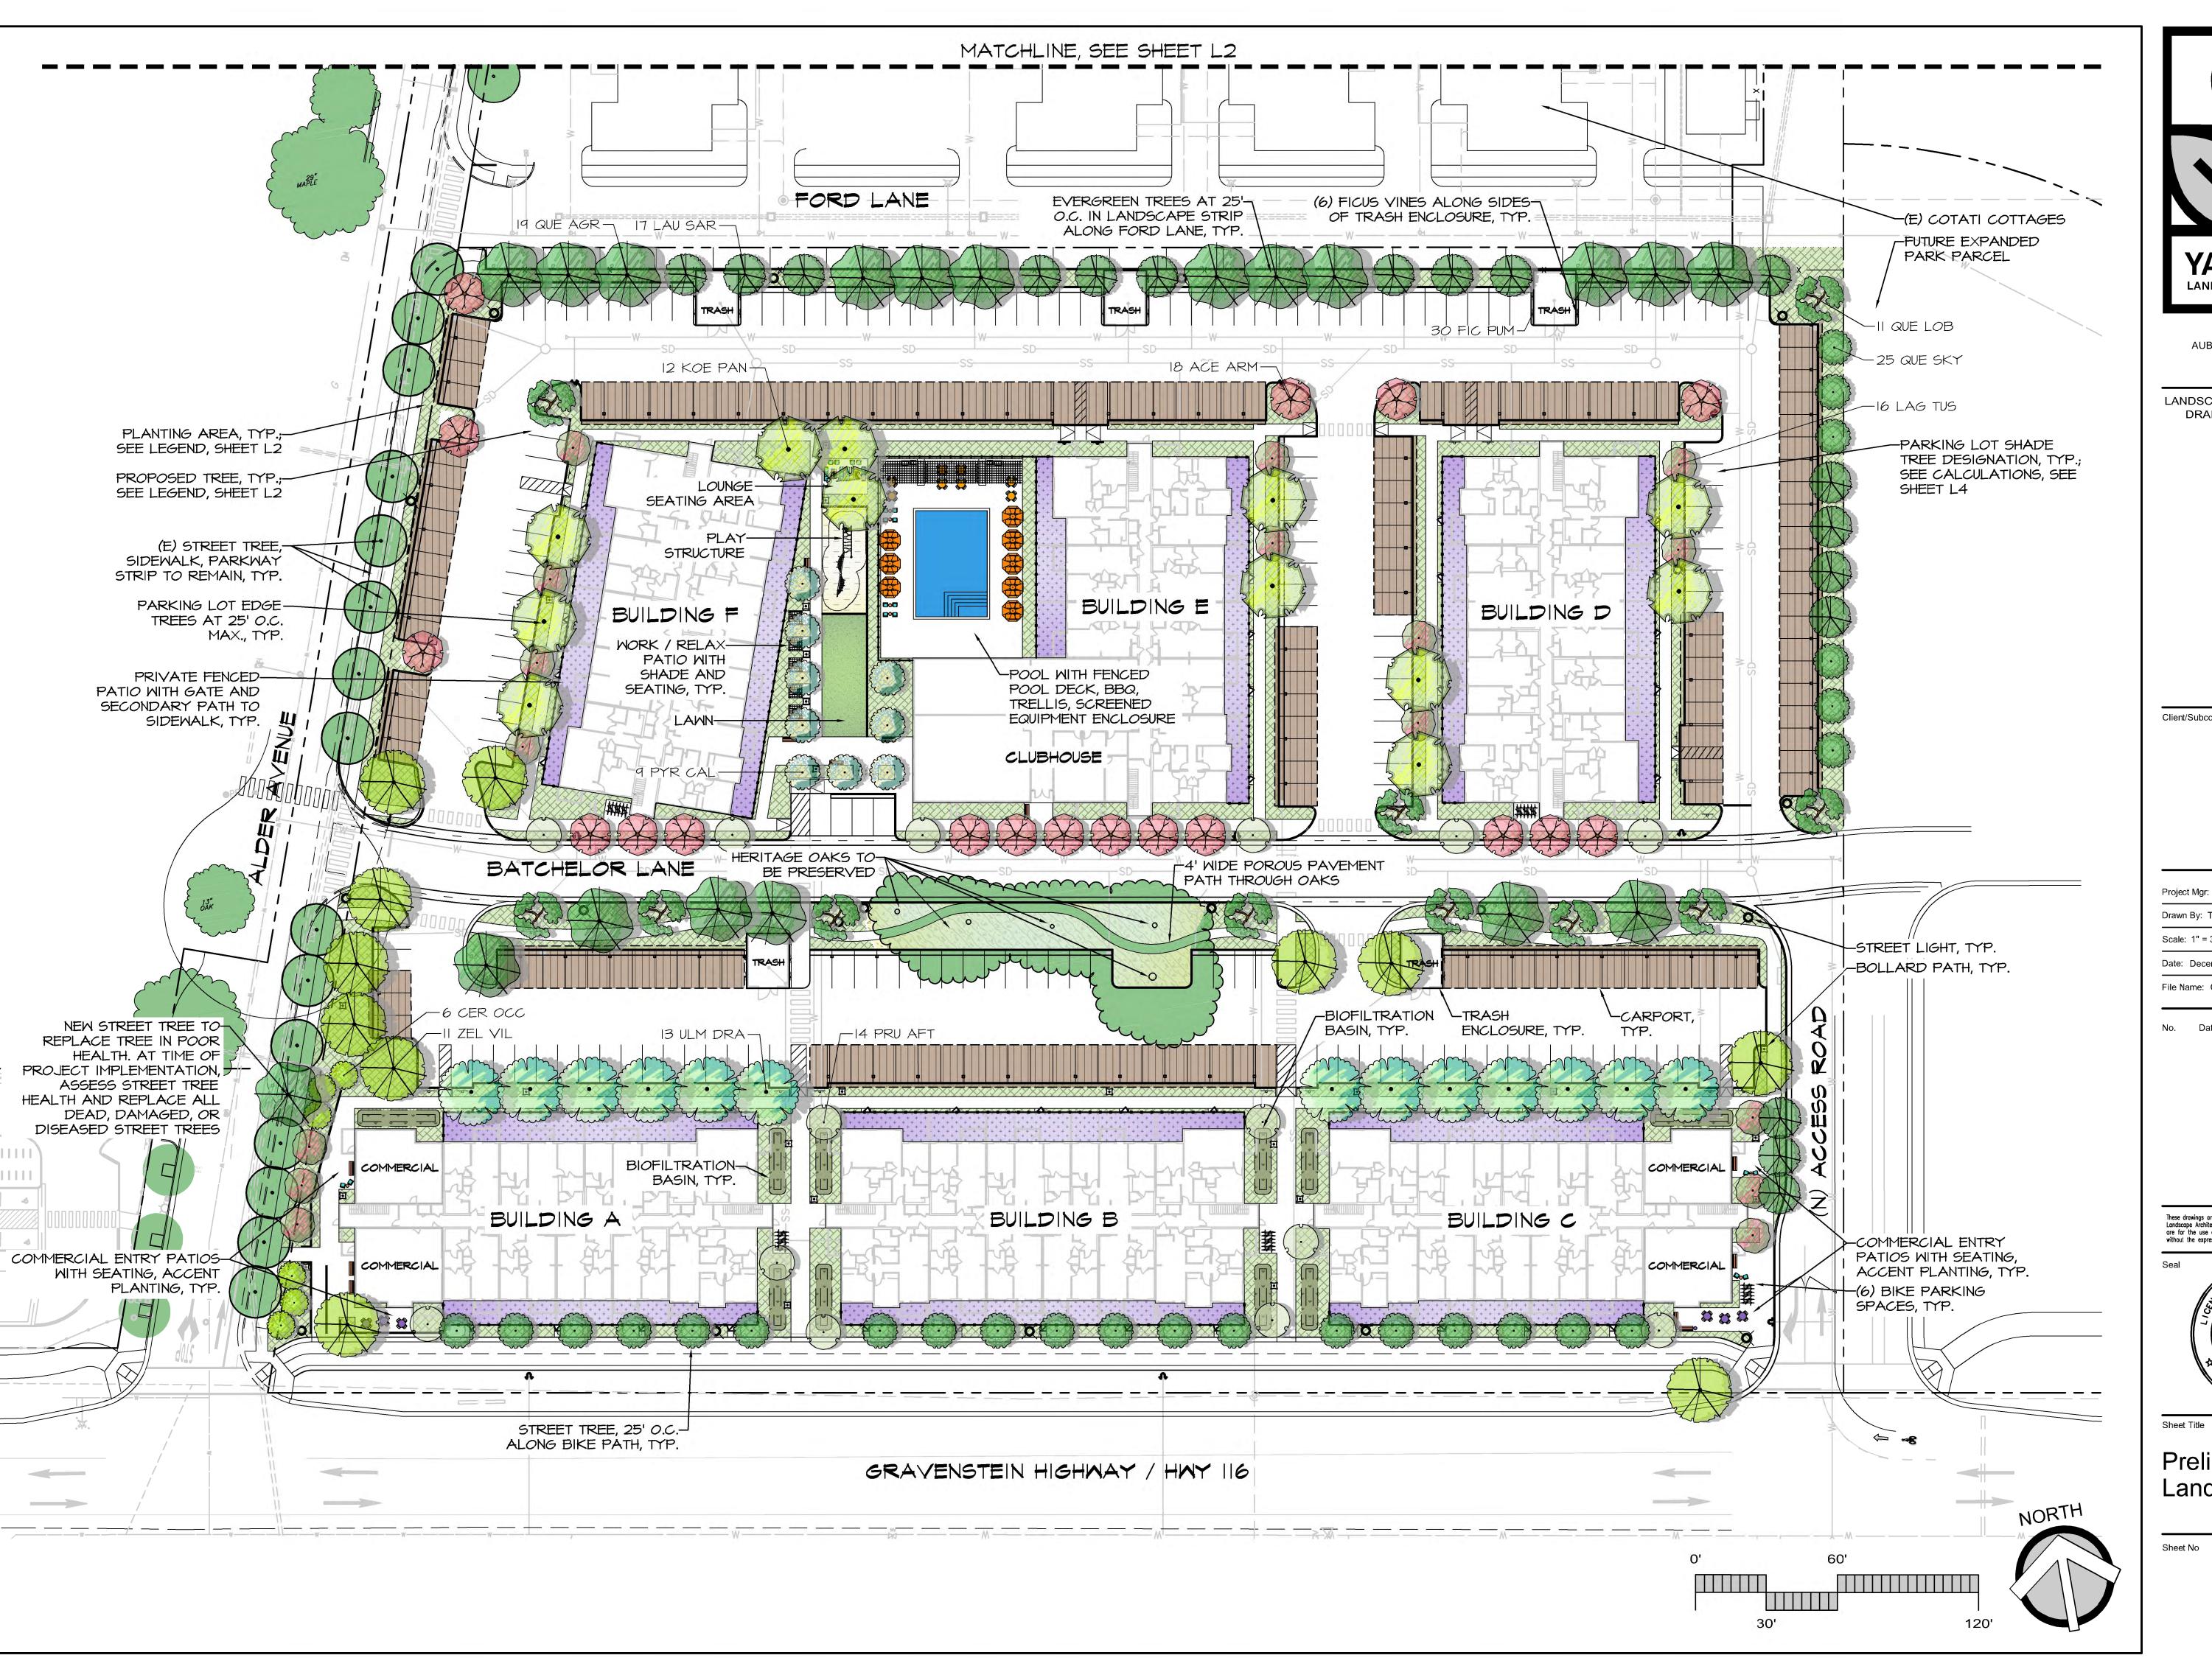
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- THIS SHEET DEPICTS THE PRELIMINARY UTILITY
  LAYOUT. EACH BUILDING IS SERVED BY A
  SINGLE SEWER, DOMESTIC WATER SERVICE,
  AND FIRE WATER SERVICE.
   WATER CONNECTIONS ARE MADE TO THE
  MAINS IN ALDER AVENUE, FORD LANE, AND
  HIGHWAY 146 (CRAYENSTEIN HMY), SEE
- HIGHWAY 116 (GRAVENSTEIN HWY). SEE
  EASEMENTS 1.3 AND 1.9 ON SHEET C3. THIS
  COMPLIES WITH THE WATER MASTER PLAN.
  5. FIRE HYDRANTS ARE LOCATED THROUGHOUT
  THE SITE TO SERVE EACH BUILDING.
- 6. THE NORTH HALF OF THE SITE IS SERVED BY THE SEWER MAIN IN FORD LANE, THE SOUTH HALF IS SERVED BY THE SEWER MAIN ALONG HIGHWAY 116 (GRAVENSTEIN HWY). SEE EASEMENTS 2.1 AND 2.7 ON SHEET C3. THIS COMPLIES WITH THE SEWER MASTER PLAN.
  7. STORM DRAINAGE IS COLLECTED IN THE STREETS AND DRIVE AISLES AND CONVEYED
- 7. STORM DRAINAGE IS COLLECTED IN THE STREETS AND DRIVE AISLES AND CONVEYED VIA PIPE TO THE EXISTING SWALE ALONG THE NORTH PROPERTY LINE OF THE COTATI COTTAGES TRACT. FROM THERE IT CONNECTS TO THE STORM DRAIN SYSTEM IN ALDER AVE. SEE EASEMENTS 2.6 AND 2.9 ON SHEET C3. THIS
- COMPLIES WITH THE DRAINAGE MASTER PLAN.


  8. THE OVERHEAD LINES ALONG HIGHWAY 116
  (GRAVENSTEIN HWY) WILL BE PLACED
  UNDERGROUND.



PRELIMINARY UTILITY PLAN

C6-0



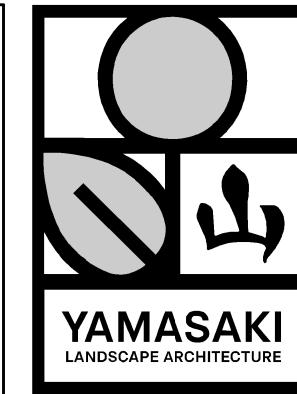

1223 HIGH STREET AUBURN, CALIFORNIA 95603 530.885.0040 www.yamasaki-la.com

LANDSCAPE DEVELOPMENT PLANS DRAFT REVISED SUBMITTAL

> COTATI **VILLAGE** COMMUNITY

> > COTATI, CA


Client/Subconsultant

Drawn By: TVZ Date: December 18, 2023 File Name: CV-LP

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Preliminary Landscape Plan



YAMASAKI LANDSCAPE ARCHITECTURE
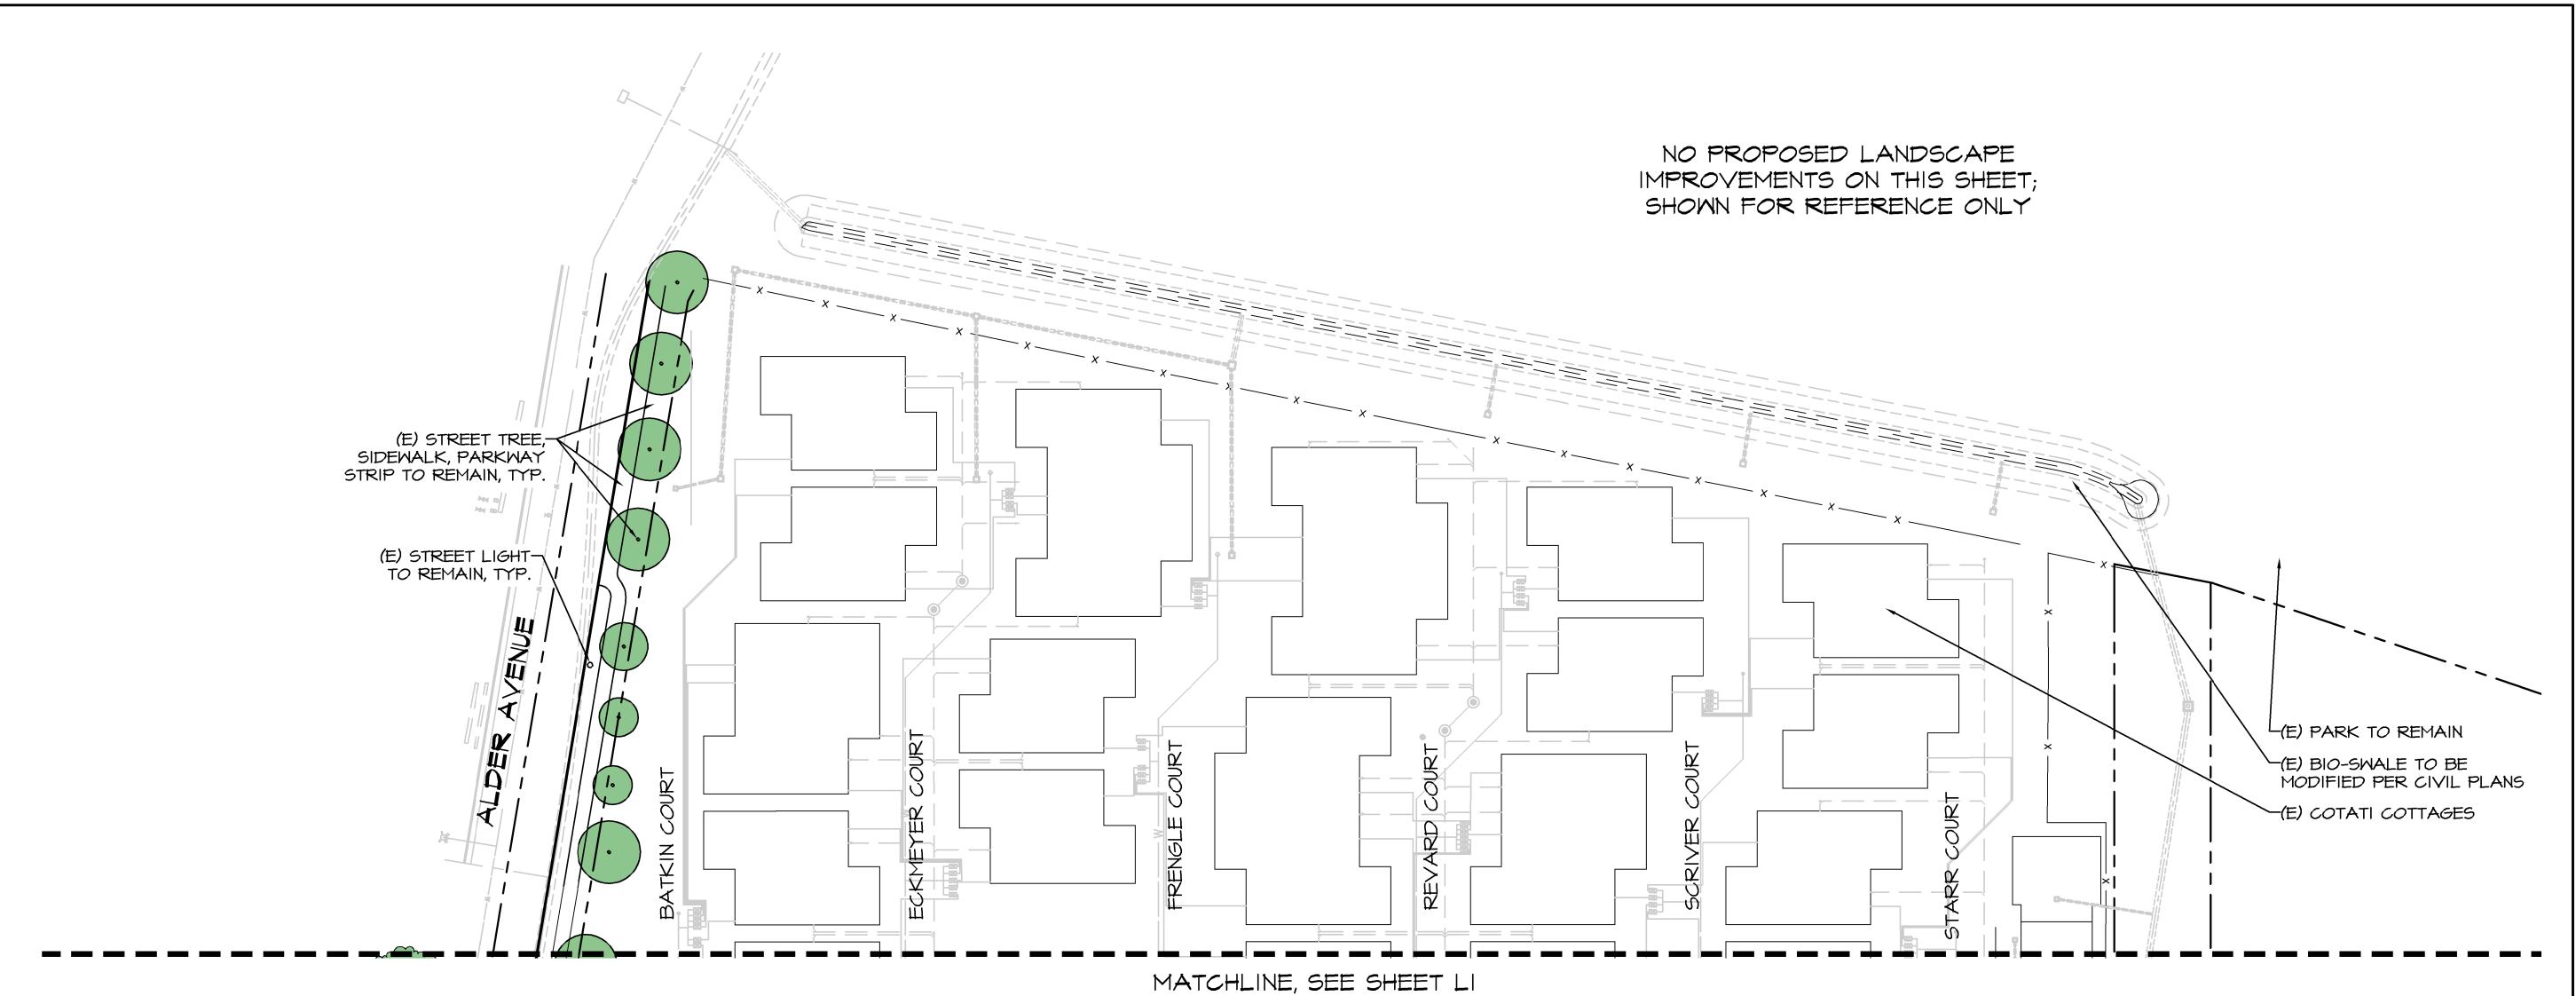
> 1223 HIGH STREET AUBURN, CALIFORNIA 95603 530.885.0040 www.yamasaki-la.com

LANDSCAPE DEVELOPMENT PLANS DRAFT REVISED SUBMITTAL

COTATI
VILLAGE
COMMUNITY

COTATI, CA

Client/Subconsultant

Project Mgr: TVZ

Date: December 18, 2023

File Name: CV-LP

Data Baylajar

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Sheet Title

Preliminary Landscape Plan -North

Sheet No

L2

60' 120'

LANDS	SCAPE S	SCHEDUL					
SYMBOL TREES	CODE	QTY	BOTANICAL / COMMON NAME	SIZE	CA NATIVE	<u>WUCOLS</u>	MATURE SIZE (H×W)
TREES	ACE ARM	18	Acer rubrum 'Armstrong' / Red Maple	24" box		MEDIUM	45'x 5'
	CER OCC	6	Cercis occidentalis / Western Redbud	15 gal	Native	VERY LON	25'x 5'
The second second	KOE PAN	12	Koelreuteria paniculata / Golden Rain Tree	24" box		MEDIUM	45'x35'
	LAG TUS	16	Lagerstroemia x 'Tuscarora' / Crape Myrtle	15 gal		LOW	20'x20'
	LAU SAR	17	Laurus x 'Saratoga' / Saratoga Hybrid Laurel	15 gal		LOW	20'x20'
	PRU AFT	14	Prunus x yedoensis 'Afterglow' / Yoshino Cherry	15 gal		MEDIUM	25'x25'
	PYR CAL	9	Pyrus calleryana 'Chanticleer' / Flowering Pear	24" box		MEDIUM	40'x25'
	QUE AGR	19	Quercus agrifolia / Coast Live Oak	24" box	Native	LOW	60'x50'
	QUE LOB	Ш	Quercus lobata / Valley Oak	24" box	Native	LOW	60'x50'
	QUE SKY	25	Quercus robur 'Fastigiata' / Skyrocket English Oak	15 gal		MEDIUM	40'x15'
	ULM DRA	13	Ulmus parvifolia 'Drake' / Drake Lacebark Elm	24" box		LOW	60'x40'
	ZEL VIL	11	Zelkova serrata 'Village Green' / Sawleaf Zelkova	24" box		MEDIUM	60'x40'
VINES	FIC PUM	<i>30</i>	Ficus pumila / Creeping Fig (Vine at trash enclosures)	l gal		MEDIUM	
SYMBOL	CODE	QTY	BOTANICAL / COMMON NAME				
HARDSCAPE							
	CARPORT	26,245 sf	Carport / per architecture plans				
	PLAY	855 sf	Playground Wood Fiber / 12" Depth				
PLANTING A	REA						
	PLANT	45,874 sf	Common Planting Area Selected from Plant Palette at right				
	MULCH	2,671 sf	Organic Mulch / chipped from on-site				
* * * * * * * * * * * * * * * * * * *	YARD	16,755 sf	Private Patio Yard / Not included in total landscape area.				
SOD	LAMN	986 sf	Fescue Blend Lawn				
* * * * * * * * * * * * * * * * * * *	BIO SOD	2,023 sf	Native Biofiltration Grass Blend				
	-						


## PI ANT PAI FTTF

BOTANICAL / COMMON NAME	SIZE	<u>CA NATIVE</u>	<u>MUCOLS</u>	MATURE SIZE (HxM)
<u>SHRUBS</u> Arctostaphylos x 'Sunset' / Sunset Manzanita	5 gal	Native	LOW	6'x6'
Berberis pinnata / California Barberry	5 gal	Native	LOW	6'x3'
Callistemon viminalis 'Better John' / Dwarf Bottlebrush	5 gal		LOW	3'x3'
Carpenteria californica 'Elizabeth' / Elizabeth Bush Anemone	5 gal	Native	LOW	4'x4'
Ceanothus x 'Concha' / Concha Ceanothus	5 gal	Native	LOW	6'x7'
Ceanothus x 'Julia Phelps' / Julia Phelps Ceanothus	5 gal	Native	LOW	6'x8'
Cistus x purpureus / Orchid Rockrose	5 gal		LOW	4'x4'
Dodonaea viscosa / Hopseed Bush	5 gal		LOW	12'x10'
Fremontodendron x 'Ken Taylor' / Ken Taylor Flannel Bush	5 gal	Native	LOW	12'x10'
Hesperaloe parviflora 'Brakelights' / Crimson Yucca	5 gal		LOW	2'x3'
Heteromeles arbutifolia / Toyon - Shrub Form	5 gal	Native	LOW	12'x10'
Rhamnus californica 'Eve Case' / Eve Case Coffeeberry	5 gal	Native	LOW	5'x8'
Rhus ovata / Sugar Bush	5 gal	Native	LOW	6'x6'
Salvia clevelandii 'Winnifred Gilman' / Winnifred Gilman Cleveland Sage	5 gal	Native	LOW	4'×4'
<u>GRASSES</u> Muhlenbergia rigens / Deer Grass	l gal	Native	LOW	4'x4'
<u>VINES</u> Ficus pumila / Creeping Fig (Vine at trash enclosures)	l gal		MEDIUM	
BOTANICAL / COMMON NAME	<u>SIZE</u>	CA NATIVE	<u>MUCOLS</u>	<u>SPACING</u>
<u>GROUND COVERS</u> Anigozanthos x 'Bush Gold' / Yellow Kangaroo Paw	l gal		LOW	36" o.c.
Baccharis pilularis 'Pigeon Point' / Pigeon Point Coyote Brush	l gal	Native	LOW	48" o.c.
Berberis aquifolium 'Compacta' / Compact Oregon Grape	l gal	Native	LOW	48" o.c.
Carex tumulicola / Foothill Sedge	l gal	Native	LOW	24" o.c.
Ceanothus griseus Anchor Bay / Ceanothus	l gal	Native	LOW	48" o.c.
Cotoneaster dammeri 'Lowfast' / Lowfast Bearberry Cotoneaster	l gal		LOW	72" o.c.
Epilobium canum / California Fuchsia	l gal	Native	LOW	48" o.c.
Lantana x 'Mone' / Tangerine Lantana	l gal		LOW	60" o.c.
Lomandra longifolia 'Breeze' / Breeze Mat Rush	l gal		LOW	36" o.c.
Penstemon heterophyllus 'Margarita BOP' / Margarita BOP Penstemon	l gal	Native	LOW	24" o.c.
Rosmarinus 'Collingwood Ingram' / Prostrate Rosemary	l gal		LOW	48" o.c.
Symphoricarpos mollis / Creeping Snowberry	l gal	Native	LOW	48" o.c.

### IRRIGATION NARRATIVE

The irrigation system will be serviced by a new point of connection for all onsite landscape with dedicated irrigation meter and backflow preventer. The irrigation design will consist of low volume inline drip irrigation at understory plantings, bubbler irrigation at new tree's to encourage deep root watering, and low-precipitation rate overhead rotary spray at lawn and bio-retention basins. The overall irrigation system will be operated with a smart irrigation controller. A weather sensor will be used to automatically adjust duration of application in accordance with recent weather conditions based on evapotranspiration. Maximum water allowance will be determined by State code. To also be consistent with the planting design, the irrigation design shall incorporate hydrozones by locating plants of different water needs into groups for ease of water application.

"I HAVE COMPLIED WITH THE CRITERIA OF CHAPTER 17.34 (LANDSCAPING AND WATER EFFICIENT LANDSCAPING STANDARDS) OF THE CITY OF COTATI MUNICIPAL CODE AND APPLIED THEM ACCORDINGLY FOR THE EFFICIENT USE OF WATER IN THE LANDSCAPE PLANTING DESIGN PLAN"

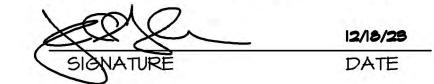

## PLANTING NARRATIVE

This landscape plan proposes a variety of tree species throughout the parking lots and common landscape areas. The understory landscape plant palette consists of low water use shrubs, ground covers, trees, and ornamental grasses that are considered low-maintenance, long-lived, and hardy. A minimum of 50% of plant species are Califórnia native. Choice of plants is quided by considerations of solar exposure and climate conditions of the site.

Plant design varies in form, texture and color. Informal planting patterns are preferred over uniform symmetrical planting patterns. Use of flowering trees and colorful enhanced plantings are located at pedestrian and driveway entries and throughout the central commons area. Planting design takes ease of maintenance into consideration by minimizing the following: plant material that may attract or harbor pests/disease; trees that drop extreme amounts of litter (e.g. Liquidambar, fruit trees, etc.); plant material with a mature size larger than the space provided for growth; perennial plants that die back in winter

A soils fertility analysis will be required prior to planting per Cotati Municipal Code 17.34.080. Species and amendments shall be adjusted to reflect soils analysis recommendations.

All planted areas shall be properly amended, compacted and finish graded prior to planting. A pre-emergent herbicide will be installéd in all shrub and groundcover planting areas to control weeds. All landscape areas will be top dressed with a 3-inch depth of 'Walk-On' bark mulch (no shredded Redwood).

Root barriers shall be provided for trees in planters less than ten feet in width or located five feet or closer to a permanent structure.

Ground covers will be no less than I-gallon size. Shrubs will less than 5-gallon size. Trees will be no less than 15-a non size Plant matérials shall be spased to provide substantial coverno

also to allow adequate room to mature into their natural and ultimate size without required pruning.



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LANDSCAPE DEVELOPMENT PLANS DRAFT REVISED SUBMITTAL

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COTATI, CA


Client/Subconsultant

Project Mgr: TVZ Drawn By: TVZ

File Name: CV-LP

Date: December 18, 2023

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Sheet Title

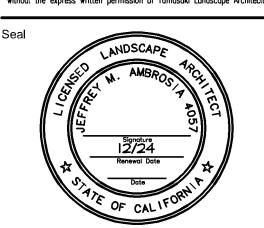Preliminary Landscape Notes

Sheet No


# SELECT PLANT IMAGES




CEANOTHUS



DEER GRASS

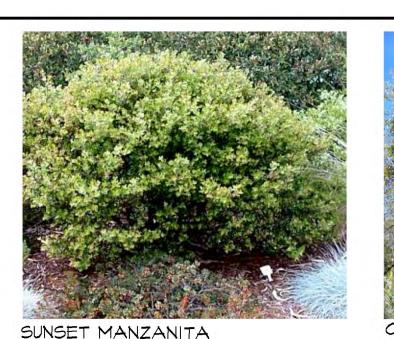

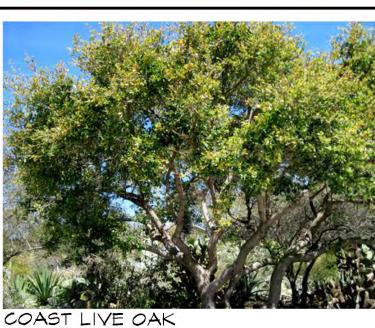





DRAWN: BHH

SITE LIGHTING DETAILS

STREET AND PARKING LOT LIGHTING

THIS DRAWING, WHEN APPROVED, SHALL BECOME THE COMPLETE SPECIFICATION FOR THE MATERIAL TO BE FORMSHED BY HOLOPHANE ON THE CROPER NOTED ABOVE. A UNIT OF SYMLAID DESIGN MAY BE SUPPLIED, BUT ONLY AFTER APPROVAL BY THE CUSTOMER IN WAITING, ON POLE DROBERS AN AUGUST BUT TEMPLATE PRINT MAY, BE SUPPLIED FOR WHITE ACT OF THE PROPERTY OF TROUBLE AND STOCKED AND A CONTROL THE PAUL PROPUBED. THE PROPERTY OF TROUBLE AND STOCKED AND A CONTROL THE PAUL PROPUBED. THE PROPERTY OF TROUBLE AND A CONTROL THE PAUL PROPUBED. THE PROPERTY AND A CONTROL THE PAUL PROPUBED. THE PROPERTY AND A CONTROL THE PAUL PROPUBED. THE PAUL PROPUBED AND A CONTROL THE PAUL PROPUBED. THE PAUL PROPUBED AND A CONTROL THE PAUL PROPUBED. THE PAUL PROPUBED AND A CONTROL THE PAUL PROPUBED. THE PAUL PROPUBED AND A CONTROL THE PAUL PROPUBED. THE PAUL PROPUBED AND A CONTROL THE PAUL PROPUBED. THE PAUL PROPUBED AND A CONTROL THE PAUL PROPUBED. THE PAUL PROPUBED AND A CONTROL THE PAUL PROPUBED. THE PAUL PROPUBED AND A CONTROL THE PAUL PROPUBED. THE PAUL PROPUBED AND A CONTROL THE PAUL PROPUBED. THE PAUL PROPUBED AND A CONTROL THE PAUL PROPUBED AND A CONTROL THE PAUL PROPUBED AND A CONTROL THE PAUL PROPUBED. THE PAUL PROPUBED AND A CONTROL THE PAU



## BOLLARD PATH LIGHTING

SITE LIGHTING NOTES

PEDESTAL.

CITY OF COTATI.

ALL LIGHT FIXTURES WILL BE PER CITY OF

COTATI STANDARDS, WITH LED LUMINAIRE,

PHOTO CELL, AND FULL-CUT OFF SHIELDS.

PARKING AREA IT SHALL BE MOUNTED ON

2. WHERE STREET LIGHT IS LOCATED IN A

3. ELECTRICAL CONTRACTOR SHALL SUBMIT

SHOP DRAWING FOR APPROVAL BY THE

A 2'-6" HIGH x 2' WIDE CONCRETE

## PARKING LOT SHADE CALCULATIONS

#### LEGEND

PARKING LOT SHADE TREE DESIGNATION

TREE CODE	H= HALF (50%)	
ACE ARM	5 (246) = 1,230	
KOE PAN	9 (481) = 4,329	
LAG TUS	10 (246) = 2,460	
LAU SAR	10 (246) = 2,460	
PYR CAL	3 (246) = 738	
QUE AGR	13 (48I) = 6,253	
QUE LOB	3 (481) = 1,443	
ULM DRA	13 (48I) = 6,253	
ZEL VIL	8 (481) = 3,848	
EXISTING OAK TREES	4 (48I) = 1,924 	

TOTAL 30,938 SF

PARKING LOT AREA: MINIMUM SHADE REQUIRED (50% COVERAGE):

86,428 SF 43,214 SF

TOTAL SHADE PROVIDED FROM TREE CANOPY: 30,938 SF TOTAL SHADE PROVIDED FROM CARPORTS: 26,245 SF 66% PERCENT SHADE (57,183 / 86,428):

## LANDSCAPE COVERAGE

IRRIGATED PLANTING AREA BIOFILTRATION BASINS LAMN

45,854 SF 2,044 SF 986 SF

TOTAL NEW IRRIGATED LANDSCAPE AREA 48,884 SF

## TREE CALCULATION

TOTAL TREE QUANTITY: 171

EVERGREEN TREES: 49 (28%) 24" BOX TREES 91 *(*53%)

#### NATIVE CALCULATION

TOTAL SPECIES (TREES AND PLANT PALETTE): 41

CALIFORNIA NATIVE SPECIES: 21 *(*51%)

## SITE LIGHTING

STREET LIGHT

QUANTITY: 19

SEE CUTSHEETS, SHEET L3

M BOLLARD PATH LIGHT QUANTITY: 24

SEE CUTSHEETS, SHEET L3

Irrigation Division

Irrigation Audit Services (CLIA) LEED Certified Landscape Design

AB1881 Compliance Documentation

YAMASAKI

Irrigation Division Irrigation Audit Services (CLIA) LEED Certified Landscape Design AB1881 Compliance Documentation

ORIGIN DATE: 09-24-04 PAGE: 1 of 1

#### PROJECT INFORMATION

Project Name:	Cotati Villag	ge 1	Date: 12/18/2023
Pr	oject Contact: Ap	plicant:	Yamasaki Landscape Architecture
	200		1223 High Street, Auburn, CA 95603
			(530) 885-0040
	Co	ntact:	Jeff Ambrosia
	Ov	vner:	Collin Monahan
			116 Associated Investors, LLC
	A STATE OF THE STA		1101 5th Ave., San Rafael, CA 94901
Pr	oject Address:		Gravenstein Highway and Alder Avenue
- Y			Cotati, CA

Project Type: New Private Project Local Water Purveyor: City of Cotati Water Supply: Potable Water

Total Landscape Area: 55,723 s.f. Maximum Applied Water Allowance: 549,859 gallons Estimated Total Water Use: 420,830 gallons

**Document Check List:** ✓ Project Information Water Efficient Landscape Worksheet Soil Management Report ✓ Landscape Design Plan ☐ Irrigation Design Plan Grading Design Plan

Applicant Signature "I agree to comply with the requirements of the water efficient landscape ordinance and submit a complete Landscape Documentation Package. "

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Irrigation Division Irrigation Audit Services (CLIA) LEED Certified Landscape Design AB1881 Compliance Documentation

#### Water Efficient Landscape Worksheet Section A: Hydrozone Information Sheet

Zone #	Hydrozone Type	Irrigation Method	Area (Sq.Ft.)	% of Landscape Area
1	Common Planting Area	Drip	45,874	82%
2	Trees	Bubbler	6,840	12%
3	Biofiltration Basins	Rot Stream	2,023	4%
4	Lawn	Rot Stream	986	2%
			Total Area(Sq.Ft.)	Total (%)
			55,723	100%

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#### Water Efficient Landscape Worksheet Section B. Water Budget Calculation

Maximum Applied Water Allowance (MAWA)

Project ETo City: Cotati

 $MAWA = (ETo) (0.62) [(0.45 \times LA) + (0.55 \times SLA)]$ 

39.6 45,048

MAWA = Maximum Applied Water Allowance (gallons per year) ETo = Reference Evapotranspiration (inches per year) 0.45= ET Adjustment Factor (ETAF)(AB 1881 Dec 1, 2015)

LA = Landscape Area includes Special Landscape Area (Sq.Ft.) 0.62 = Conversion Factor (to gallons per Sq.Ft.) SLA = Special Landscape Area (Sq.Ft.)

MAWA = 39.6 (0.62) [(0.45x 45,048 + (0.55x 3,862))

0.55= The additional ET Adjustment Factor for SLA (1.0-0.45=0.55)

549,859 Gal. / Yr Maximum Applied Water Allowance:

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Irrigation Division

Irrigation Audit Services (CLIA)

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Water Efficient Landscape Worksheet Section B. Water Budget Calculation

#### Estimated Total Water Use (ETWU)

Hydrozone Type	Plant Water Use Type(s)	Plant Factor (PF)	IE	ETAF (PF/IE)	Area (HA) (Sq.Ft.)	ETAF x Area	Estimated Total Water Use
Common Planting Areas	Low (L)	0.2	0.81	0.25	45,874	11,327	278,098
Trees	Moderate (M)	0.5	0.81	0.62	6,840	4,222	103,664
Biofiltration Basins	Low (L)	0.2	0.75	0.27	2,023	539	13,245
Tota				1	54,737	16,089	
		SUM		395,007			
pecial Landscape Areas							
Lawn	High (H)	0.8	0.75	1.07	986	1,052	25,822
				SUM	986	1,052	25,822

ETWU =(ETo)(0.62)x( $PF \times HA + SLA$ )

Max Applied Water Allowance

549,859

**Estimated Total Water Use** 

Regular Landscape ETWU

Average ETAF

Sitewide ETAF

SLA ETWU

395,007 0.29 25,822 0.31 420,830 YAMASAK ANDSCAPE ARCHITECTURE

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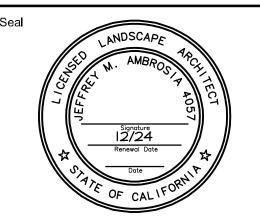
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Revision

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Sheet Title

Calculations and **Lighting Details** 

Sheet No

MATER USE CALCULATIONS