Notice of Exemption

Appendix E

P.O. Box 3044, Room 113 Sacramento, CA 95812-3044	From: (Public Agency): City of 14050 Olympic Drive	Clearlake			
County Clerk	Clearlake, CA 95422				
County of: Lake		2024-037			
255 N. Forbes Street	(Addres	FILED			
Lakeport, CA 95453		FILED			
- Cloudely Bi u		April 29, 2024			
Project Title: Clearlake Directional/Way	Finding Signage	JENAVIVE HERRINGT			
Project Applicant: City of Clearlake		COUNTY CLERK			
Project Location - Specific:		LAKE COUNTY			
Installation of Directional Signs three	oughout City Limits	By Ka			
이 사람들은 경기 이 경기를 가는 목가들이 없다.	oughout Only Limits	Deputy clerk			
Project Location - City: Clearlake	Project Location - County:	Lake County			
Description of Nature, Purpose and Beneficia	iaries of Project:				
Refer to En	closed Project Description				
Name of Public Agency Approving Project: Control Project:	oject: Mark Roberts - Senior Planner B);	i jaj lätti 53 om mil iron olesti est 601 kaharan mellen kaj			
Name of Person or Agency Carrying Out Pro Exempt Status: (check one): Ministerial (Sec. 21080(b)(1); 15268 Declared Emergency (Sec. 21080(b)(4)) Emergency Project (Sec. 21080(b)(4))	B); (b)(3); 15269(a)); (4); 15269(b)(c)); (and section number: 15303 [Class 3(e)]				
Name of Person or Agency Carrying Out Pro Exempt Status: (check one): Ministerial (Sec. 21080(b)(1); 15268 Declared Emergency (Sec. 21080(b)(4)) Emergency Project (Sec. 21080(b)(4)) Categorical Exemption. State type a Statutory Exemptions. State code no	B); (b)(3); 15269(a)); (4); 15269(b)(c)); (and section number: 15303 [Class 3(e)]	ar kara esa esa en en el Maria de marra en esa, Maria de ser en esa, esa, esa, esa, esa, esa, esa, esa,			
Name of Person or Agency Carrying Out Pro Exempt Status: (check one): Ministerial (Sec. 21080(b)(1); 15268 Declared Emergency (Sec. 21080(b)(4)) Emergency Project (Sec. 21080(b)(4)) Categorical Exemption. State type a	B); b)(3); 15269(a)); 4); 15269(b)(c)); and section number: signage is consistent with Section 15303 [Class 3(e)] at tallation and placement of small facilities and work on a site relating to solid and hazardous exception to Classes 3 & 4 Categorical Exercises	& Section 15311 (Class 11) ass 3(e)] and Section 15311 /or accessory structures. s waste (Pursuant to 65962.5			
Name of Person or Agency Carrying Out Pro Exempt Status: (check one): Ministerial (Sec. 21080(b)(1); 15268 Declared Emergency (Sec. 21080(b)(4) Emergency Project (Sec. 21080(b)(4) Categorical Exemption. State type a Statutory Exemptions. State code not Reasons why project is exempt: The installation of up to 20 directional/way finding state (Class 11) which provides for the construction, installationally, the specified activities do not Involve word the Government Code) and do not constitute an Section 15300.2 (e) of the CEQA Guidelines and Section 15300.2 (e) of the CEQA Gu	B); b)(3); 15269(a)); 4); 15269(b)(c)); and section number: signage is consistent with Section 15303 [Class 3(e)] at tallation and placement of small facilities and work on a site relating to solid and hazardous exception to Classes 3 & 4 Categorical Exercises	& Section 15311 (Class 11) ass 3(e)] and Section 15311 /or accessory structures. s waste (Pursuant to 65962.5 nptions as described in the			
Name of Person or Agency Carrying Out Pro Exempt Status: (check one): Ministerial (Sec. 21080(b)(1); 15268 Declared Emergency (Sec. 21080(b)(4)) Emergency Project (Sec. 21080(b)(4)) Categorical Exemption. State type at Statutory Exemptions. State code not Reasons why project is exempt: The installation of up to 20 directional/way finding states (Class 11) which provides for the construction, instance and the Government Code) and do not constitute an Section 15300.2 (e) of the CEQA Guidelines and Section 15300.2 (e) of the CEQA Gui	Mark Roberts - Senior Planner (B); (C)(3); 15269(a)); (A); 15269(b)(c)); (A); 15269(a)); (A); 15269(a); 15269(a); (A);	& Section 15311 (Class 11) ass 3(e)] and Section 15311 /or accessory structures. s waste (Pursuant to 65962.5 nptions as described in the nsion: 707 994-8201			
Name of Person or Agency Carrying Out Pro Exempt Status: (check one): Ministerial (Sec. 21080(b)(1); 15268 Declared Emergency (Sec. 21080(b)(4) Emergency Project (Sec. 21080(b)(4) Categorical Exemption. State type a Statutory Exemptions. State code not Reasons why project is exempt: The installation of up to 20 directional/way finding so (Class 11) which provides for the construction, instance and some constitute and section 15300.2 (e) of the CEQA Guidelines and Section 15300.2 (e	Mark Roberts - Senior Planner (B); (C)(3); 15269(a)); (A); 15269(b)(c)); (C); (C) and section number: (C) signage is consistent with Section 15303 [Class 3(e)] (C) sumber: (C) signage is consistent with Section 15303 [Class additation and placement of small facilities and work on a site relating to solid and hazardous exception to Classes 3 & 4 Categorical Exensection 21084 (d) of the CEQA Statutes. (C) Area Code/Telephone/External finding. (C) by the public agency approving the pro-	& Section 15311 (Class 11) ass 3(e)] and Section 15311 /or accessory structures. s waste (Pursuant to 65962.5 nptions as described in the nsion: 707 994-8201			


			Print	StartOver	Save					
			RECEIPT NUI	MBER:						
			17-04/29/2024	-024						
			STATE CLEARINGHOUSE NUMBER (If applicable)							
SEE INSTRUCTIONS ON REVERS	E. TYPE OR PRINT CLEA	RLY.								
LEAD AGENCY		LEADAGENCY EMAIL	THE PLANE	DATE	Para na					
CITY OF CLEARLAKE				04/29/2024						
COUNTY/STATE AGENCY OF FILIN	VG	and the first		DOCUMENT NUM	MBER					
LAKE COUNTY				2024-037						
PROJECT TITLE			The Section of		rys Averes					
CLEARLAKE DIRECTIONAL/WAY	FINDING SIGNAGE									
PROJECT APPLICANT NAME		PROJECT APPLICANT E	EMAIL	PHONE NUMBER						
CITY OF CLEARLAKE										
PROJECT APPLICANT ADDRESS	CITY	STATE	ZIP CODE							
PROJECT APPLICANT (Check app	propriate box)									
■ Local Public Agency	School District	Other Special District	☐ State	Agency \square	Private Entity					
☐ Environmental Impact Report ☐ Mitigated/Negative Declaration ☐ Certified Regulatory Program	on (MND)(ND)	it due directly to CDFW								
■ Exempt from fee ■ Exempt from										
■ Notice of Exemption (a	uttach)									
CDFW No Effect Deter										
☐ Fee previously paid (attach p	reviously issued cash receip	ot copy)								
		and the second s								
☐ Water Right Application or Pe	tition Fee (State Water Res	ources Control Board only)	\$ 850.00							
■ County documentary handling	g fee		\$ 50.00		50.00					
☐ Other			1							
PAYMENT METHOD:										
☐ Cash ☐ Credit 🗵 (Check	TOTAL	RECEIVED \$		50.00					
SIGNATURE		AGENCY OF FILING PRINTED N	NAME AND TITLE		The state of the s					
X Ka_				Deputy County	Clerk					

Project Description

The City will be installing up to 20 directional/way finding signs (similar to a street sign) throughout City limits. Each sign will be approximately 11 feet in height (from grade) with a sign width of approximately 4 feet. The footings of each sign will be up to 5 feet in depth with a width of one foot.

The signs will be identical in size/shape, but each sign will have varying directional signage. Each sign will be placed in a previously disturbed/developed area. The locations, include but is not limited to: 1) Intersection of Old Highway 53/Olympic Dr.; 2) Intersection of Olympic Dr./Lakeshore Dr. 3) Intersection of Lakeshore Dr/Old Highway 53; 4) Old Highway 53/Olympic Dr near Nottingham Nursery; 5) Lakeshore Drive (near Tire Pros Shop); and 6) Old Highway 53 near the intersection of Highway 53/Dam Road.



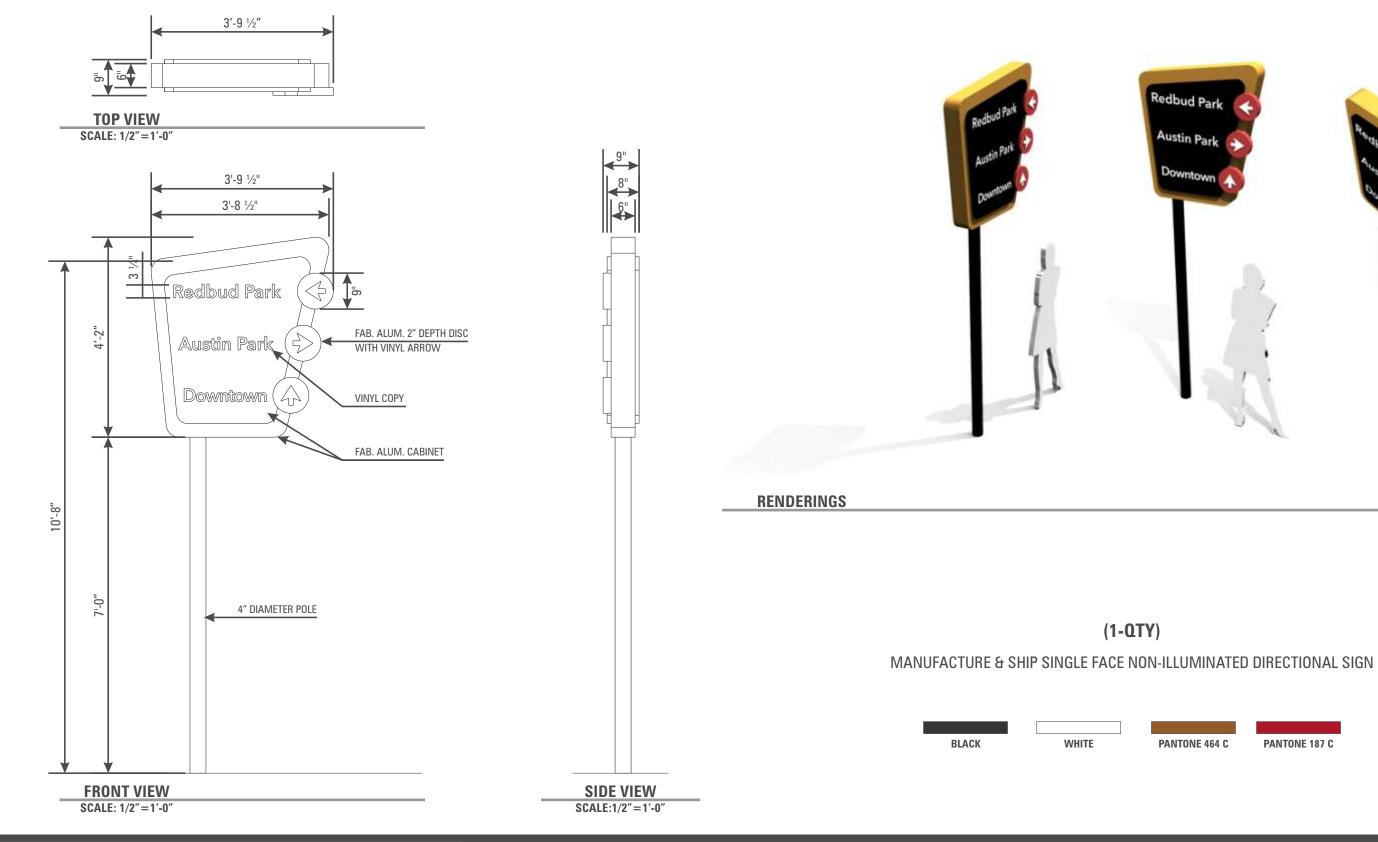






1. REFER TO SIGN COMPANY'S DRAWINGS FOR MORE DETAILS. ALL DESIGNS, DETAILING FABRICATION AND CONSTRUCTION SHALL CONFORM TO: 2022 CALIFORNIA BUILDING CODE

ACI

AISC

AMERICAN WELDING SOCIETY

- LOCAL BUILDING CODES & ORDINANCES
- CONCRETE: 2500 PSI @ 28 DAYS
 STD. STEEL PIPE SECTION: ASTM A53 GRADE B (Fy=35 KSI), U.N.O.
- 4. STEEL PIPE SECTION (> 20" Ø): ASTM A252 GRADE 3 (Fy=42 KSI MIN.) U.N.O.
- 5. HSS ROUND SECTION: ASTM A500 GRADE B (Fy=42 KSI) U.N.O.
- 6. HSS SQUARE/RECTANGULAR SECTION: ASTM A500 GRADE B (Fy=46 KSI)
- W SHAPES: ASTM A992 (Fy = 50 KSI)
- 8. ANCHOR BOLTS: ASTM F1554 GRADE 36 U.N.O. (ALTERNATES GRADE 55 & 105)
- CONNECTION BOLTS: ASTM A325
- 10. THREADED RODS: ASTM A193 GRADE B7
- 11. STEEL ANGLES, CHANNELS, STRUCTURAL SHAPES & PLATES ASTM A36
- 12. REINFORCING: GRADE 60 ASTM A615
- 13. PROVIDE A MINIMUM OF THREE INCHES OF CONCRETE COVER OVER EMBEDDED STEEL.
- 14. THE CONTRACTOR (INSTALLER) IS RESPONSIBLE FOR THE MEANS & METHODS OF CONSTRUCTION IN REGARDS TO JOBSITE SAFETY.
- 15. NO FIELD HEATING FOR BENDING OR CUTTING OF STEEL SHALL BE ALLOWED WITHOUT THE ENGINEER'S APPROVAL.
- 16. WELDING ELECTRODES: E70XX
- 17. ALLOWABLE SOIL BEARING PRESSURE ASSUMED: 1500 PSF
- 18. ASSUMED HORIZONTAL (PASSIVE PRESSURE) ASSUMED AT 100 PSF/FT OF DEPTH. ISOLATED LATERAL BEARING FOUNDATIONS FOR SIGNS NOT ADVERSELY AFFECTED A 1/2" MOTION AT THE GROUND SURFACE DUE TO SHORT TERM LATERAL LOADS SHALL BE PERMITTED TO BE DESIGNED USING TWO TIMES THE TABULATED CODE VALUES.
- 19. ALL FOOTINGS SHALL BEAR ON FIRM UNDISTURBED RESIDUAL SOIL AND/OR ENGINEERED EARTH.
- 20. FILL COMPACTED TO 98% OF ITS MAXIMUM DRY DENSITY AS PER ASTM D 698-70 (STANDARD PROCTOR) UNLESS NOTED OTHERWISE. THE SOIL BEARING CAPACITY IS TO BE VERIFIED BY A GEOTECHNICAL ENGINEER PRIOR TO CONSTRUCTION. IF ALLOWABLE BEARING AND/OR LATERAL PRESSURE IS LESS THAN THE ABOVE ASSUMED AND/OR CALCULATED PRESSURES, THE ENGINEER SHOULD BE CONTACTED FOR RE-EVALUATION.
- 21. EXCAVATION SHALL BE FREE OF LOOSE SOIL BEFORE POURING CONCRETE.
- 22. WELDERS SHALL BE CERTIFIED FOR THE TYPE OF WELDING.
- 23. ADEQUATELY BRACE POLE(S) UNTIL CONCRETE HAS SET UP FOR 14 DAYS.
- 24. GROUT UNDER BASE PLATES WITH NON-SHRINK GROUT.
- 25. THIS ENGINEER DOES NOT WARRANT THE ACCURACY OF DIMENSIONS FURNISHED BY OTHERS.
- ALL EXPOSED STEEL SHALL BE PAINTED WITH AN ENAMEL PAINT TO INHIBIT CORROSION.
- 27. THIS DESIGN IS FOR THE INDICATED ADDRESS ONLY, AND SHOULD NOT BE USED AT OTHER LOCATIONS WITHOUT WRITTEN PERMISSION OF THE ENGINEER.
- 28. DESIGN OF DETAILS AND STRUCTURAL MEMBERS NOT SHOWN, BY OTHERS.

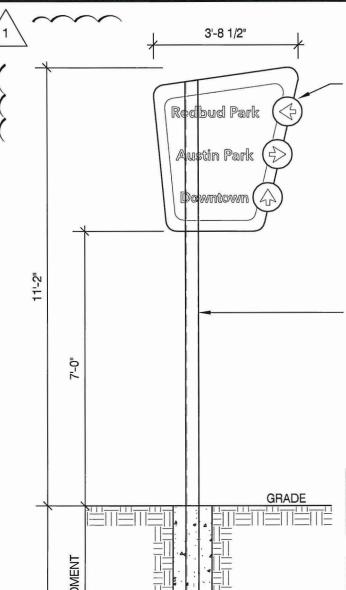

SIGN CABINET AND CONNECTION TO POLE

BY MITCHELL SIGNS

4.500" Ø x .237" WALL STEEL PIPE

WIND DATA

lding Code

Wind Speed, V

Wind Load Criteria

xposure Category

vind Pressure Override per

risdiction Requirement

NOTE

- 1.) SEE MANUFACTURERS DRAWINGS FOR ADDITIONAL DETAILS AND DIMENSIONS
- 2.) SIGN CABINET AND CONNECTION BY MITCHELL SIGNS.
- * CLIENT MITCHELL SIGNS
- * 2022 CALIFORNIA BUILDING CODE
- * RISK CATEGORY II
- * 100 MPH WIND SPEED, EXP. C
- * (1) POLE, (1) FOOTING

DEFLECTION ANALYSIS

Notes: (1) Loading values in chart below are based upon average K, values for each segment. Actual values are calculated on hidden sheet using derived V-M equations. Chart is provided for information purposes only.
 (2) Wind directionality (K ₂) factor is 0.95 for Single Pole (Round) segments instead of 0.85. The C₁ value from Fig. 6-21 has been increased by 0.95/0.85 to account for this variation.

0.005

2.95 Hz

0.85

| No. of Poles | 1 | No. of Footings | 1 | Height | Width | Horiz. Offset | ft | ft | sq ft | ft | ft | sq ft | 1.17 ft | 1.1

Damping Ratio, B

Natural Frequency, n₁

Gust Effect Factor, G

SUPPORT	POLE DESIGN SUMM	ARY M	ATERIAL =	ST	EEL												
Base Elev		Requi	Required Strength Values (ASD)			Allowable Strength Values (ASD)				Unity Ratios				Interaction Ratios			
Base Elev	Section	Axis	V,	Mr	T,	P,	Vc	M _c	T,	P _c	V./V.	M,/M,	т./т.	P,/P,	P-M	P-M-V-T	Status
ft			kips	kip-ft	kip-ft	kips	kips	kip-ft	kip-ft	kips	V _r /V _c	IAI ^c \IAI ^c	1416	P,/Pc	P-IVI	P-IVI-V-1	
0.00	HSS4.500X.237	Strong	0.3	2.5	0.2	0.3	24.9	8.4	7.6	14.3	1.2%	29.1%	2.6%	1.9%	31.0%	0.0%	4
FOUNDAT	ION DESIGN SUMMA	RY															
	Turns Di	ameter Width	Thickness	Length	Depth	Volume			Dains	ossing.			Con	****	Allowa	able Soil	

Type Diameter Width Thickness Length Depth Volume Reinforcing Status Allowable Soil Pressure

Caisson 1.00 -- - - 5.50 0.16

Reinforcing OK 200 psf/ft

FRONT ELEVATION W/ CAISSON FOUNDATION

1'-0" Ø

__(1



MBI COMPANIES INC.

299 N. WEISGARBER RD. KNOXVILLE, TN 37919

PHONE 865.584.0999 SIGN-ENGINEER.COM PROJECT: 14050 OLYMPIC DRIVE, CLEARLAKE, CA 95422

SCALE: N.T.S.

DRAWN BY:

JBN COMM. NO.

240157.001

2022 California Stat Importance Factor, I

Directionality Factor, K, (2)

Topography Factor, K.,

Base Pressure, ylq./K,

0.85

ASCE 7-16

100 mph

57.001 03/06/24

DATE:

REV #1

DWG.

DRAWING NO.

C-68628

Exp. Date CIVIL

CITY OF CLEAR LAKE

DRAWING TITLE:

DATE DRAWN BY
04/03/24 CTP